

# Fairbanks Regional Public Health Center

for the City of Fairbanks, Alaska



Architect

Civil, Mechanical and Electrical Engineer

Structural Engineer

Geotechnical Engineer

Livingston Slone, Inc.

FPE/Roen Engineers, Inc.

Loftus & Dailey, Inc.

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**RECORD  
DRAWING**

*R.L. Bent*  
CITY ENGINEER, CITY OF FAIRBANKS


9/8/96

DATE


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## STATE MAP



## VICINITY MAP

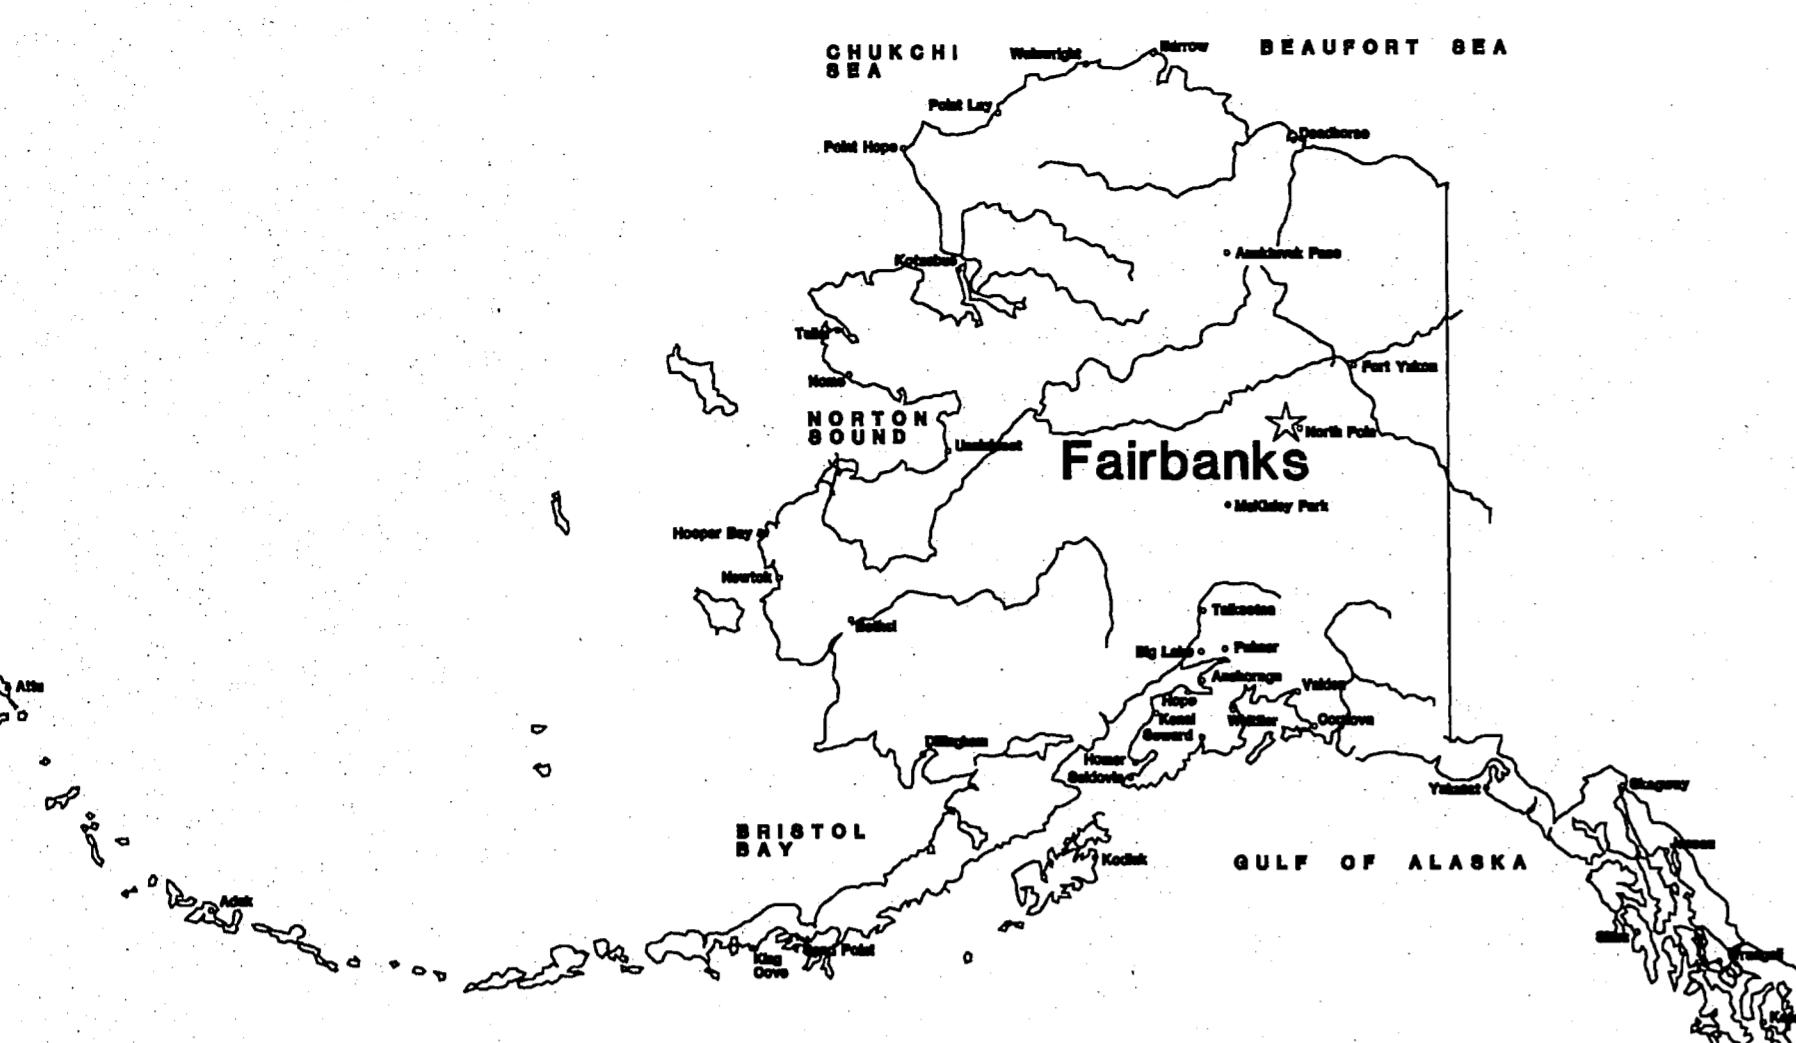

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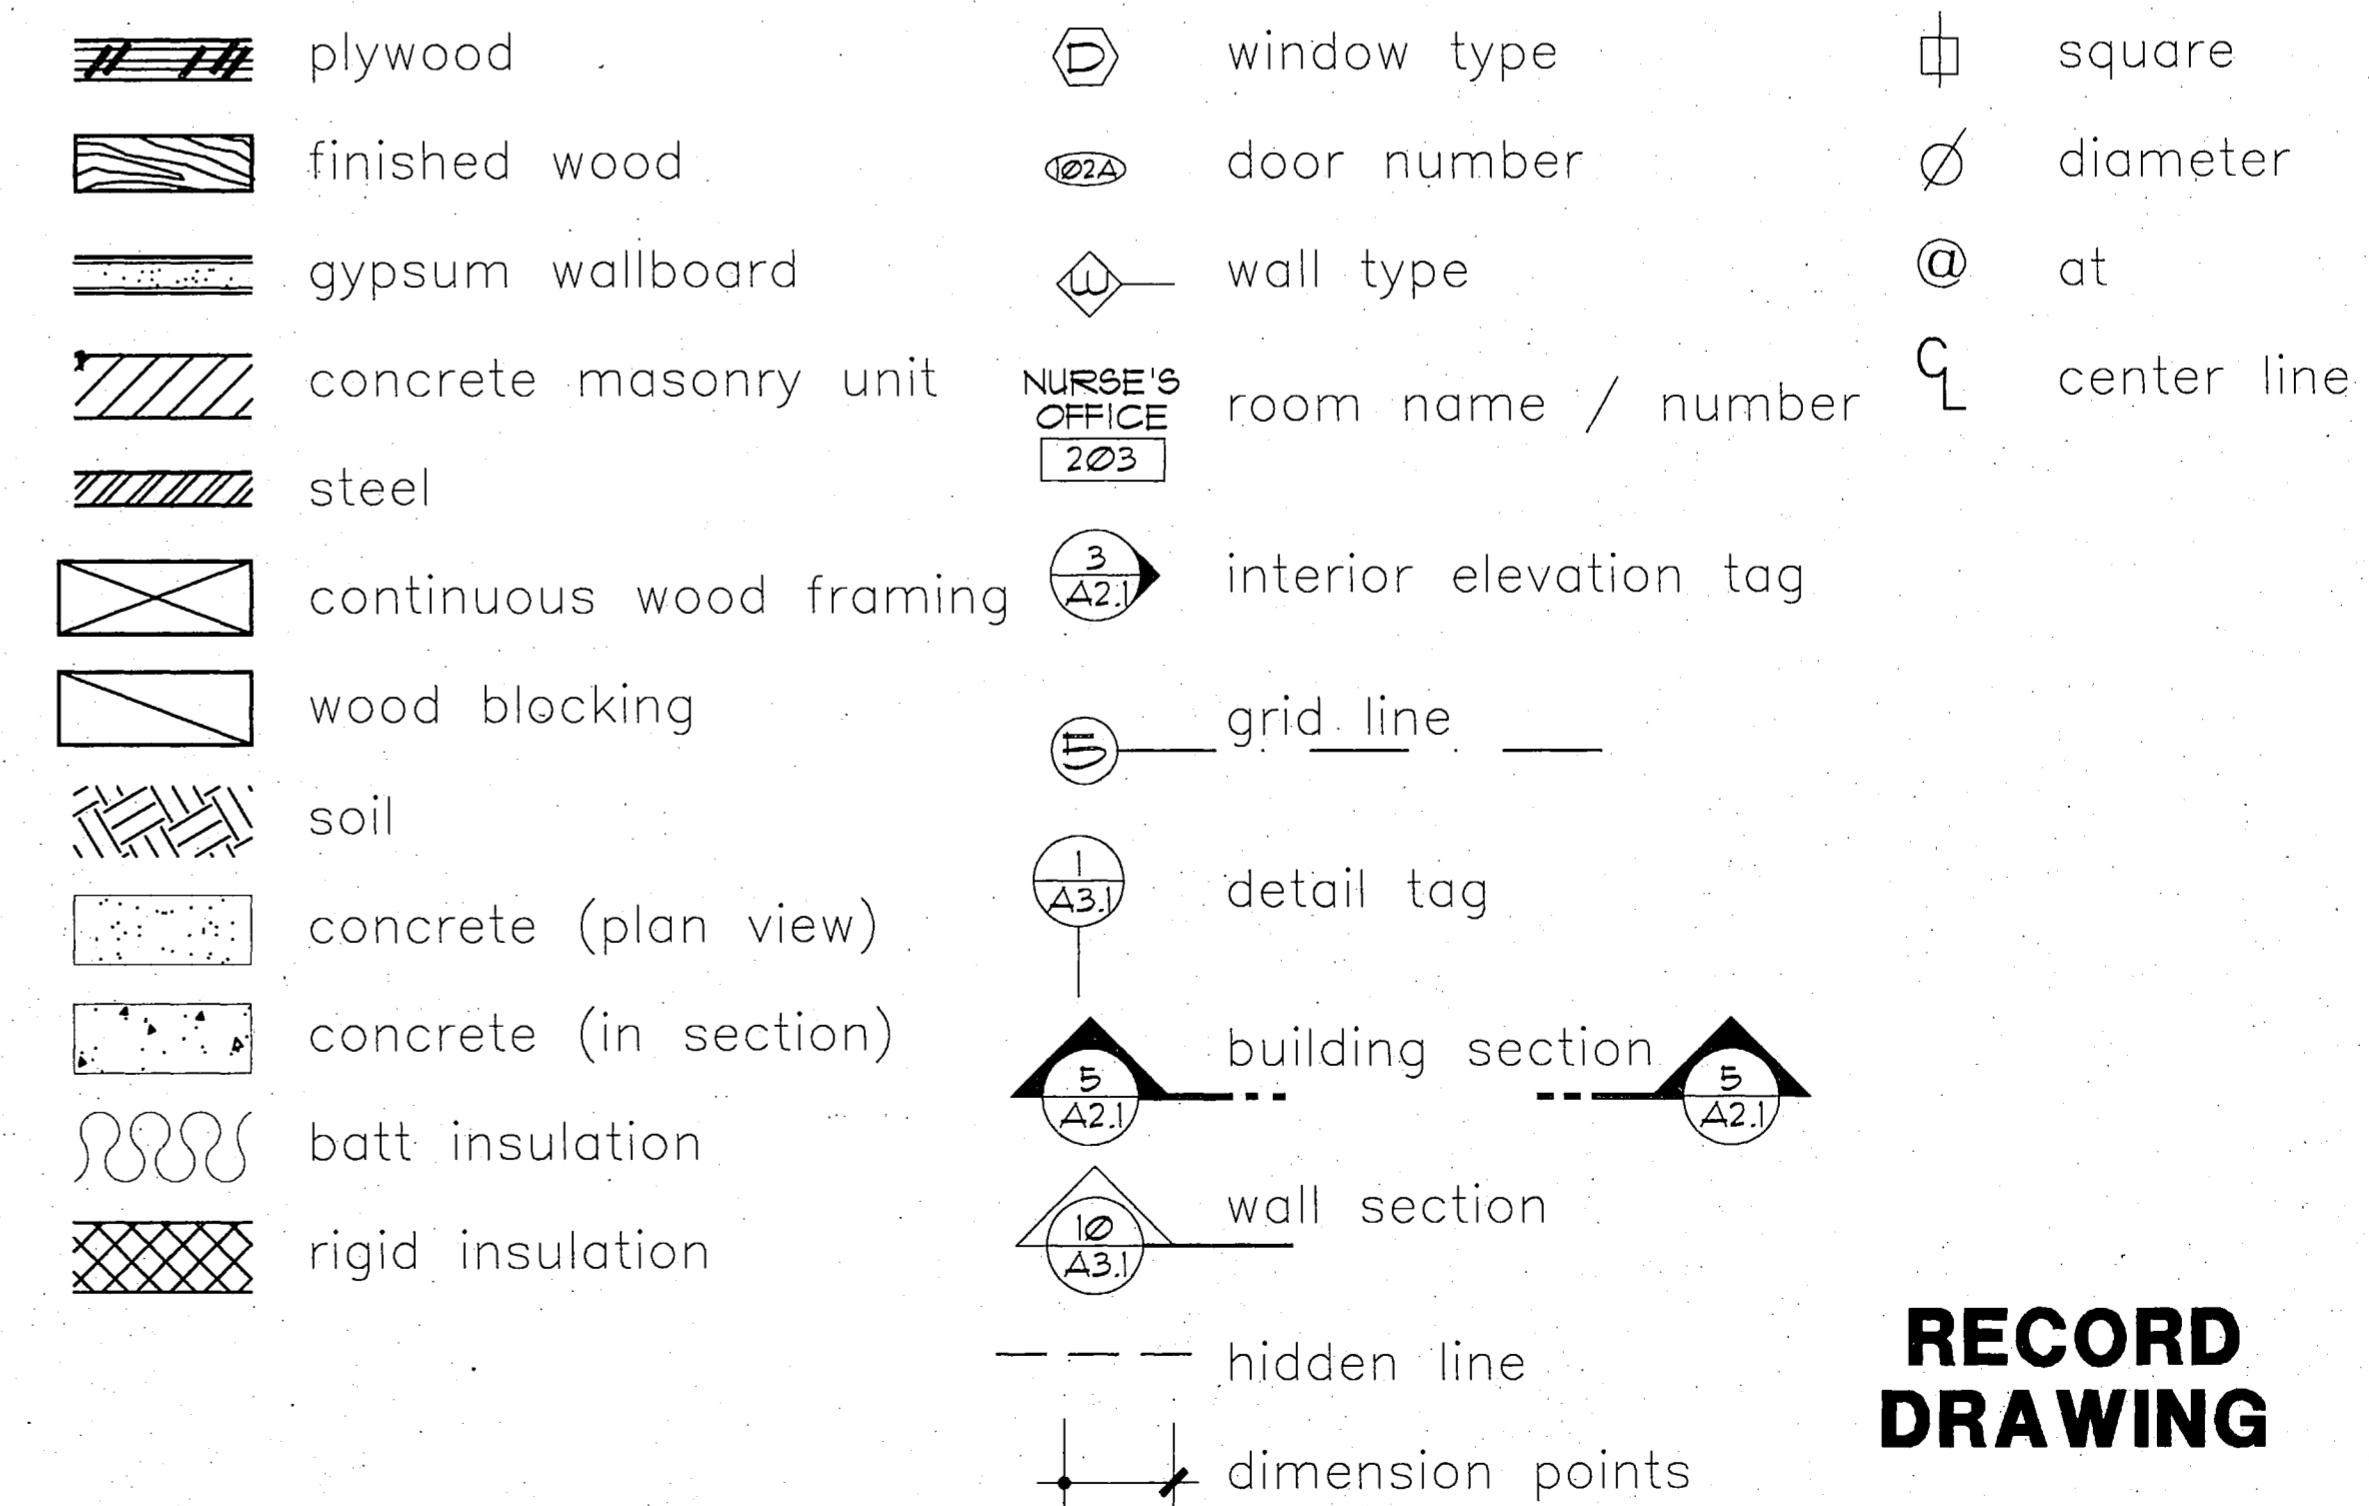
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## GENERAL NOTES
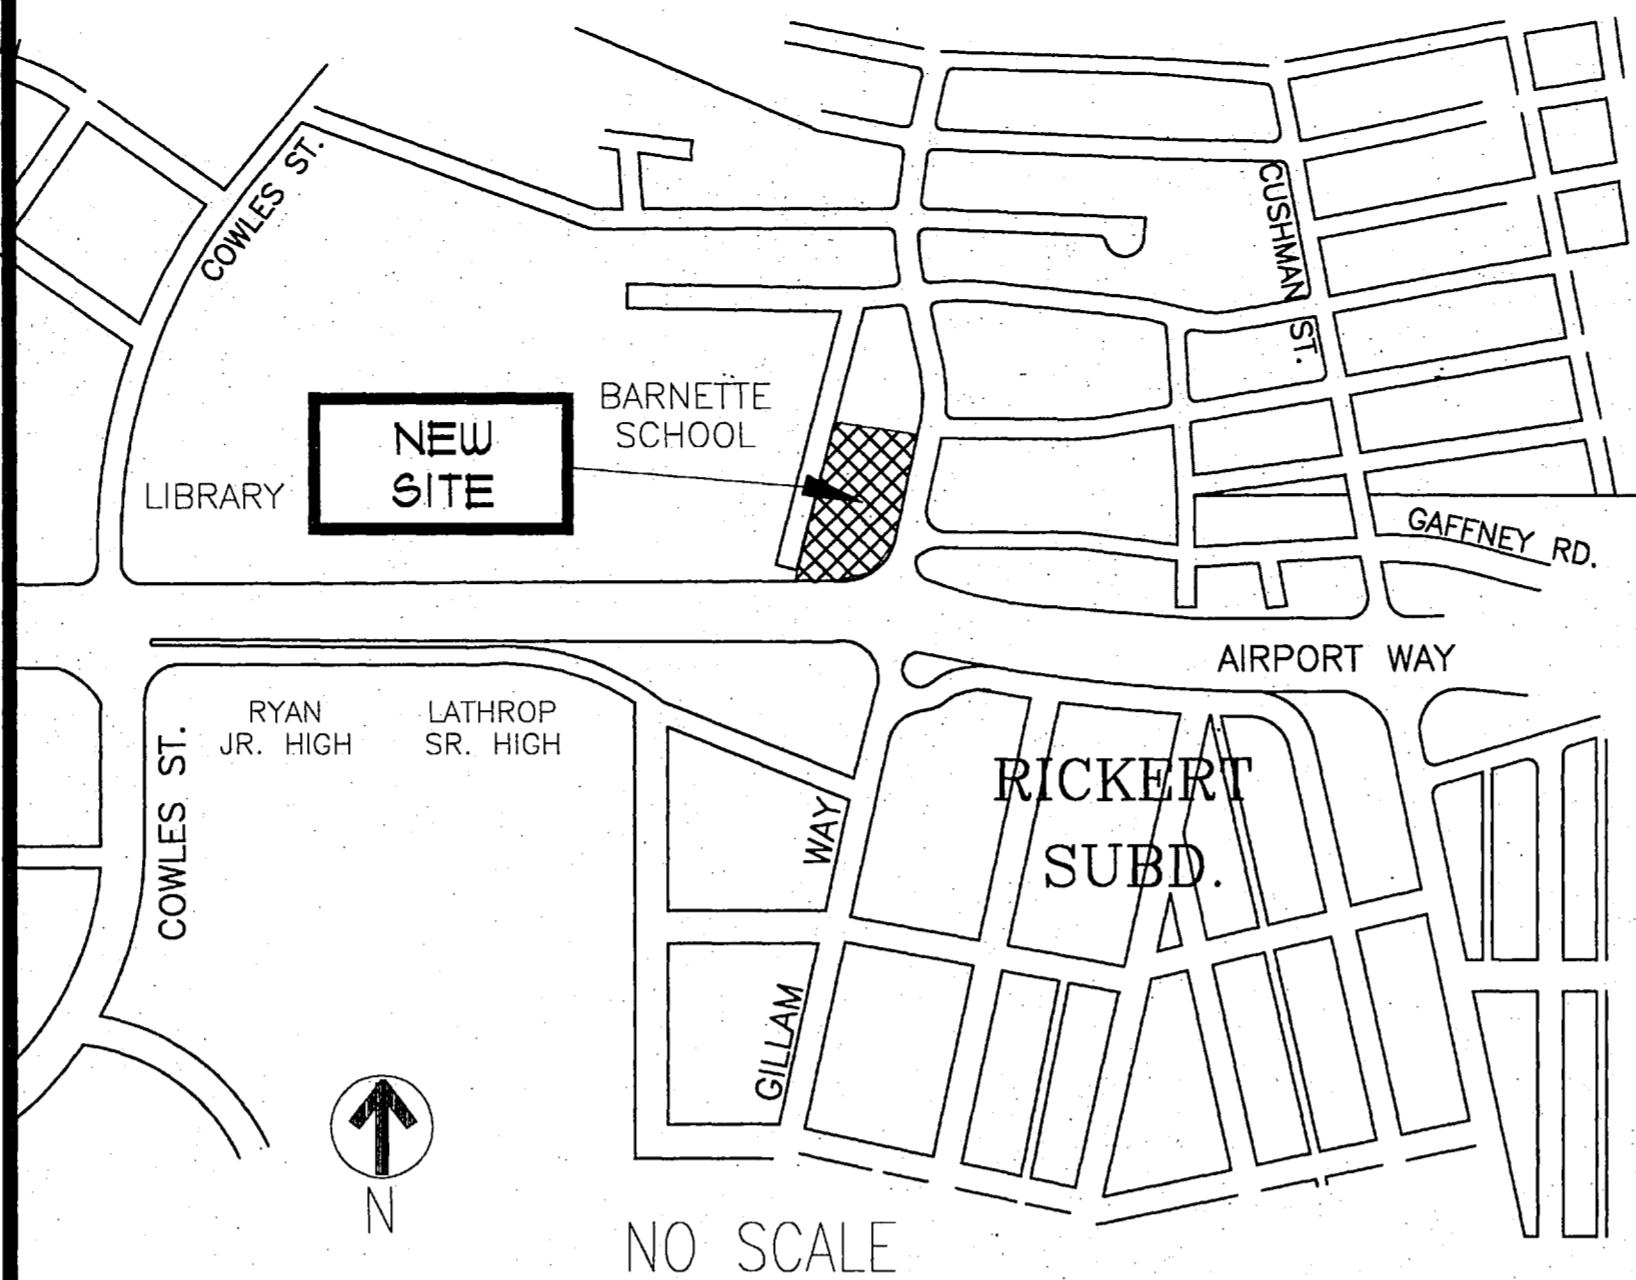
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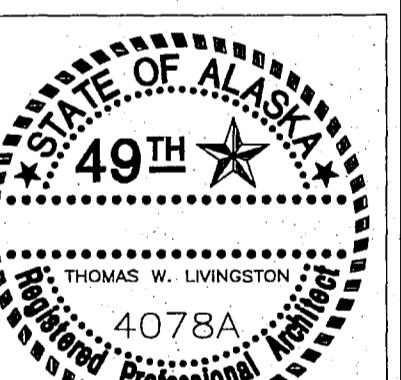


## RECORD DRAWING

Rober B. Bland  
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4/18/96  
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PROJECT NO. 115.00

DRAWN BY AS, JB

CHECKED BY JB

DATE DEC 9, 1992

REVISED

TITLE  
MAPS, INDEX,  
ABBREVIATIONS,  
GEN. NOTES


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City of Fairbanks

FAIRBANKS HEALTH CENTER  
Fairbanks, Alaska



## RECORD DRAWING

Rufus B. Burney  
CITY ENGINEER, CITY OF FAIRBANKS

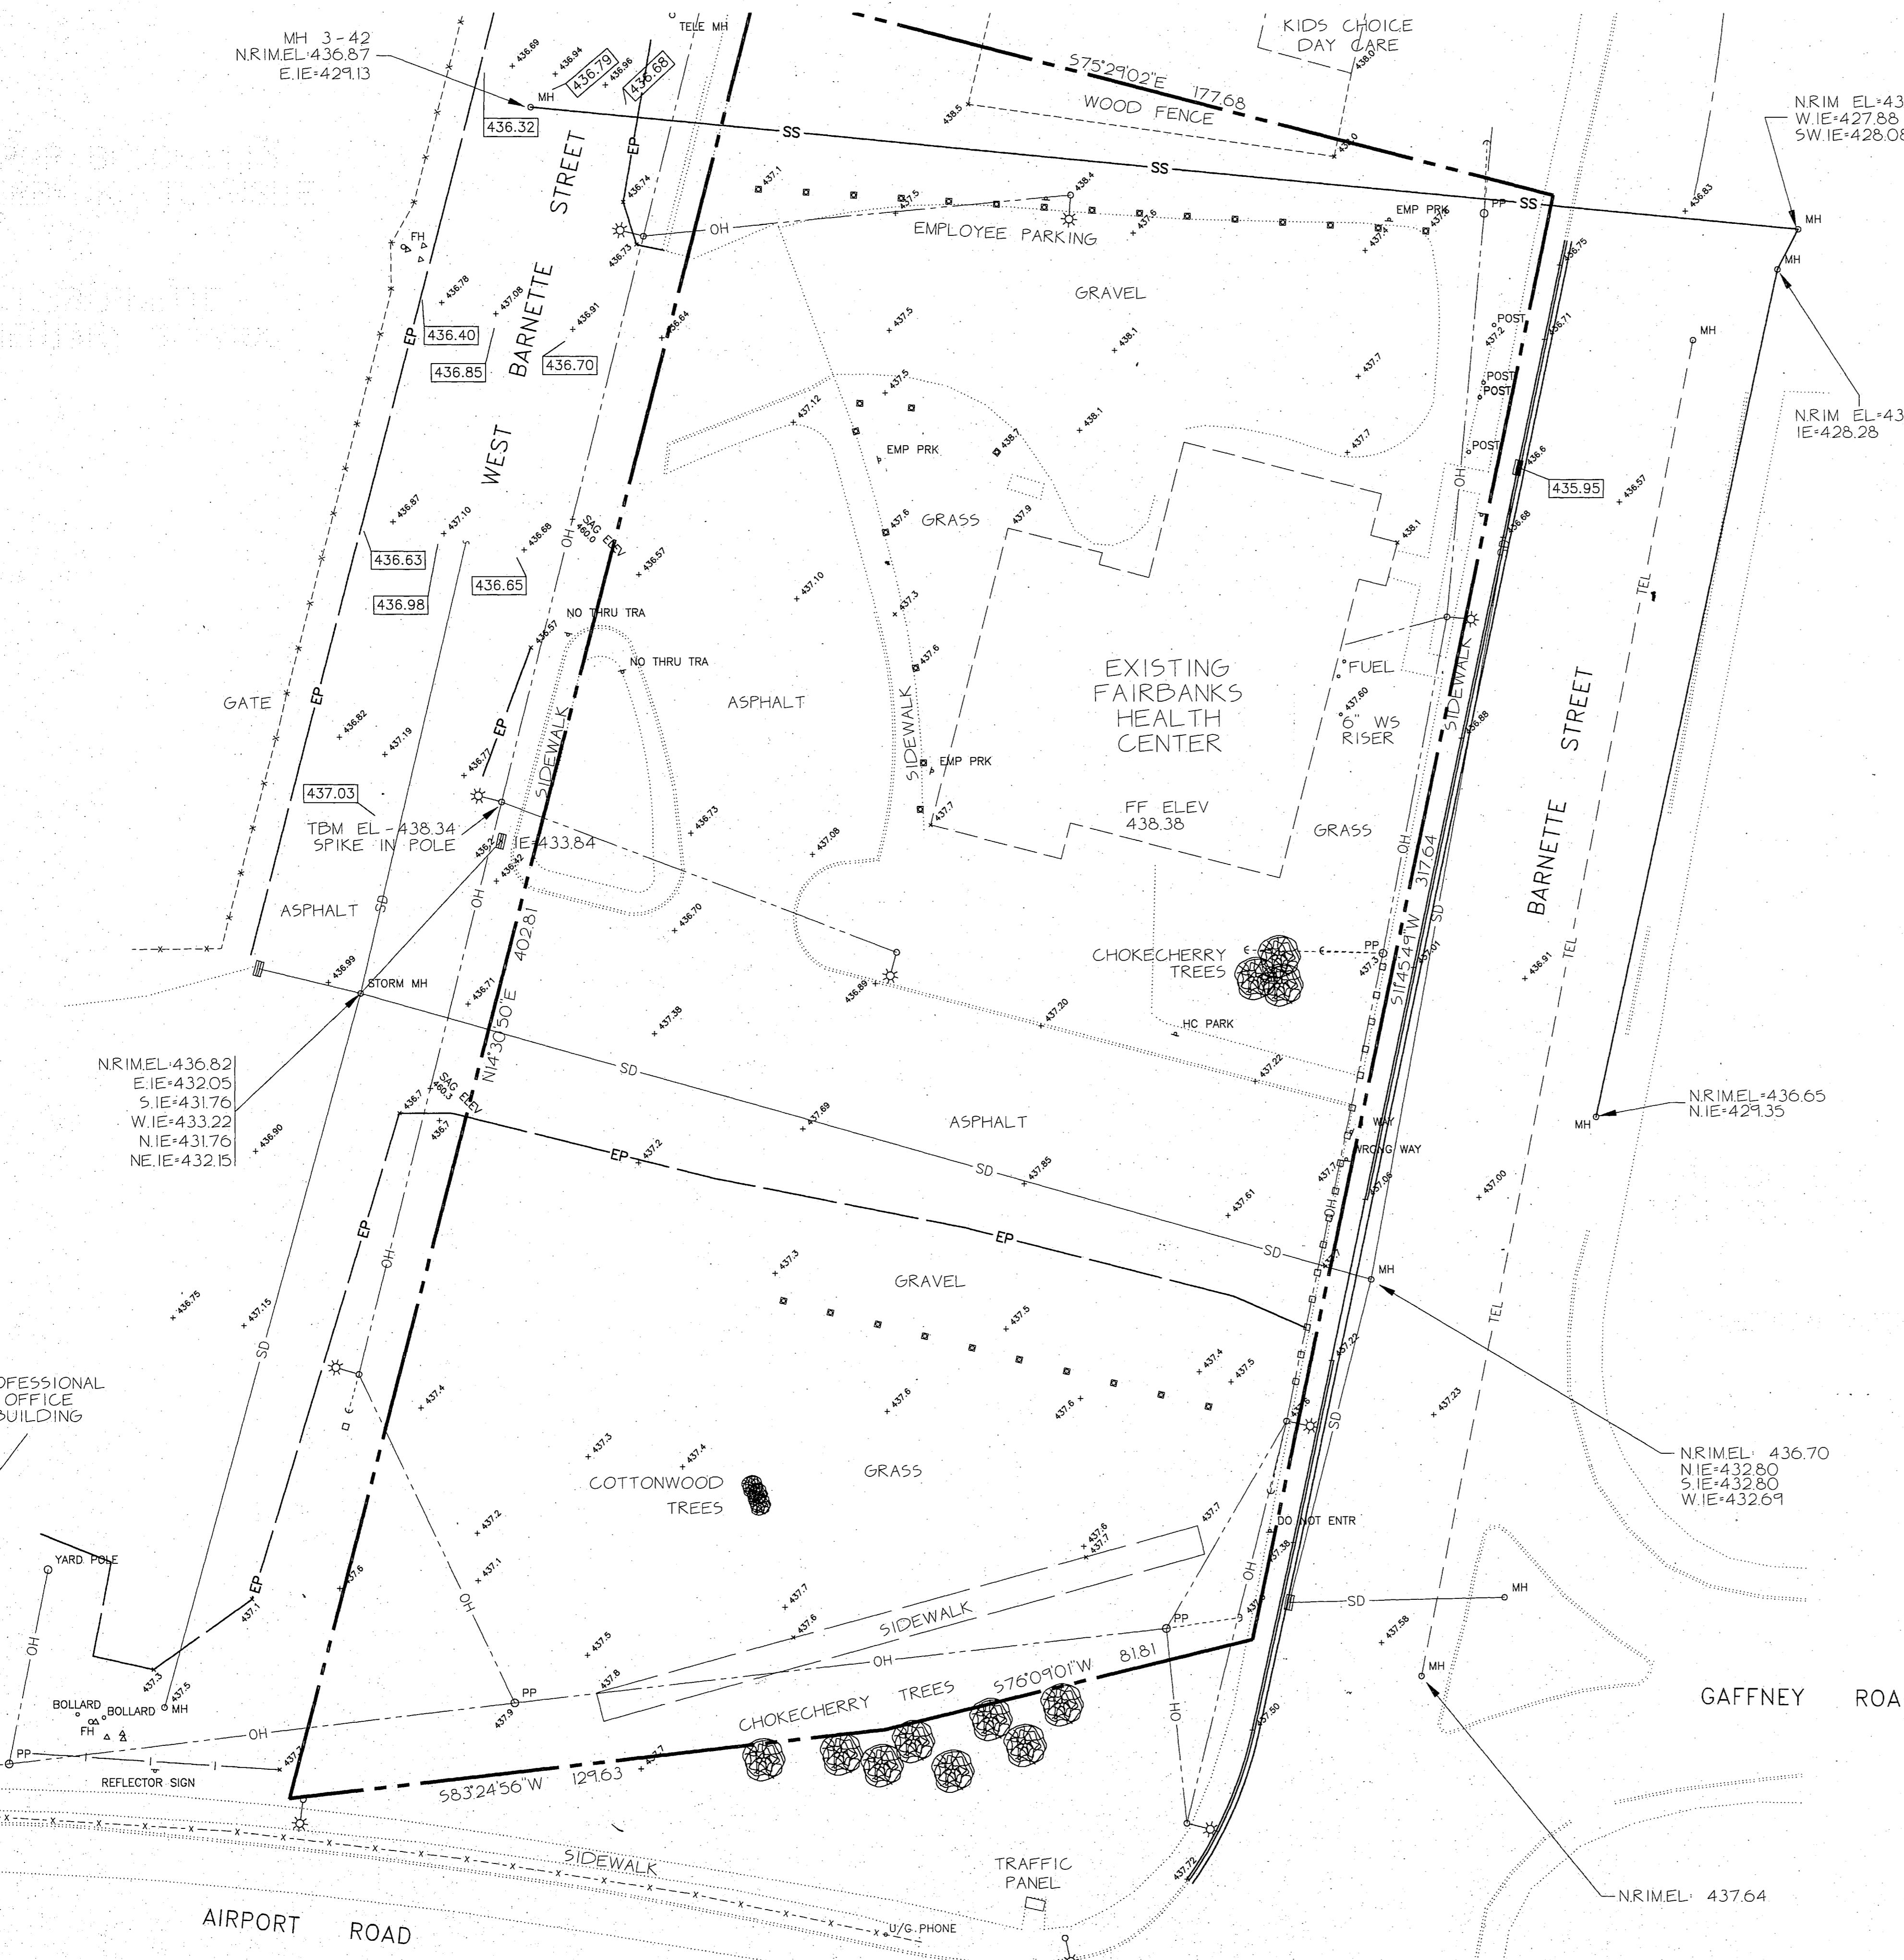1/18/93

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Fairbanks, Alaska

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TOPOGRAPHIC SURVEY

SHEET NO.

**S1.0**

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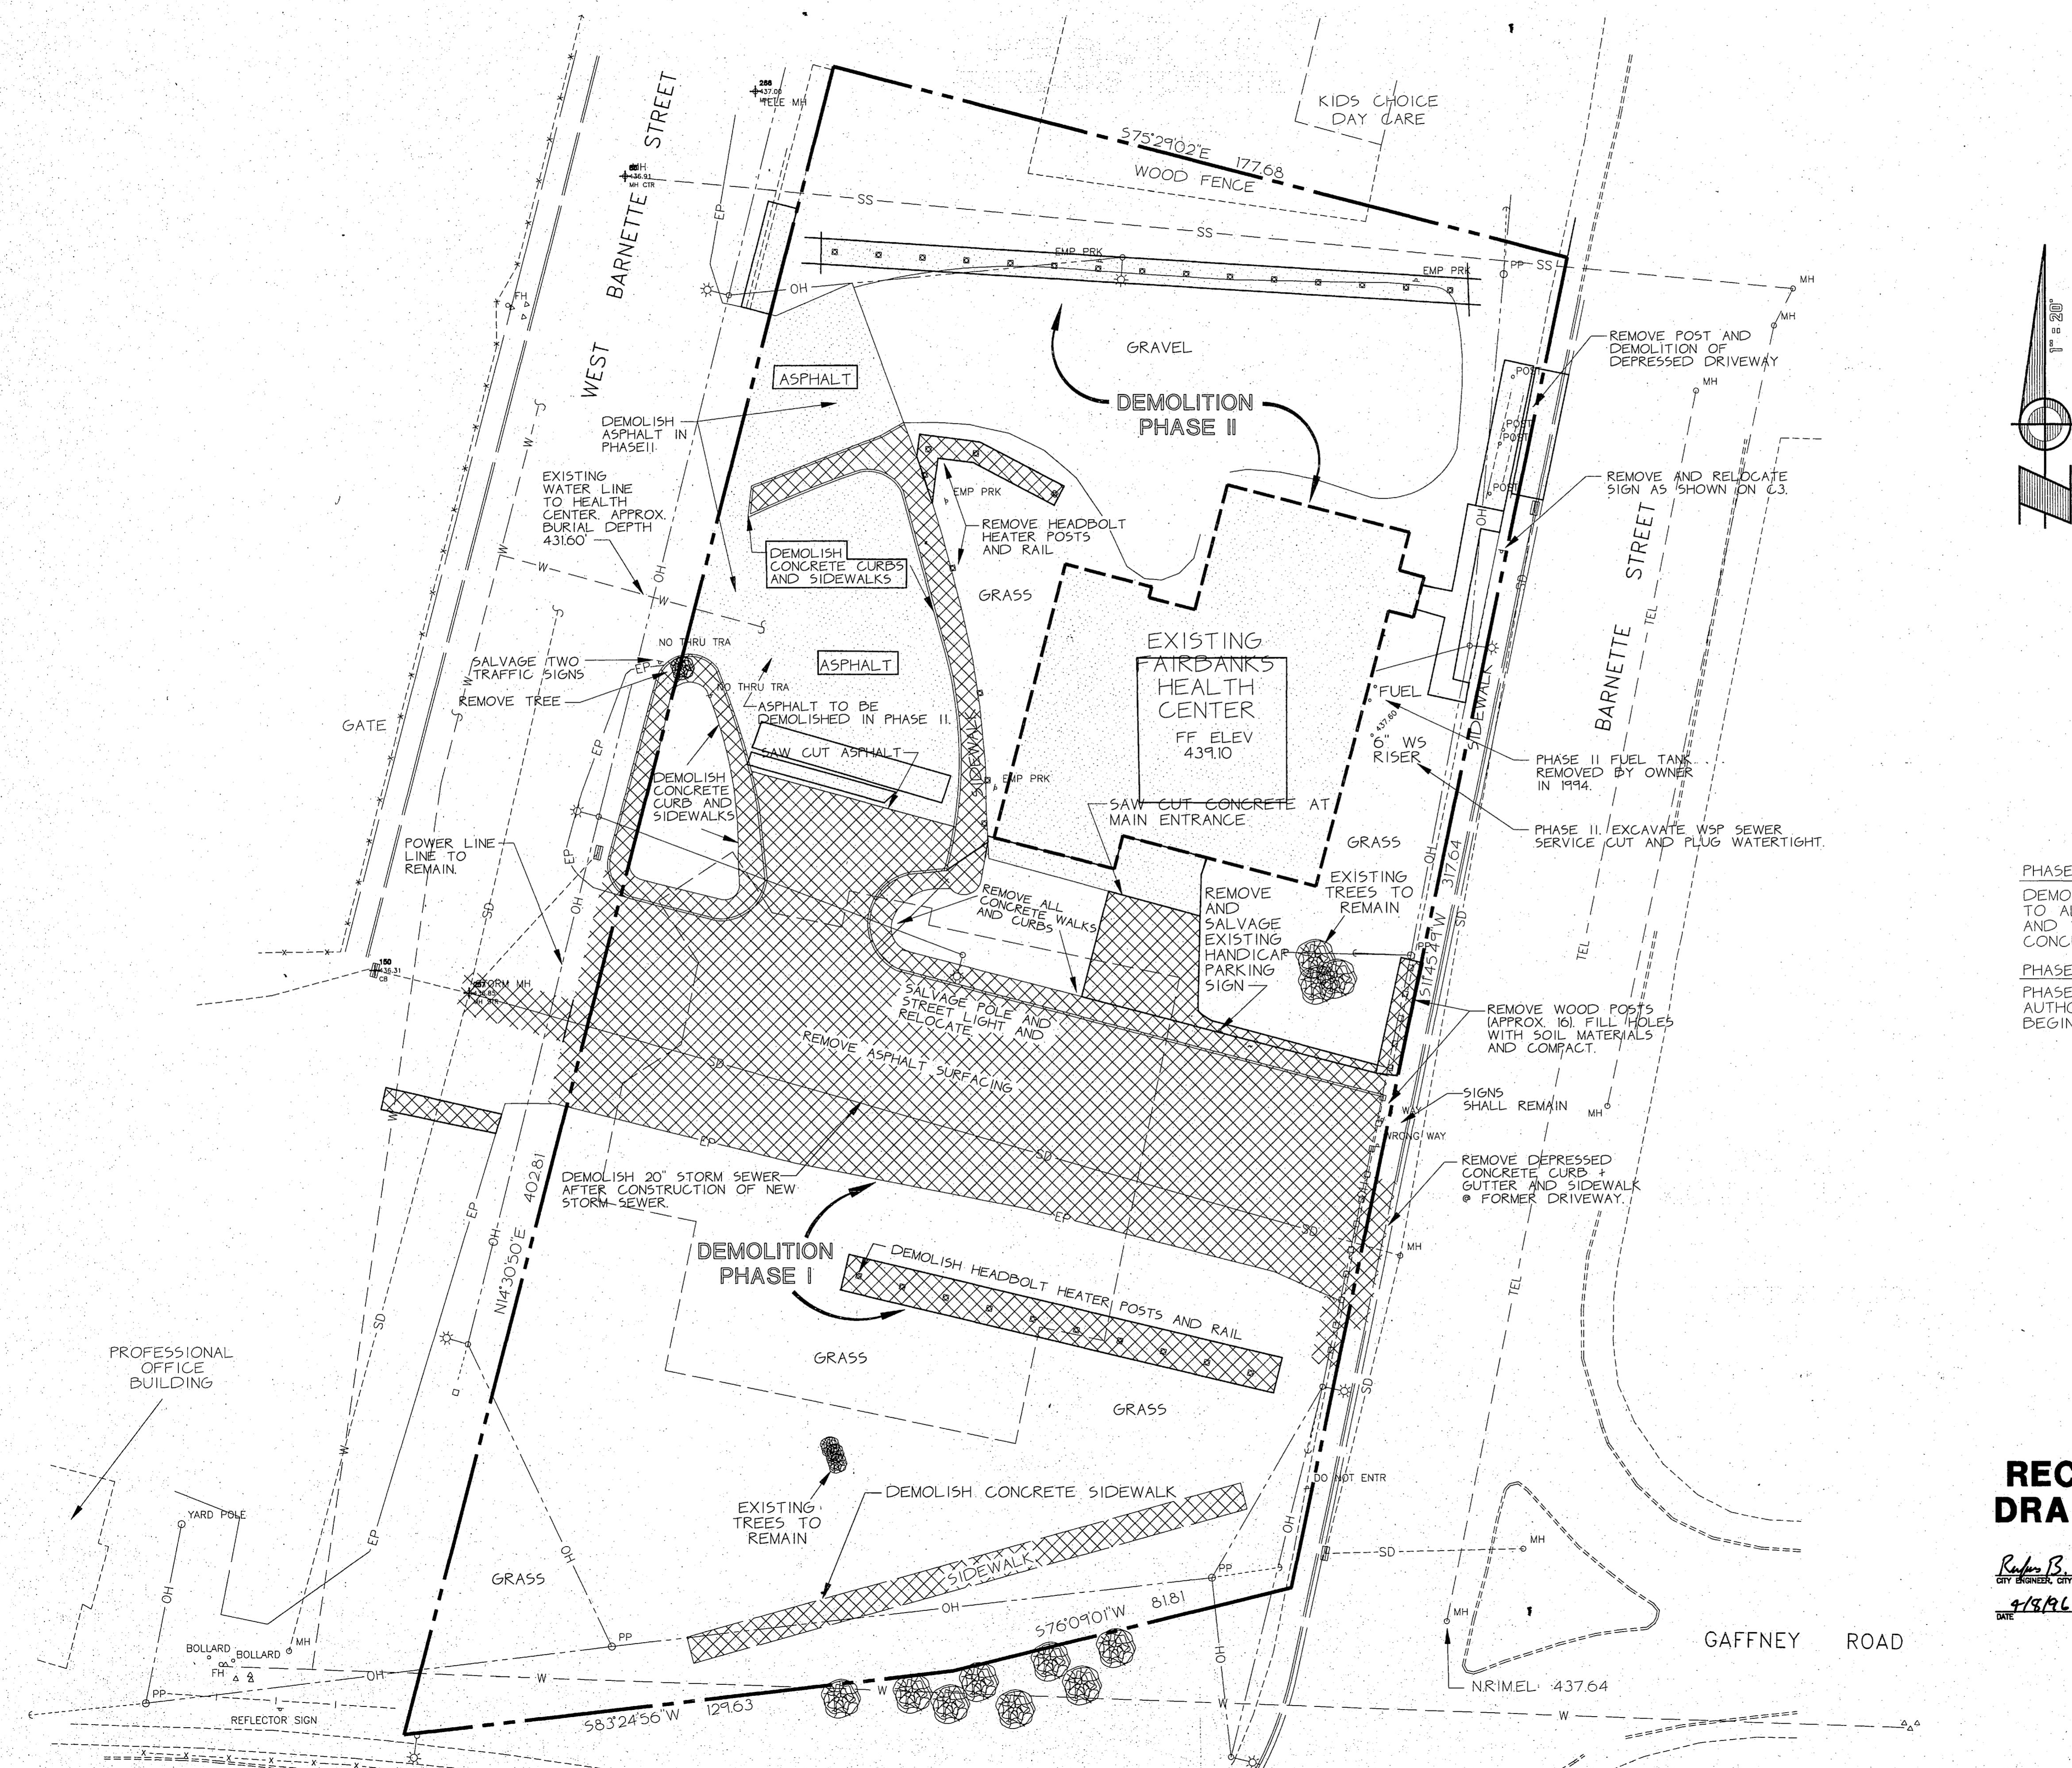
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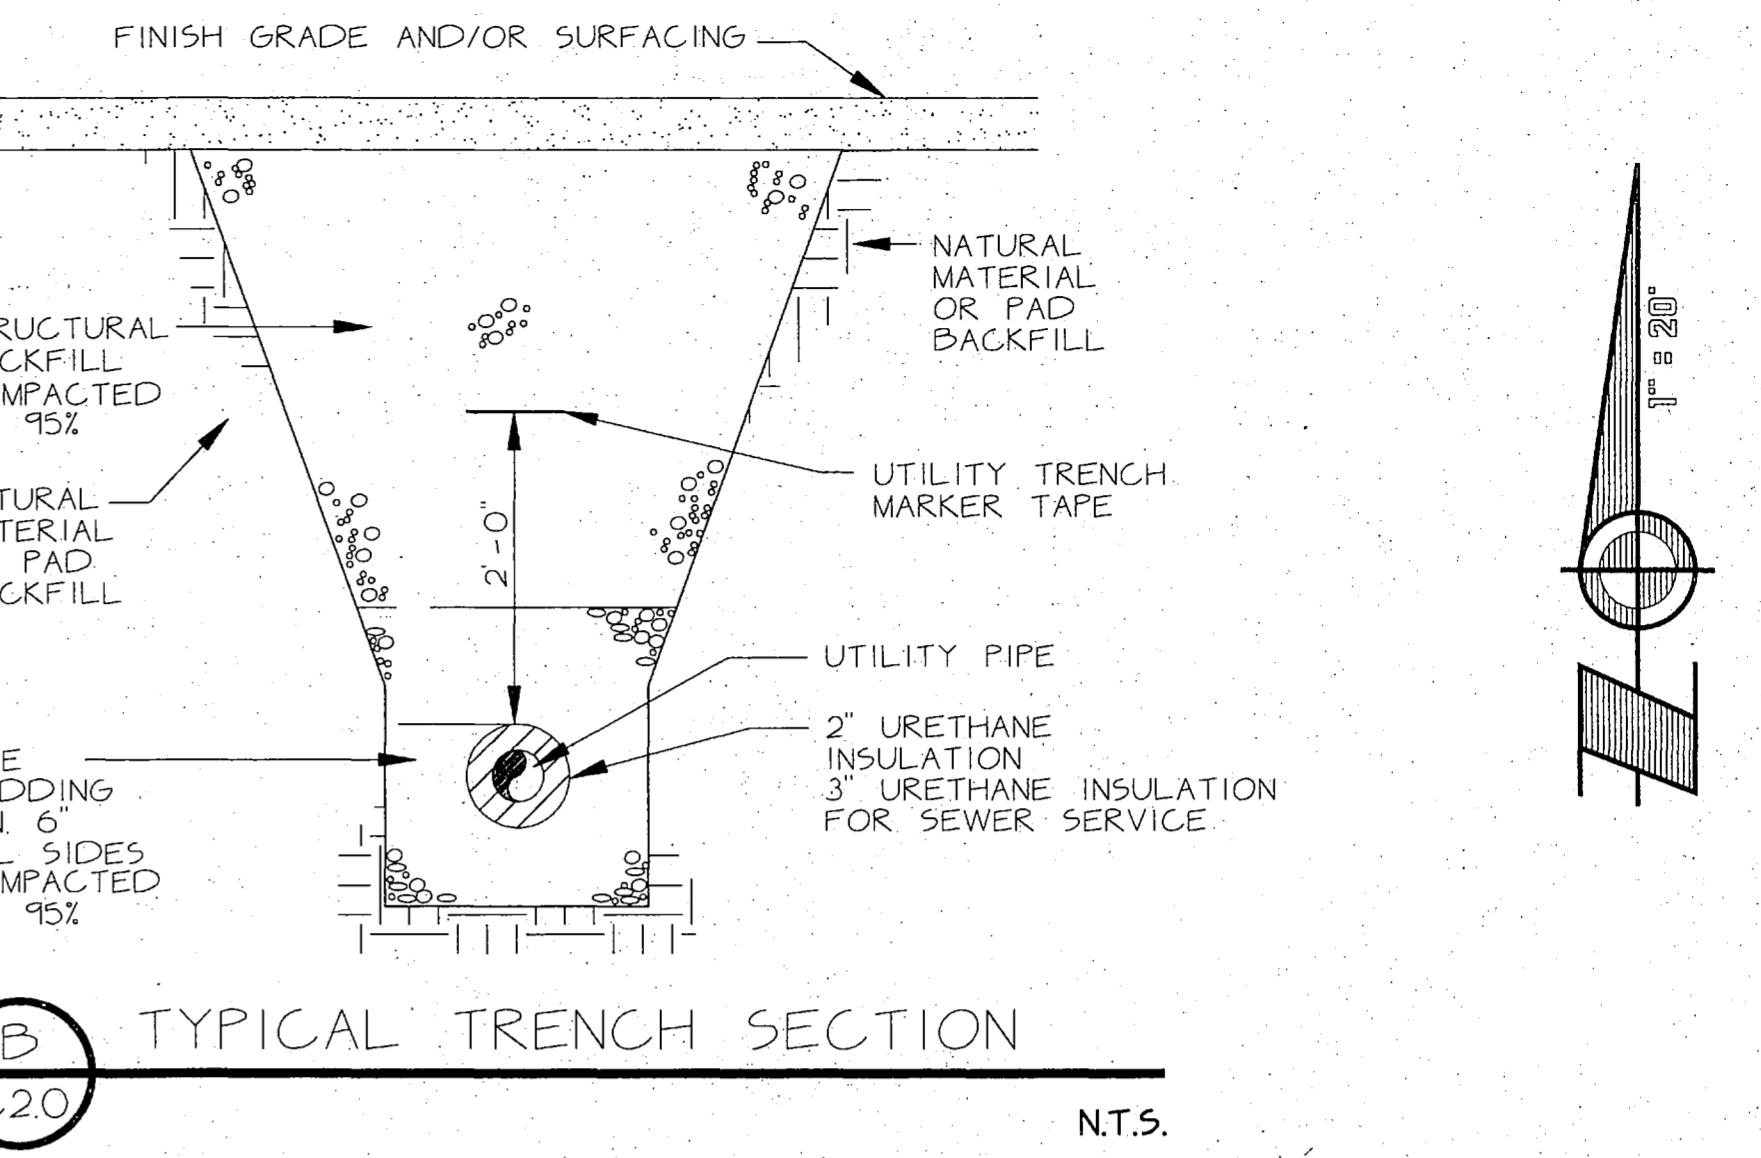
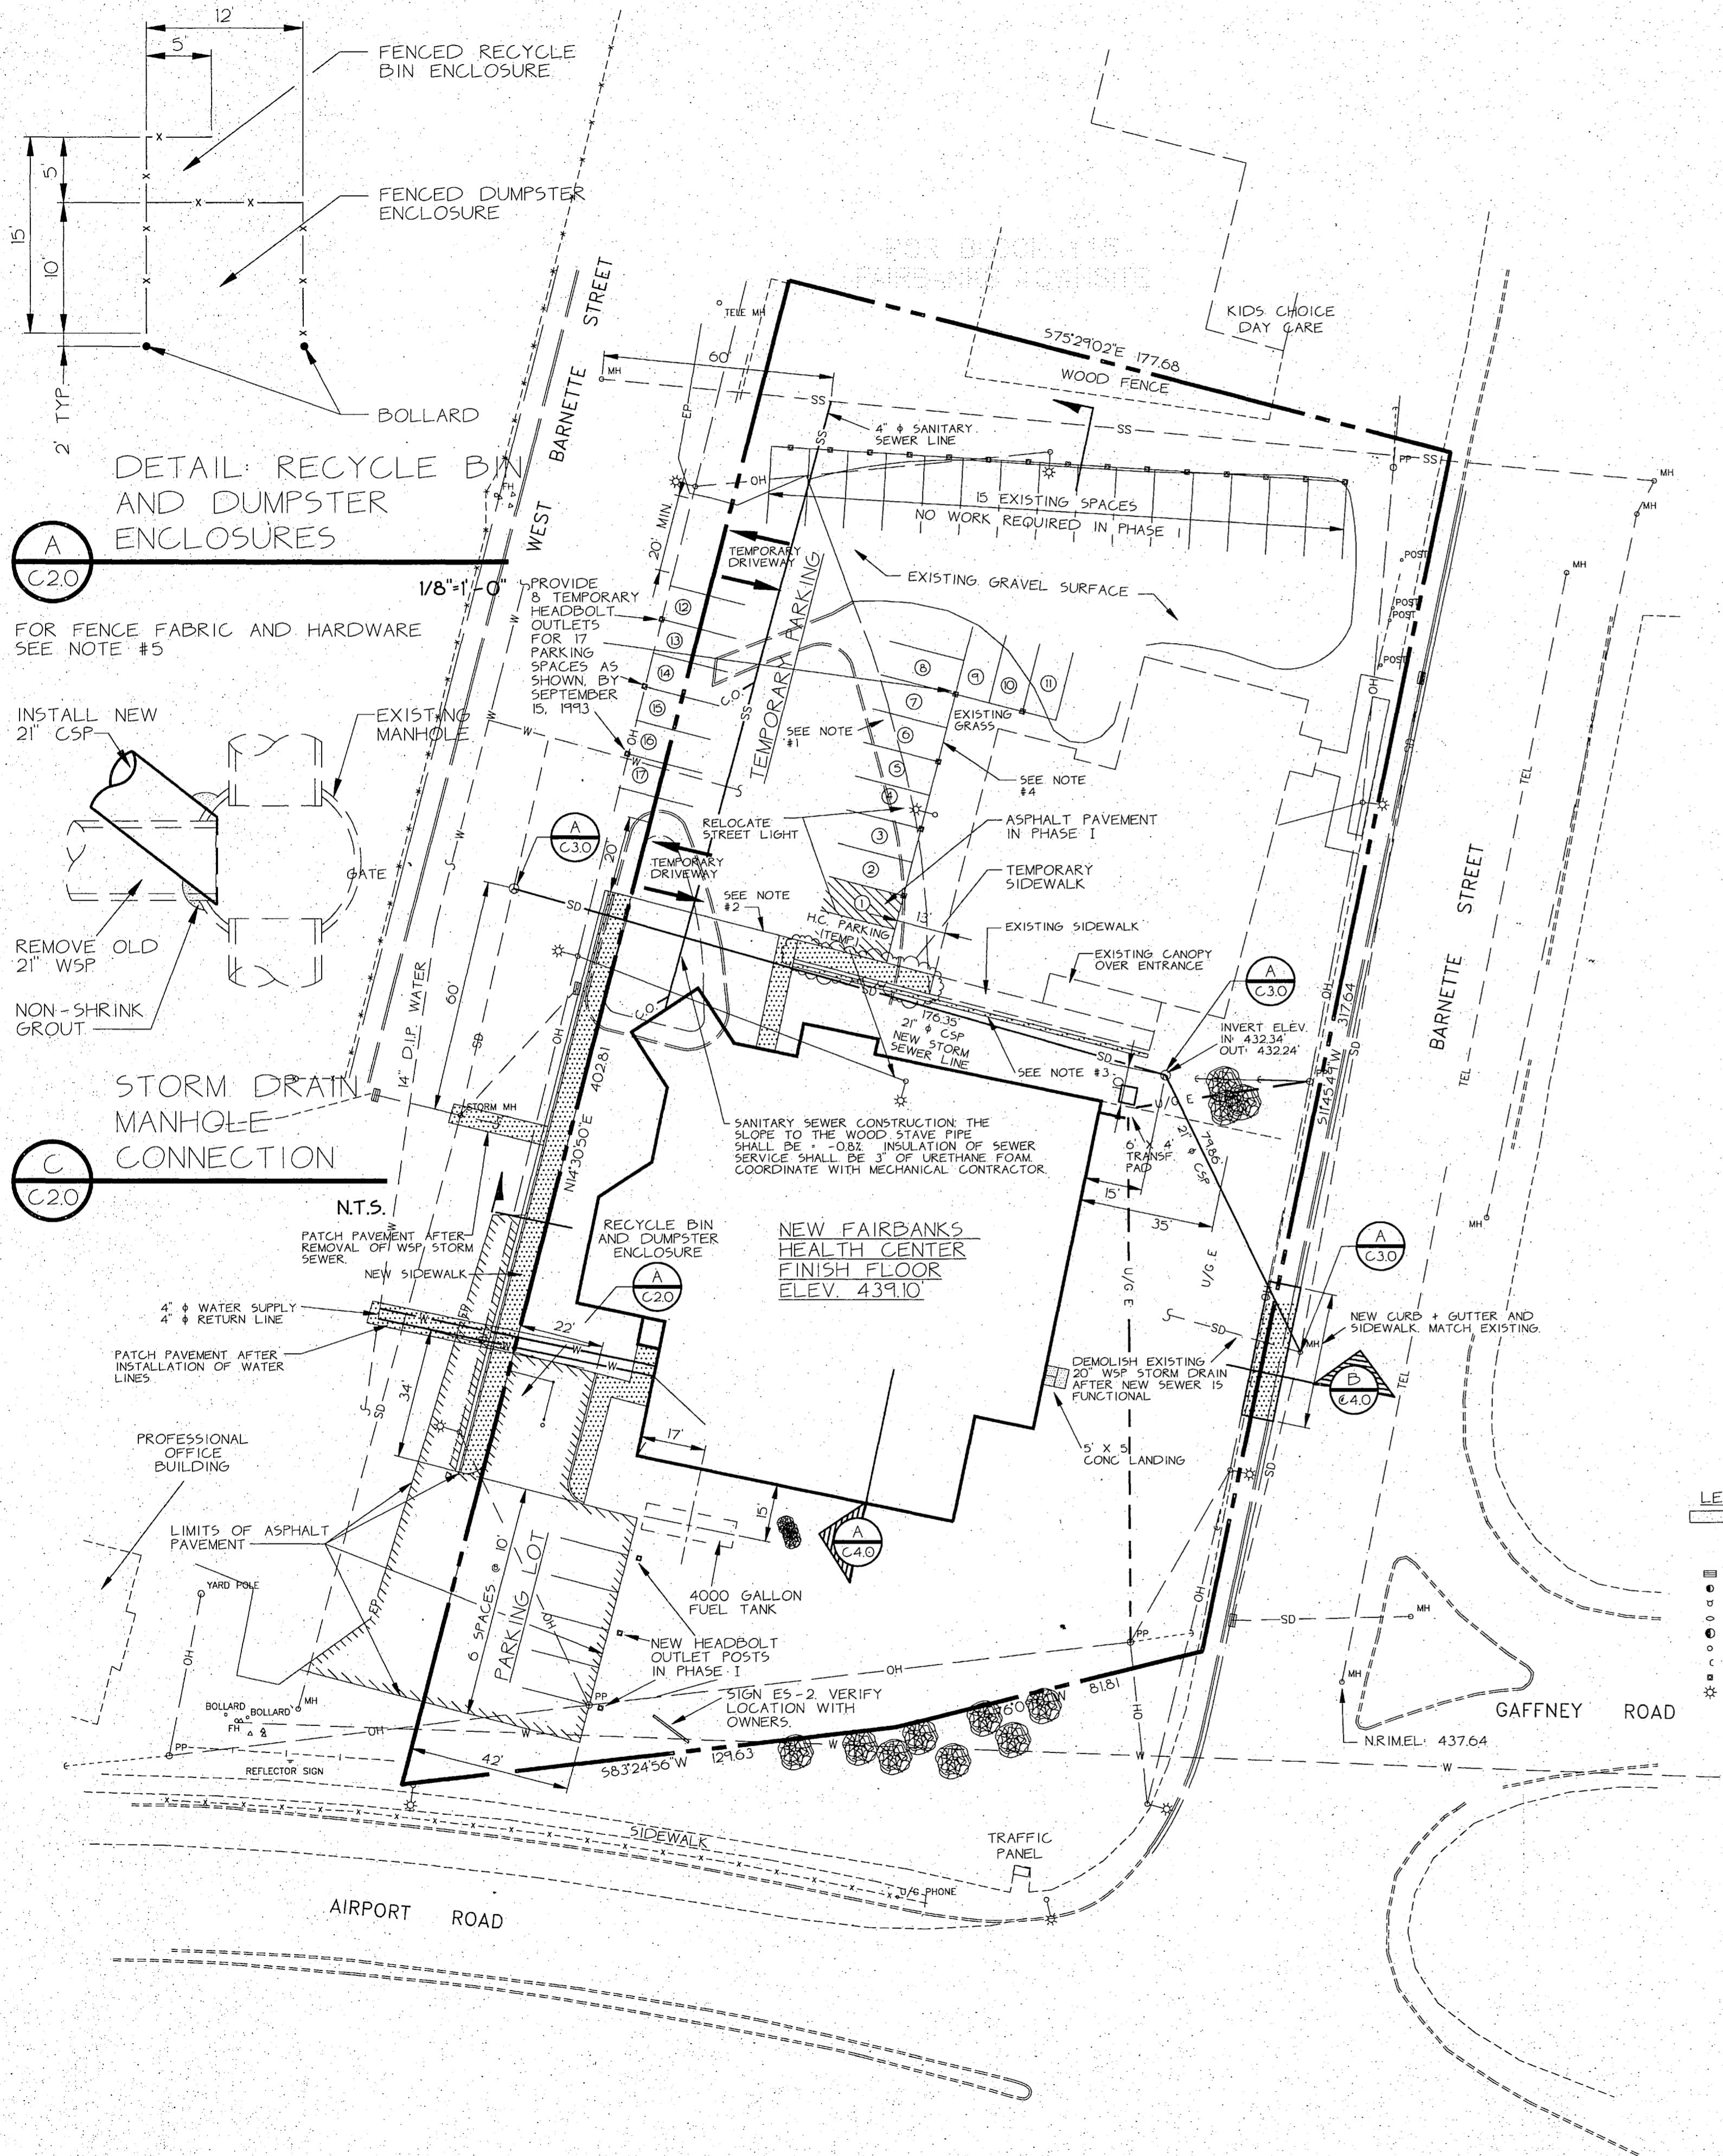
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TITLE  
**CONSTRUCTION PHASE I SITE PLAN**  
SHEET NO.

**C 2.0**

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## NOTES

- AT TEMPORARY PARKING SPACES 1 THROUGH 11 INCLUDING H.C. SPACE, EXCAVATE TO PROVIDE 8" MIN. COMPACTED, WELL GRADED GRAVEL FILL. VOIDS WHERE CONCRETE HAS BEEN REMOVED. GRADE TO DRAIN TO STREET. MAINTAIN ALL TEMPORARY PARKING AREAS ONCE MONTHLY, MIN. TO MAINTAIN GOOD DRAINAGE AND TO FILL POTHOLE AND RUTS.
- SOUTH WALL OF EXISTING BUILDING, EXTENDED TO WEST SHALL BE NORHERLY LIMIT OF PHASE I PERMANENT IMPROVEMENTS.
- CONSTRUCT 95 LF. OF A PROTECTED BARRIER, LOCATION AS SHOWN. PROVIDE ROOF OVER WALKWAY WHERE ADJACENT TO EXISTING BUILDING AND CANOPY. CONSTRUCT IMMEDIATELY AFTER INSTALLING NEW STORM SEWER. PROTECTED WALKWAY SHALL WITHSTAND 20 PSI WIND LOAD, 45# SNOW LOAD AND SHALL HAVE TEMP. LIGHTING. BARRIER SHALL BE SELF SUPPORTING, PROVIDING VISUAL SCREEN, SOUND BARRIER, WEATHER PROTECTION, AND PROTECTION FROM CONSTRUCTION OPERATIONS. 3/4 INCH PLYWOOD OR EQUIVALENT MATERIAL. SUBMIT DESIGN TO OWNER FOR APPROVAL PRIOR TO CONSTRUCTION.
- LIMIT OF GRAVEL SURFACE FOR TEMPORARY PARKING. PROVIDE 8" MINIMUM STRUCTURAL FILL FOR TEMPORARY DRIVING SURFACES.
- PROVIDE 6 FT. HIGH CHAIN LINE FENCE FOR DUMPSTER AND RECYCLE CONTAINER ENCLOSURES. FABRIC: 9 GA. DIAMOND MESH, ZINC COATED STEEL POSTS SHALL BE 2" GALV. STEEL, CENTERED IN AUGERED HOLE 12 INCH DIAM. BY 3 FT. DEEP AND FILLED WITH CONCRETE. PROVIDE POST TOPS. TOP RAIL SHALL BE STANDARD SCHED. 40 GALV. STEEL PIPE. TENSION WIRE AT BOTTOM SHALL BE 7 GA. PROVIDE BRACES BETWEEN END AND CORNER POSTS. ALL AROUND INSTALL GROUND ROD 1/2 INCH X 8 FT. LONG WITH SUITABLE CONNECTION TO FABRIC. PROVIDE AND INSTALL VINYL SLATS FOR VERTICAL INSTALLATION THROUGH FABRIC. ALL FENCING FOR BOTH ENCLOSURES. COLOR OF VINYL MATERIALS TO BE APPROVED BY OWNER.
- IF EXISTING SIDEWALK ADJACENT TO BUILDING MUST BE DEMOLISHED DURING STORM SEWER CONSTRUCTION, REMOVE AND REPLACE WITH NEW FIVE FOOT WIDE TEMPORARY CONCRETE SIDEWALK.
- USE PROPERTY CORNERS FOR HORIZONTAL CONTROL. PROPERTY CORNERS SET BY OWNER.
- FOR FUEL TANK INSTALLATION: PROVIDE 8" THICK BY 20 FT. BY 9 FT. WIDE CONCRETE HOLD DOWN PAD, WITH #5 BARS AT 12" EACH WAY. PROVIDE 6" MINIMUM OF FINE SAND FOR TANK BEDDING, PLACE AS SAND SLURRY TO FIRMLY BED 120 DEGREES OF TANK BOTTOM. ANCHOR BOLTS SHALL BE 1" DIAMETER, HOOKED TO REINFORCING STEEL IN SLAB. PROVIDE HOLDDOWN STRAPS PER MANUFACTURER'S RECOMMENDATIONS, MINIMUM OF TWO, WITH 7/8" DIA. STEEL HOLDDOWN RODS, OR EQUIVALENT STRAP, AND SECURE TO ANCHOR BOLTS WITH TURNBUCKLES. COAT EXPOSED METAL SURFACES WITH DIELECTRIC MATERIAL. INSULATE THE HOLDDOWN STRAPS FROM THE TANK SHELL WITH 1/4" X (STRAP WIDTH PLUS 1 1/2") MATERIAL APPROVED FOR STI-P3 INSTALLATION. TOP OF TANK SHELL SHALL BE 25 FEET BELOW SURFACE GRADE.
- BOLLARDS, LOCATED AT DUMPSTER ENCLOSURE, SHALL BE 6" SCHEDULE 40 STEEL PIPE FILLED WITH CONCRETE WITH DOMED CONCRETE SURFACE. SET PIPE IN AUGERED 16" DIAMETER HOLE; FILL HOLE WITH CONCRETE, DOME SURFACE AT FINISH GRADE. EMBED 4 FT. IN GROUND, WITH 3 FT EXPOSED ABOVE GRADE. PAINT PIPE AND CONCRETE TO MATCH VINYL IN FENCING.


**RECORD DRAWING**

Ralph B. Beach  
CITY ENGINEER, CITY OF FAIRBANKS  
4/8/96  
DATE

20 10 0 20 40 60  
SCALE IN FEET  
FHC\_C20

## NOTES:

1. ALL DIMENSIONS ARE TO BACK OF CURB.

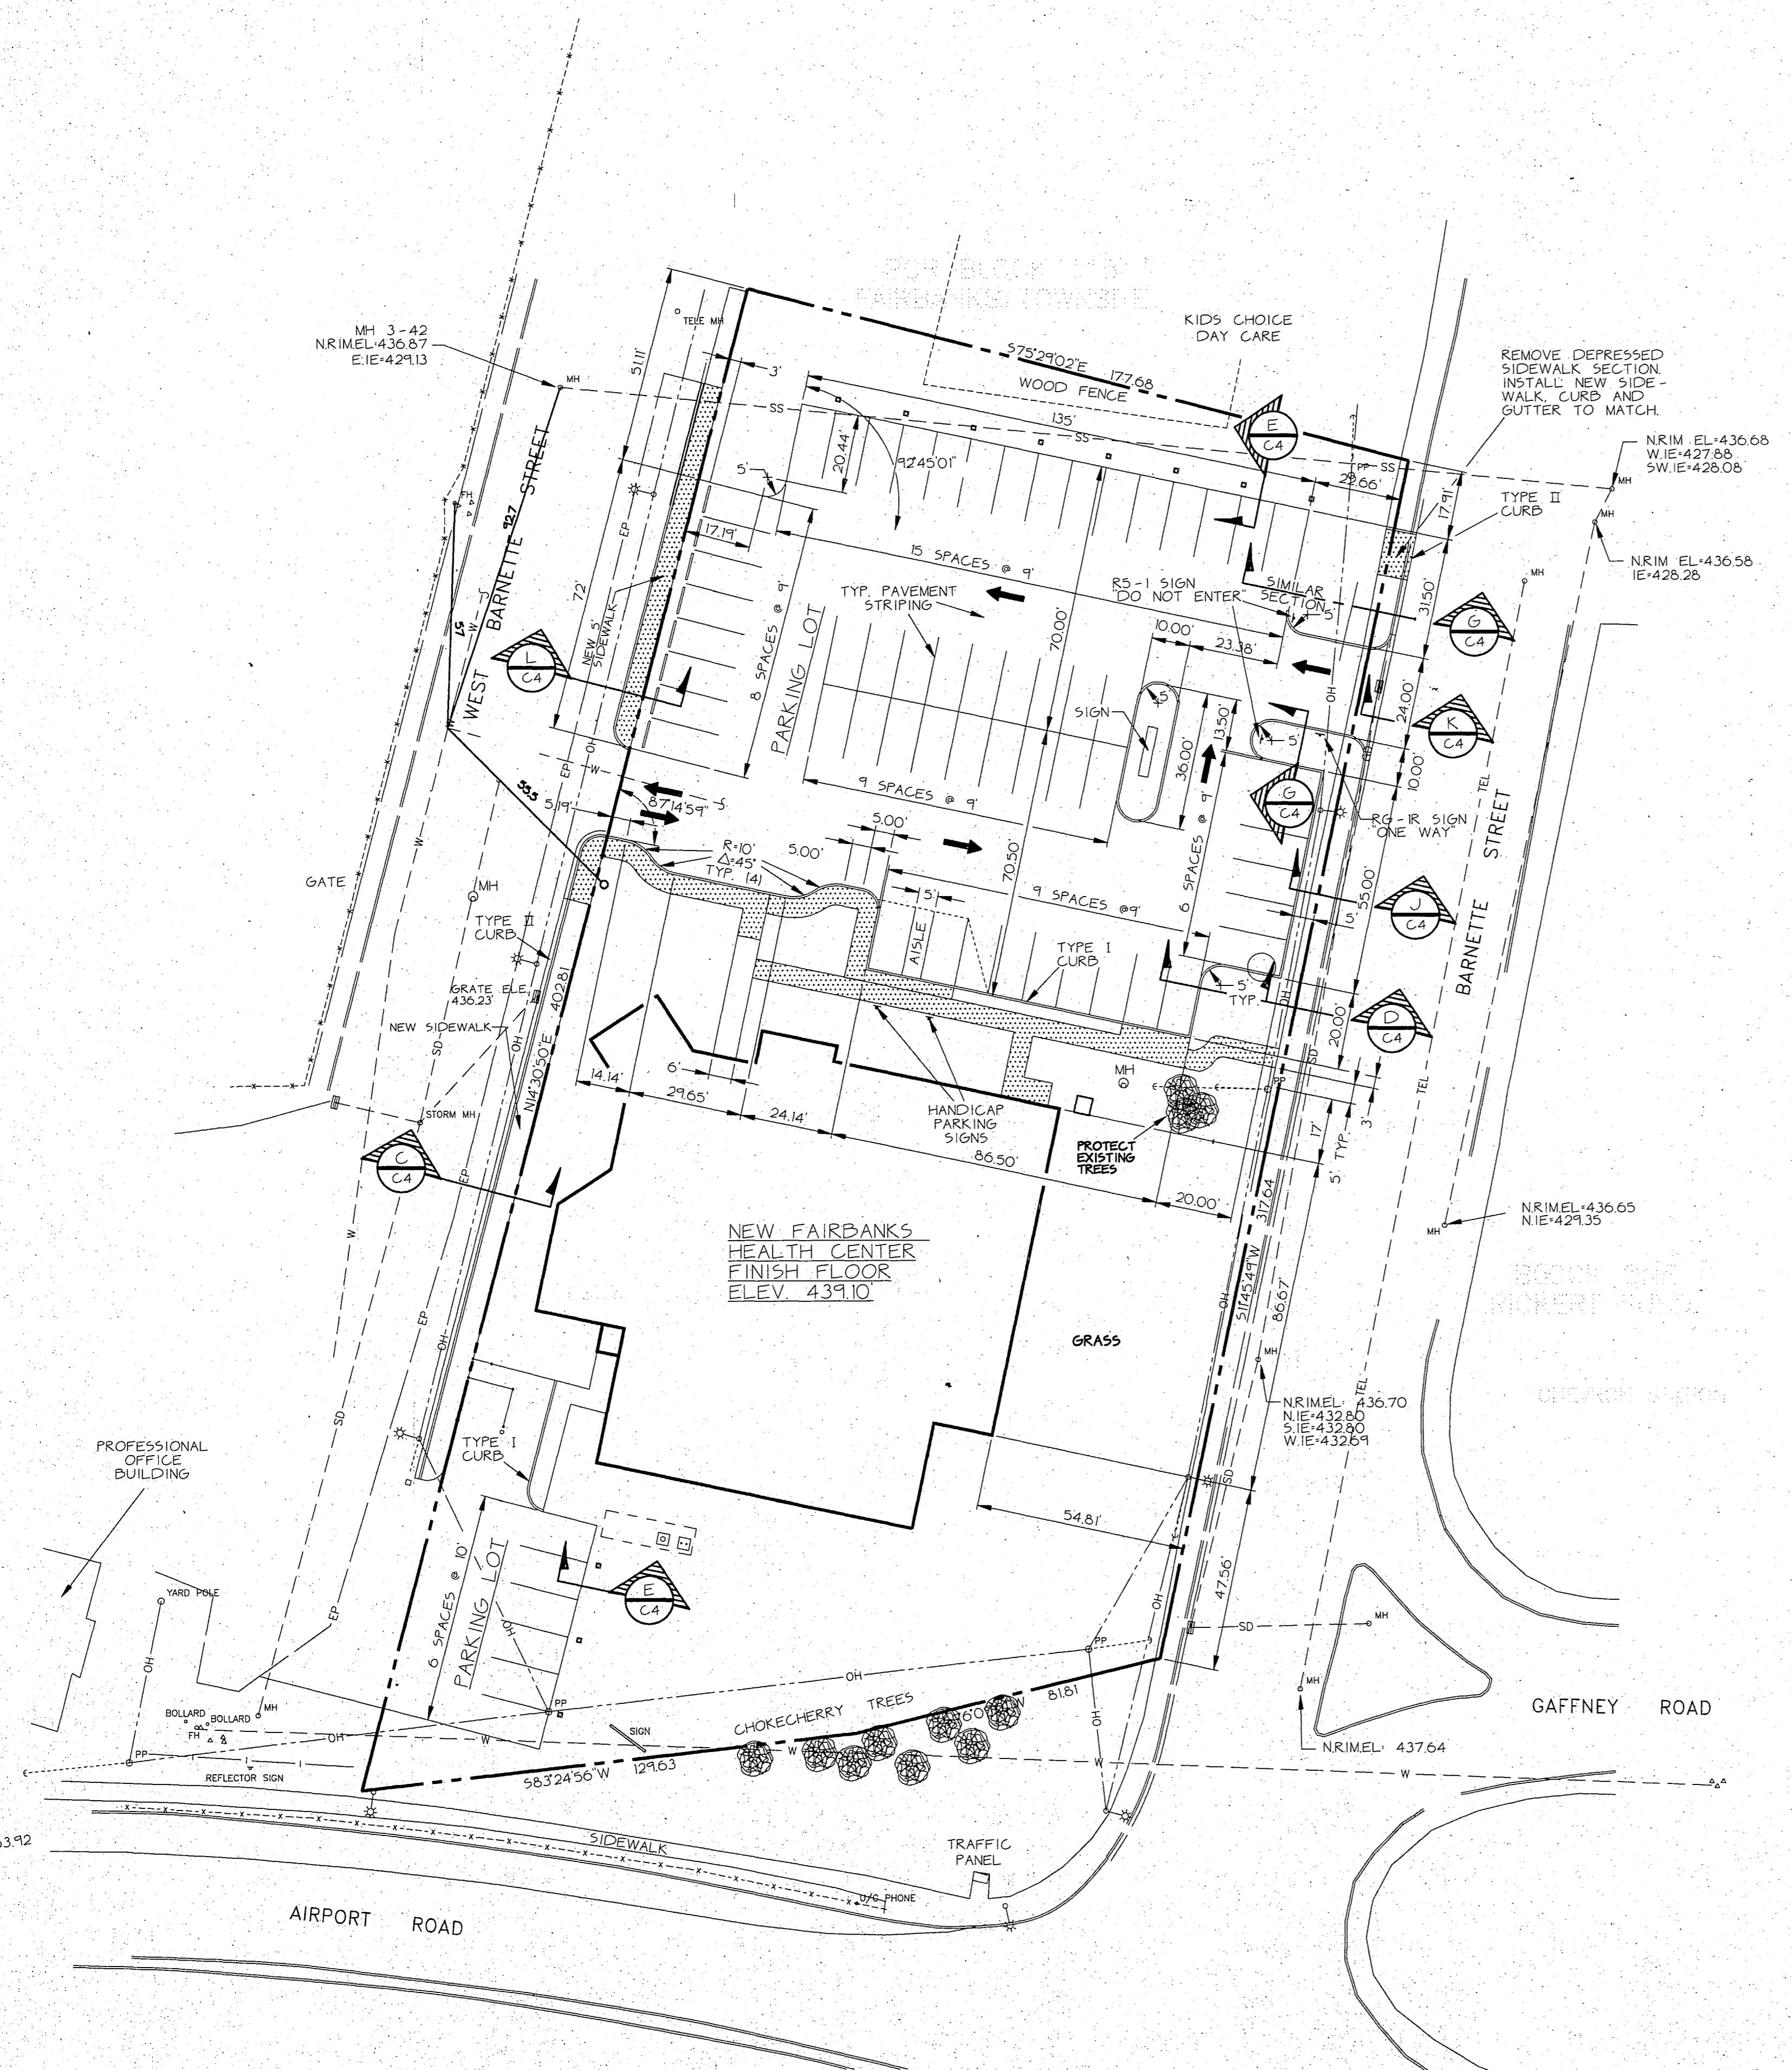

City of Fairbanks  
Fairbanks, Alaska

FAIRBANKS HEALTH CENTER

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# FAIRBANKS HEALTH CENTER

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PROJECT NO. 911125  
DRAWN BY TLR  
CHECKED BY TR  
DATE DEC. 29, 1992  
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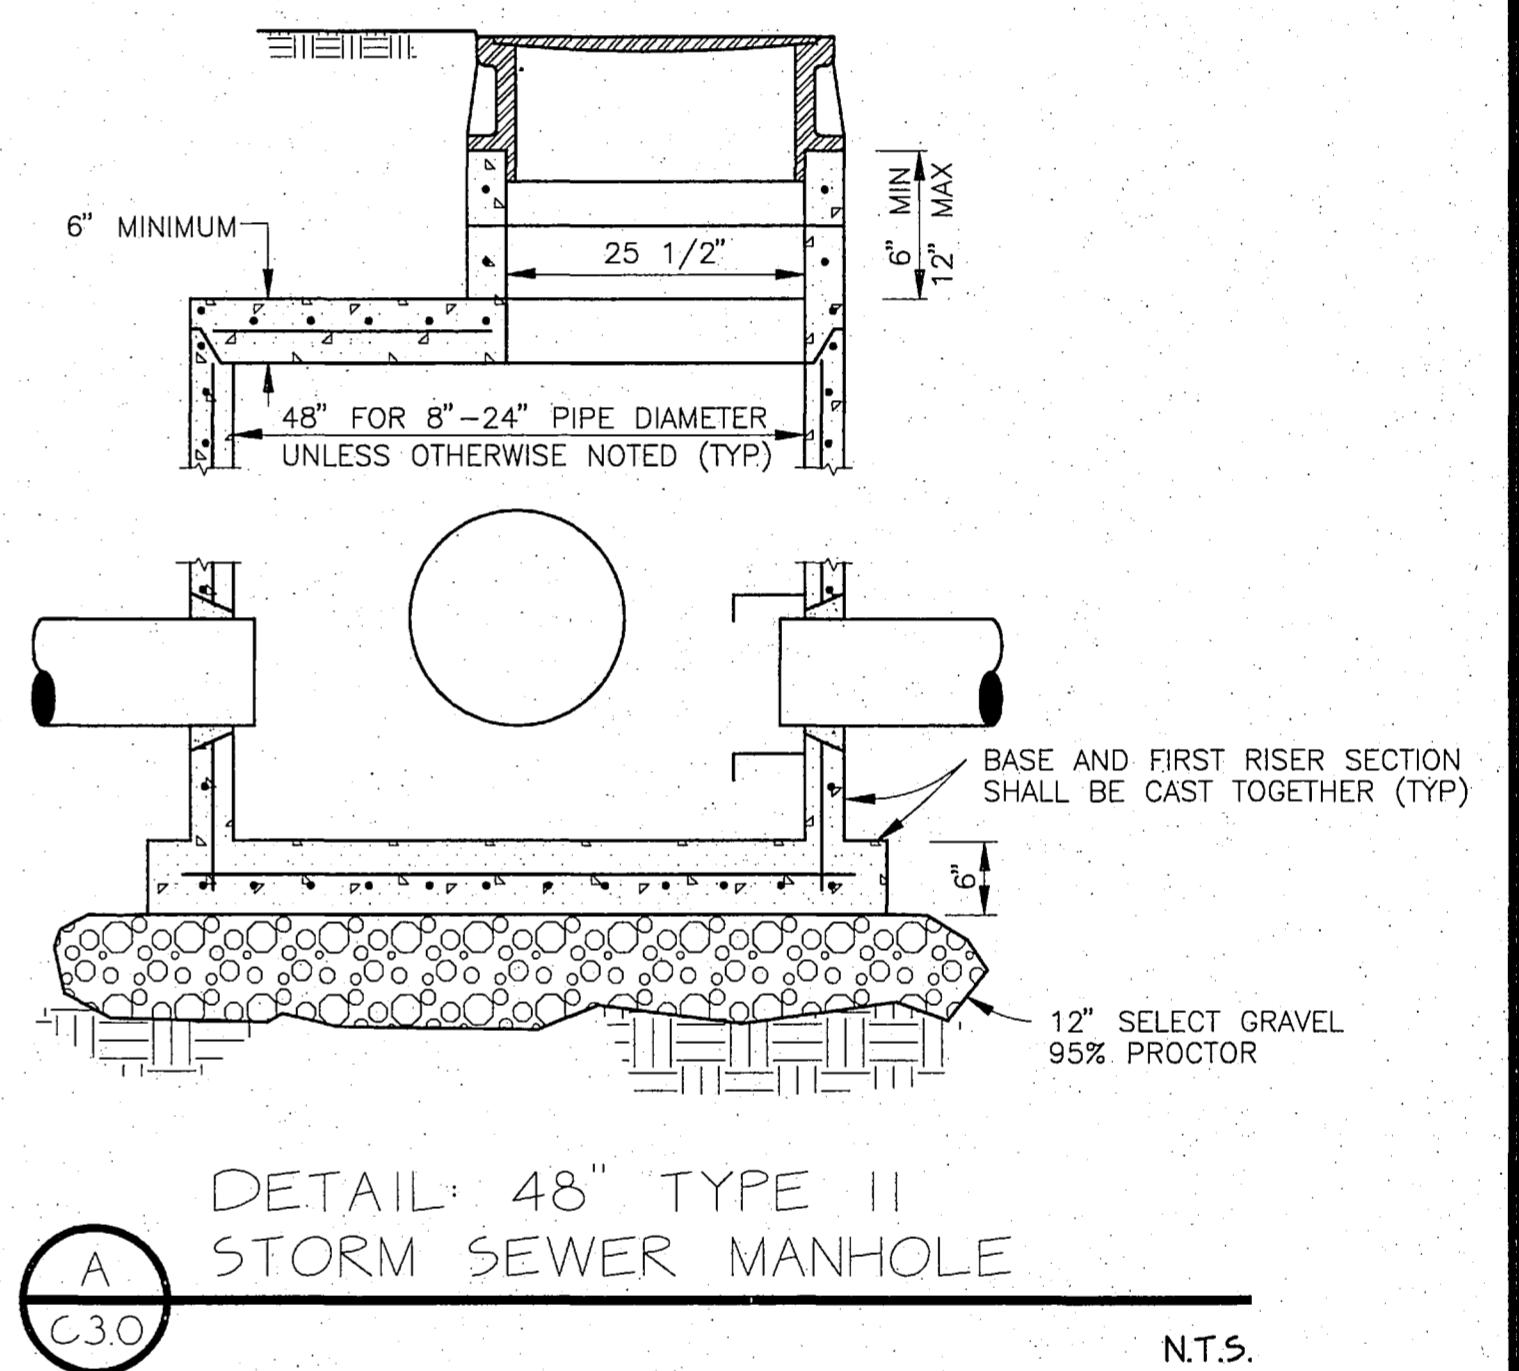
TITLE  
**GRADING AND DRAINAGE PLAN**

SHEET NO.


**C3.0**

## NOTES:

1. SIDEWALKS SHOWN SHADED TO BE CONSTRUCTED IN PHASE II.
2. STRIPING FOR PARKING STALLS: 6" WIDE, 18 FT. LONG, PERPENDICULAR TO FACE OF CURB. STRIPING FOR TRAFFIC DIRECTION 12" WIDE, 10 FEET LONG, IN CENTER OF DRIVING LANE.
3. NEW CONCRETE SIDEWALKS SHALL BE 4" THICK, WITH 6 X W14 X W14 WWF, WITH A MINIMUM OF 12 INCHES OF STRUCTURAL BACKFILL BELOW CONCRETE. PROVIDE TOOLED OR SAW CUT CONSTRUCTION JOINTS ON 5 FT. INTERVALS. PROVIDE EXPANSION JOINTS AT 30 FT. INTERVALS, WITH 1/2 INCH EXPANSION JOINT FILLER, AND JOINT SEALANT. AT EACH EXPANSION JOINT, INSTALL 3 EACH #4 SMOOTH DOWELS, 12 INCHES LONG, ONE END GREASED, TO MAINTAIN VERTICAL JOINT INTEGRITY. NO EXPANSION JOINT OR SEALANT REQUIRED BETWEEN SIDEWALK AND CURBS.
4. PROVIDE CONCRETE SPLASH BLOCKS, 2'-6" SQUARE, 6" THK, SHAPED TO DISSIPATE AND DIRECT FLOW AWAY FROM BUILDING AT ALL ROOF DRAIN OUTLETS TO GRADE.
5. WHERE SIDEWALK ADJOINING STREETS TERMINATE, OR ARE INTERRUPTED BY VEHICULAR DRIVEWAYS, RAMP CONCRETE SIDEWALK AND CURBS TO MEET ASPHALT GRADE, PER STANDARD CITY DETAILS.



DETAIL: 48" TYPE II  
STORM SEWER MANHOLE

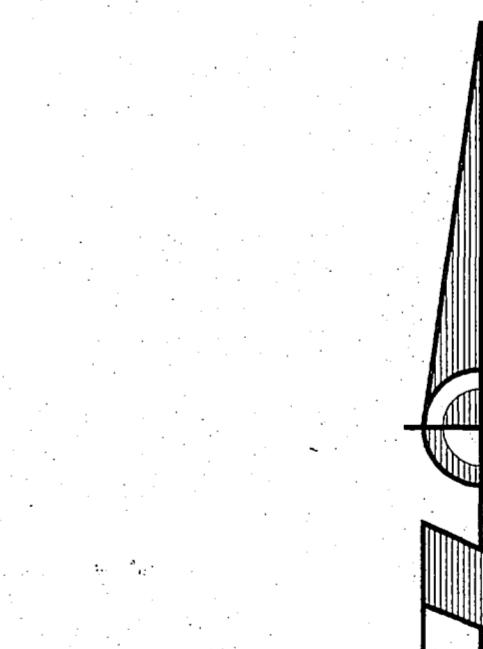

## RECORD DRAWING

Rufus B. Beach  
CITY ENGINEER, CITY OF FAIRBANKS  
4/18/92  
DATE

20 10 0 20 40 60  
SCALE IN FEET  
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## CODE SUMMARY

Both the National Fire Protection Association 1988 Life Safety Code 101 (NFPA 101) and the 1988 Uniform Building Code (UBC) are referenced. In general, NFPA 101 will be followed for egress and existing requirements and UBC will be followed for building construction requirements.

**OCCUPANCY TYPE**  
NFPA - Ambulatory Health Care Center. (NFPA 12 - 13(a)(1))

UBC - Group B, Division 2. (Chapter 7)

### TYPE OF CONSTRUCTION

NFPA - No minimum requirements.  
UBC - Type V NR. (Chapter 22)

### ALLOWABLE AREA

NFPA - Not applicable.  
UBC - Basic Allowable Area for one story buildings.  
Occupancy Type of Construction Allowable Square Footages (UBC Table 5-C)  
B-2 Type V NR 8,000 SF

### ALLOWABLE AREA INCREASE (UBC Section 506)

Given:  
A. Occupancy = B-2  
B. Construction Type = Type V NR  
C. Location on property:

1. Separated on 3 sides.
2. Minimum separation is 50'0" (east side).
3. Area increase per UBC 506.2.2 =  $2 \frac{1}{2} \times (\text{each foot minimum exceeds } 20'-0") = 5\% (50'-0") = 100\% \text{ increase.}$
4. Sprinklers have been provided at the Owner's request.
5. Two stories.

Solution:

Basic Allowable	8,000 SF
Increase for yards (3 sides) 100% increase	
Subtotal	16,000 SF
Multi-story	x 2
Total Allowable	32,000 SF

### ALLOWABLE HEIGHT

NFPA - Not applicable.  
UBC - Maximum height. (Section 507, Table 5-D)

Occupancy Types	Construction	Maximum Height in Feet	Maximum Height in Stories
B-2	Type V NR	40	2

### MINIMUM CONSTRUCTION REQUIREMENTS

NFPA - Not applicable.  
UBC - Minimum requirements based on type of construction (Table 17-A).

Type V NR	
Exterior Bearing Walls	N
Exterior Nonbearing Walls	N
Interior Bearing Walls	N
Structural Frame	N
Permanent Partitions	N
Shaft Enclosures	N (106)
Floors	N (1 HR IN DAY TANK AND MECH. ROOM 213)
Roofs	N
Corridors	1 HR
Stair Enclosures	N
Exit Passageway	N
Exterior Openings	No protection required, building separation of 50' exceeds requirements of 2205 and 504.

### AREA, SMOKE AND OCCUPANCY SEPARATIONS

UBC - Area separation walls are not required to partition building into areas since the maximum allowable are not exceeded. NFPA does not require smoke partitions. (2-3.1.1.b). Provide draft stops per UBC 2516.6.4.11 - Exception (draft stops at 1000 SF maximum and maximum horizontal dimension of 60 LF).

### BUILDING HANDICAP ACCESSIBILITY

NFPA - No requirements.

UBC - Required. (Section 3301, e)

ADAAG - 28 CFR Part 36, Appendix A. The ADA Accessibility Guidelines will be compiled with, as required by the American with Disability Act of 1990.

### ELEVATORS

NFPA - No requirements.

UBC - Requirements for accessibility.

ANSI/ASME A17.1 - Requirements for design.

Alaska State Elevator Code - Requirements for accessibility.

- Recommendation - Follow UBC, ADAAG, ANSI/ASME A17.1, and Alaska State Elevator Code.

### EXIT REQUIREMENTS

NFPA	UBC (Table 33-A)
------	------------------

Minimum number of exits	2
	2 (30,500p)
	3 (50,1000p)
	4 (+100p)

Code required	
Occupant load (SF/person)	
B-2	100 (offices) 15 (assembly)
	300 (storage and mech. rm)

Actual	
Occupant load (SF/person)	

FIRST FLOOR	
OFFICE	- 4161 SF/100 SF. = 48 OCCUPANTS
CONFERENCE	- 107 SF/15 SF. = 74 OCCUPANTS
WAITING	- 31 SF/15 SF. = 25 OCCUPANTS
STORAGE	- 1371 SF/300 SF. = 5 OCCUPANTS
TOTAL	: 152 Occupants, +50 % Second Floor = 165 Occupants/50 = 3.3 LF. exit width required (UBC 3303, b).

Actual width of openings: 2 exits @ 9'-0" LF provided, therefore, exits comply.

SECOND FLOOR	
OFFICE	- 2261 SF/100 SF. = 23 OCCUPANTS
STORAGE	- 655 SF/300 SF. = 3 OCCUPANTS
TOTAL	: 26 Occupants/50 = 0.52 LF. exit width required (UBC 3303, b)

Actual width of openings: 2 exits @ 3'-0" LF provided, therefore, exits comply.

NFPA	UBC
------	-----

Exit capacity (person/ft)	
B-2	60 (stair) 40 (level)
	50 50

Minimum exit width:	
Door	32 in.
Corridor	44 in.
Stair	44 in.

Arrangement of exits	Remote (half diag.)
	Remote (half diag.)

Travel distance	
Sprinklered	200 ft.
	200 ft.

Dead end	20 ft.
	20 ft.

Special Hazards 2 Exits (Section 3322.2)

### EXIT SIGNS AND ILLUMINATION

NFPA	UBC (Section 3314)
------	--------------------

Exit signs	Required
Emergency illumination	Required

- Recommendation - Follow NFPA requirements to be consistent with size and arrangements of exits.

### PROTECTION FROM HAZARDS

NFPA UBC (Section 708)

Boiler/Fuel fired heater 2 hr. or 1 hr.  
sprinklered

- Recommendation - Follow UBC requirements.

### CORRIDORS

NFPA - One hour corridors with 20 minute doors.

UBC - One hour corridors with 20 minute doors.

### SPRINKLERS AND STANDPIPES

NFPA - Sprinklers are not required. Sprinklers will be provided as requested by Owner.

UBC - Sprinklers are not required. Sprinklers will be provided as requested by Owner.

### FIRE EXTINGUISHERS

NFPA - Required to be installed in accordance with NFPA 10. Fire extinguishers as specified with a maximum travel distance between extinguishers of 75 ft. or 3000 SF of floor area.

UBC - Not required.

- Recommendation - Follow NFPA requirements.

### FIRE ALARM SYSTEM

NFPA - Alarm system with manual, heat/smoke and sprinkler activation are requested by Owner. Local and remote notification will be provided.

UBC - Alarm system with manual, heat/smoke and sprinkler activation are requested by Owner. Local and remote will be provided.

- Recommendation - Follow NFPA requirements.

### DRAFT STOPS

NFPA - Provide fire stops in wood joist construction in volumes not to exceed 160 cubic feet.

NFPA - Provide five stops in concealed spaces (including exterior and interior soffits) so areas will not exceed 55 square feet.

## ZONING SUMMARY

BUILDING FOOT PRINT: 12,450 SF  
SITE AREA: Approximately (68,000 SF)  
CLASSIFICATION: Two Family Residential

### SETBACKS: Approximately

FRONT YARD: East 80'  
REAR YARD: North 160'  
SIDE YARD: South 100'  
SIDE YARD: West 40'


### PARKING REQUIREMENTS:

Chapter 10.50.060 of Fairbanks North Star Borough Title 18 Zoning Ordinance, 1988.

Minimum standard of one space per 200 SF of Office. Net Area consists of the building accessible to or devoted to use by customer or patron.

NET AREA - 9250 SF  
SPACES REQUIRED - 46 STD 1 HDP  
SPACES PROVIDED - 65 STD 2 HDP

BUILDING HEIGHT: 2 stories (28'-0")  
BUILDING SITE COVERAGE: Approximately 18%

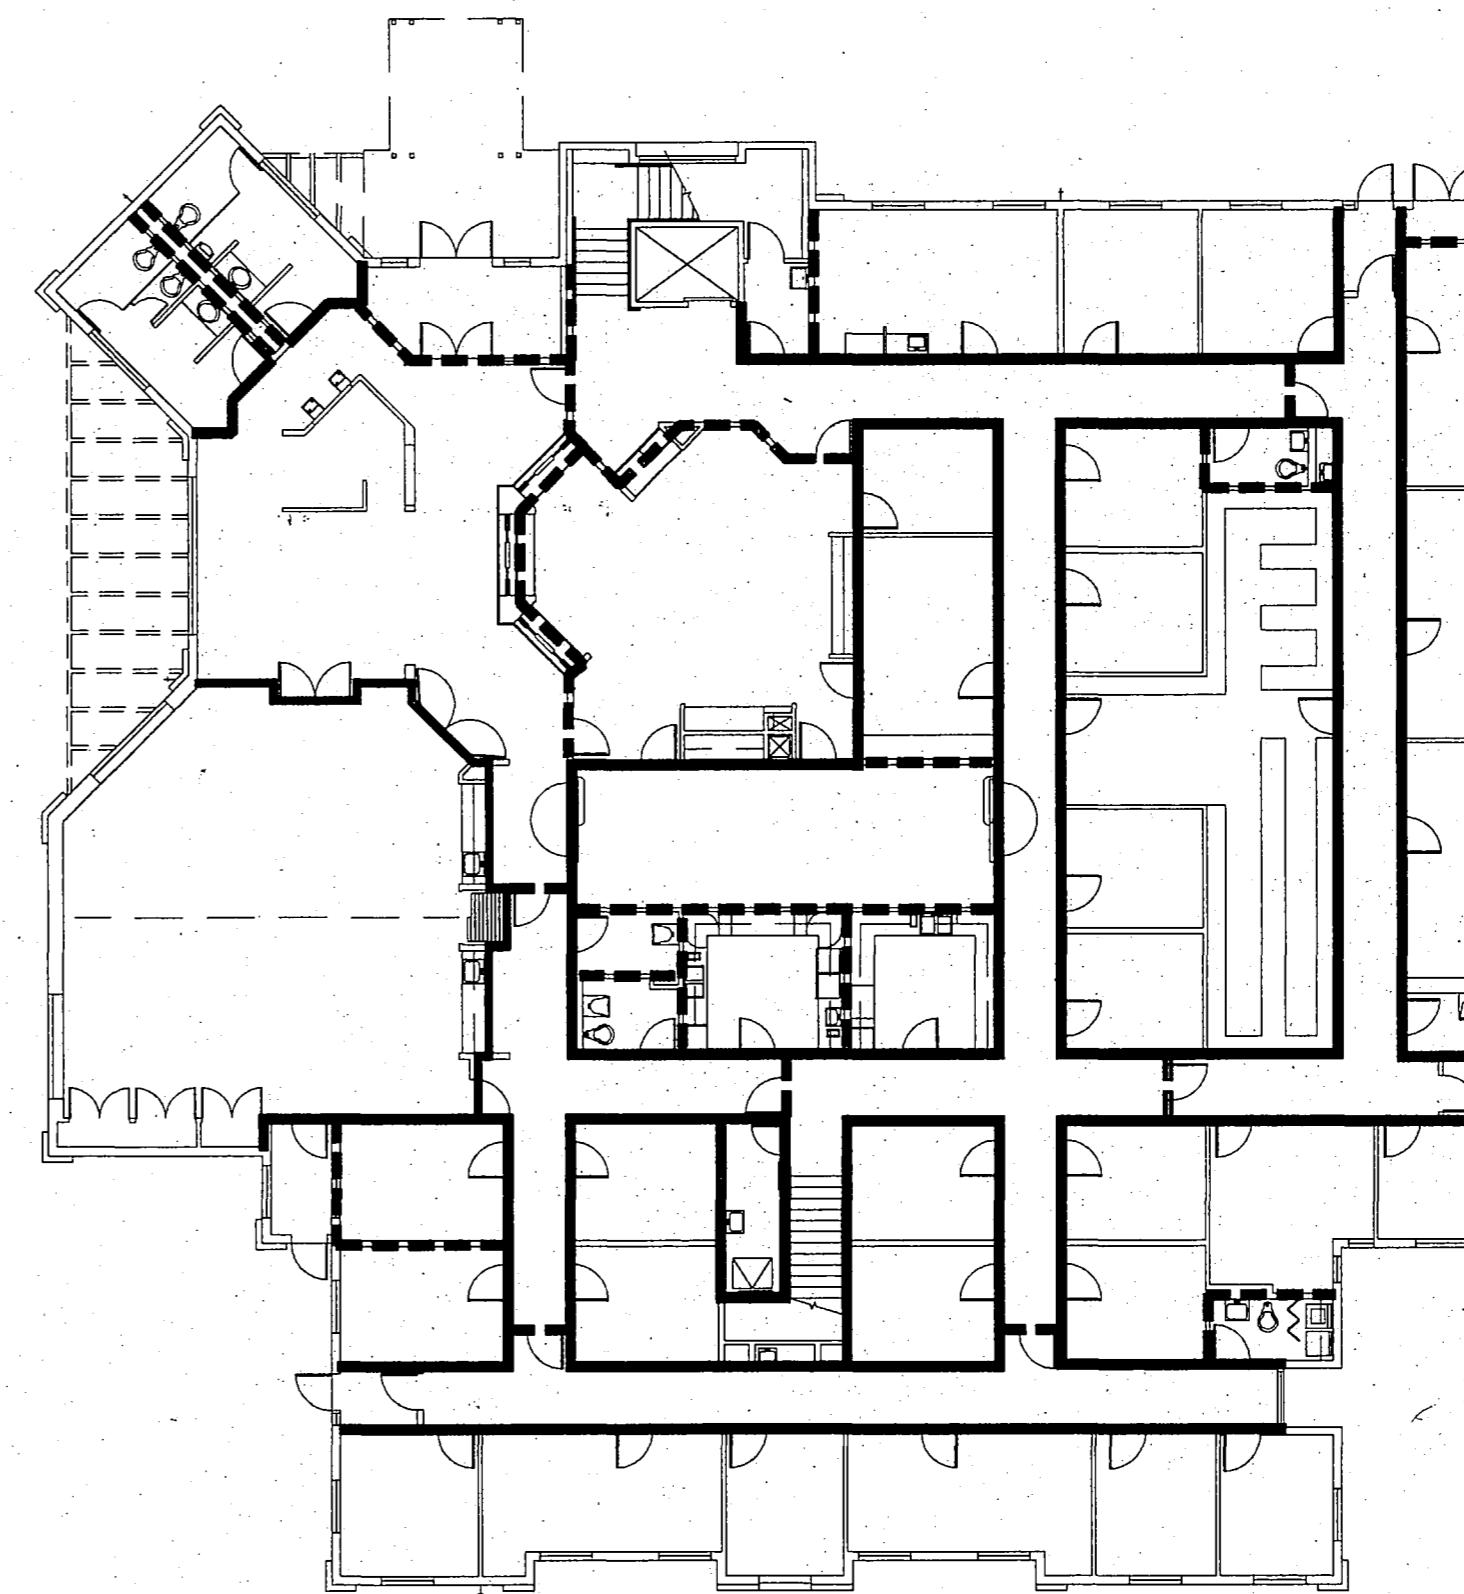


2 FIRST FLOOR PLAN, FIRE PROTECTION

SCALE: 1 / 16" = 1' - 0"

**RECORD DRAWING**  
**CODE SUMMARY**  
**FIRE PROTECTION**

John D. Bond  
CITY ENGINEER, CITY OF FAIRBANKS

478196  
DATE

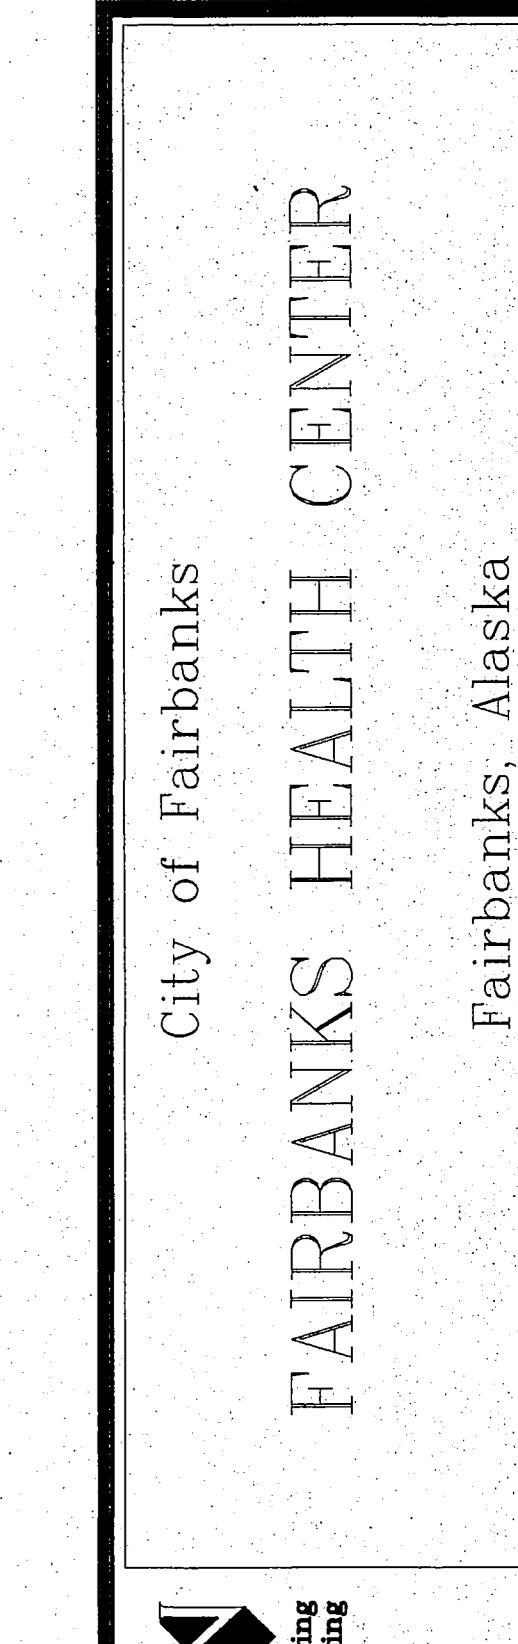

1 SECOND FLOOR PLAN, FIRE PROTECTION

SCALE: 1 / 16" = 1' - 0"

**FAIRBANKS HEALTH CENTER**

City of Fairbanks

Fairbanks, Alaska

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# RECORD DRAWING

Rufus B. Bond  
CITY ENGINEER, CITY OF FAIRBANKS

4/18/96

DATE

**TITLE  
SITE  
PLAN**

SHEET NO.


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1 SITE PLAN  
SCALE: 1" = 20'

50 10 20 40  
SCALE IN FEET




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PROJECT NO. 115.00  
DRAWN BY: HOALS  
CHECKED BY: JBJA  
DATE: DEC 9, 1992  
REVISED:

TITLE:  
**FIRST LEVEL PLAN**

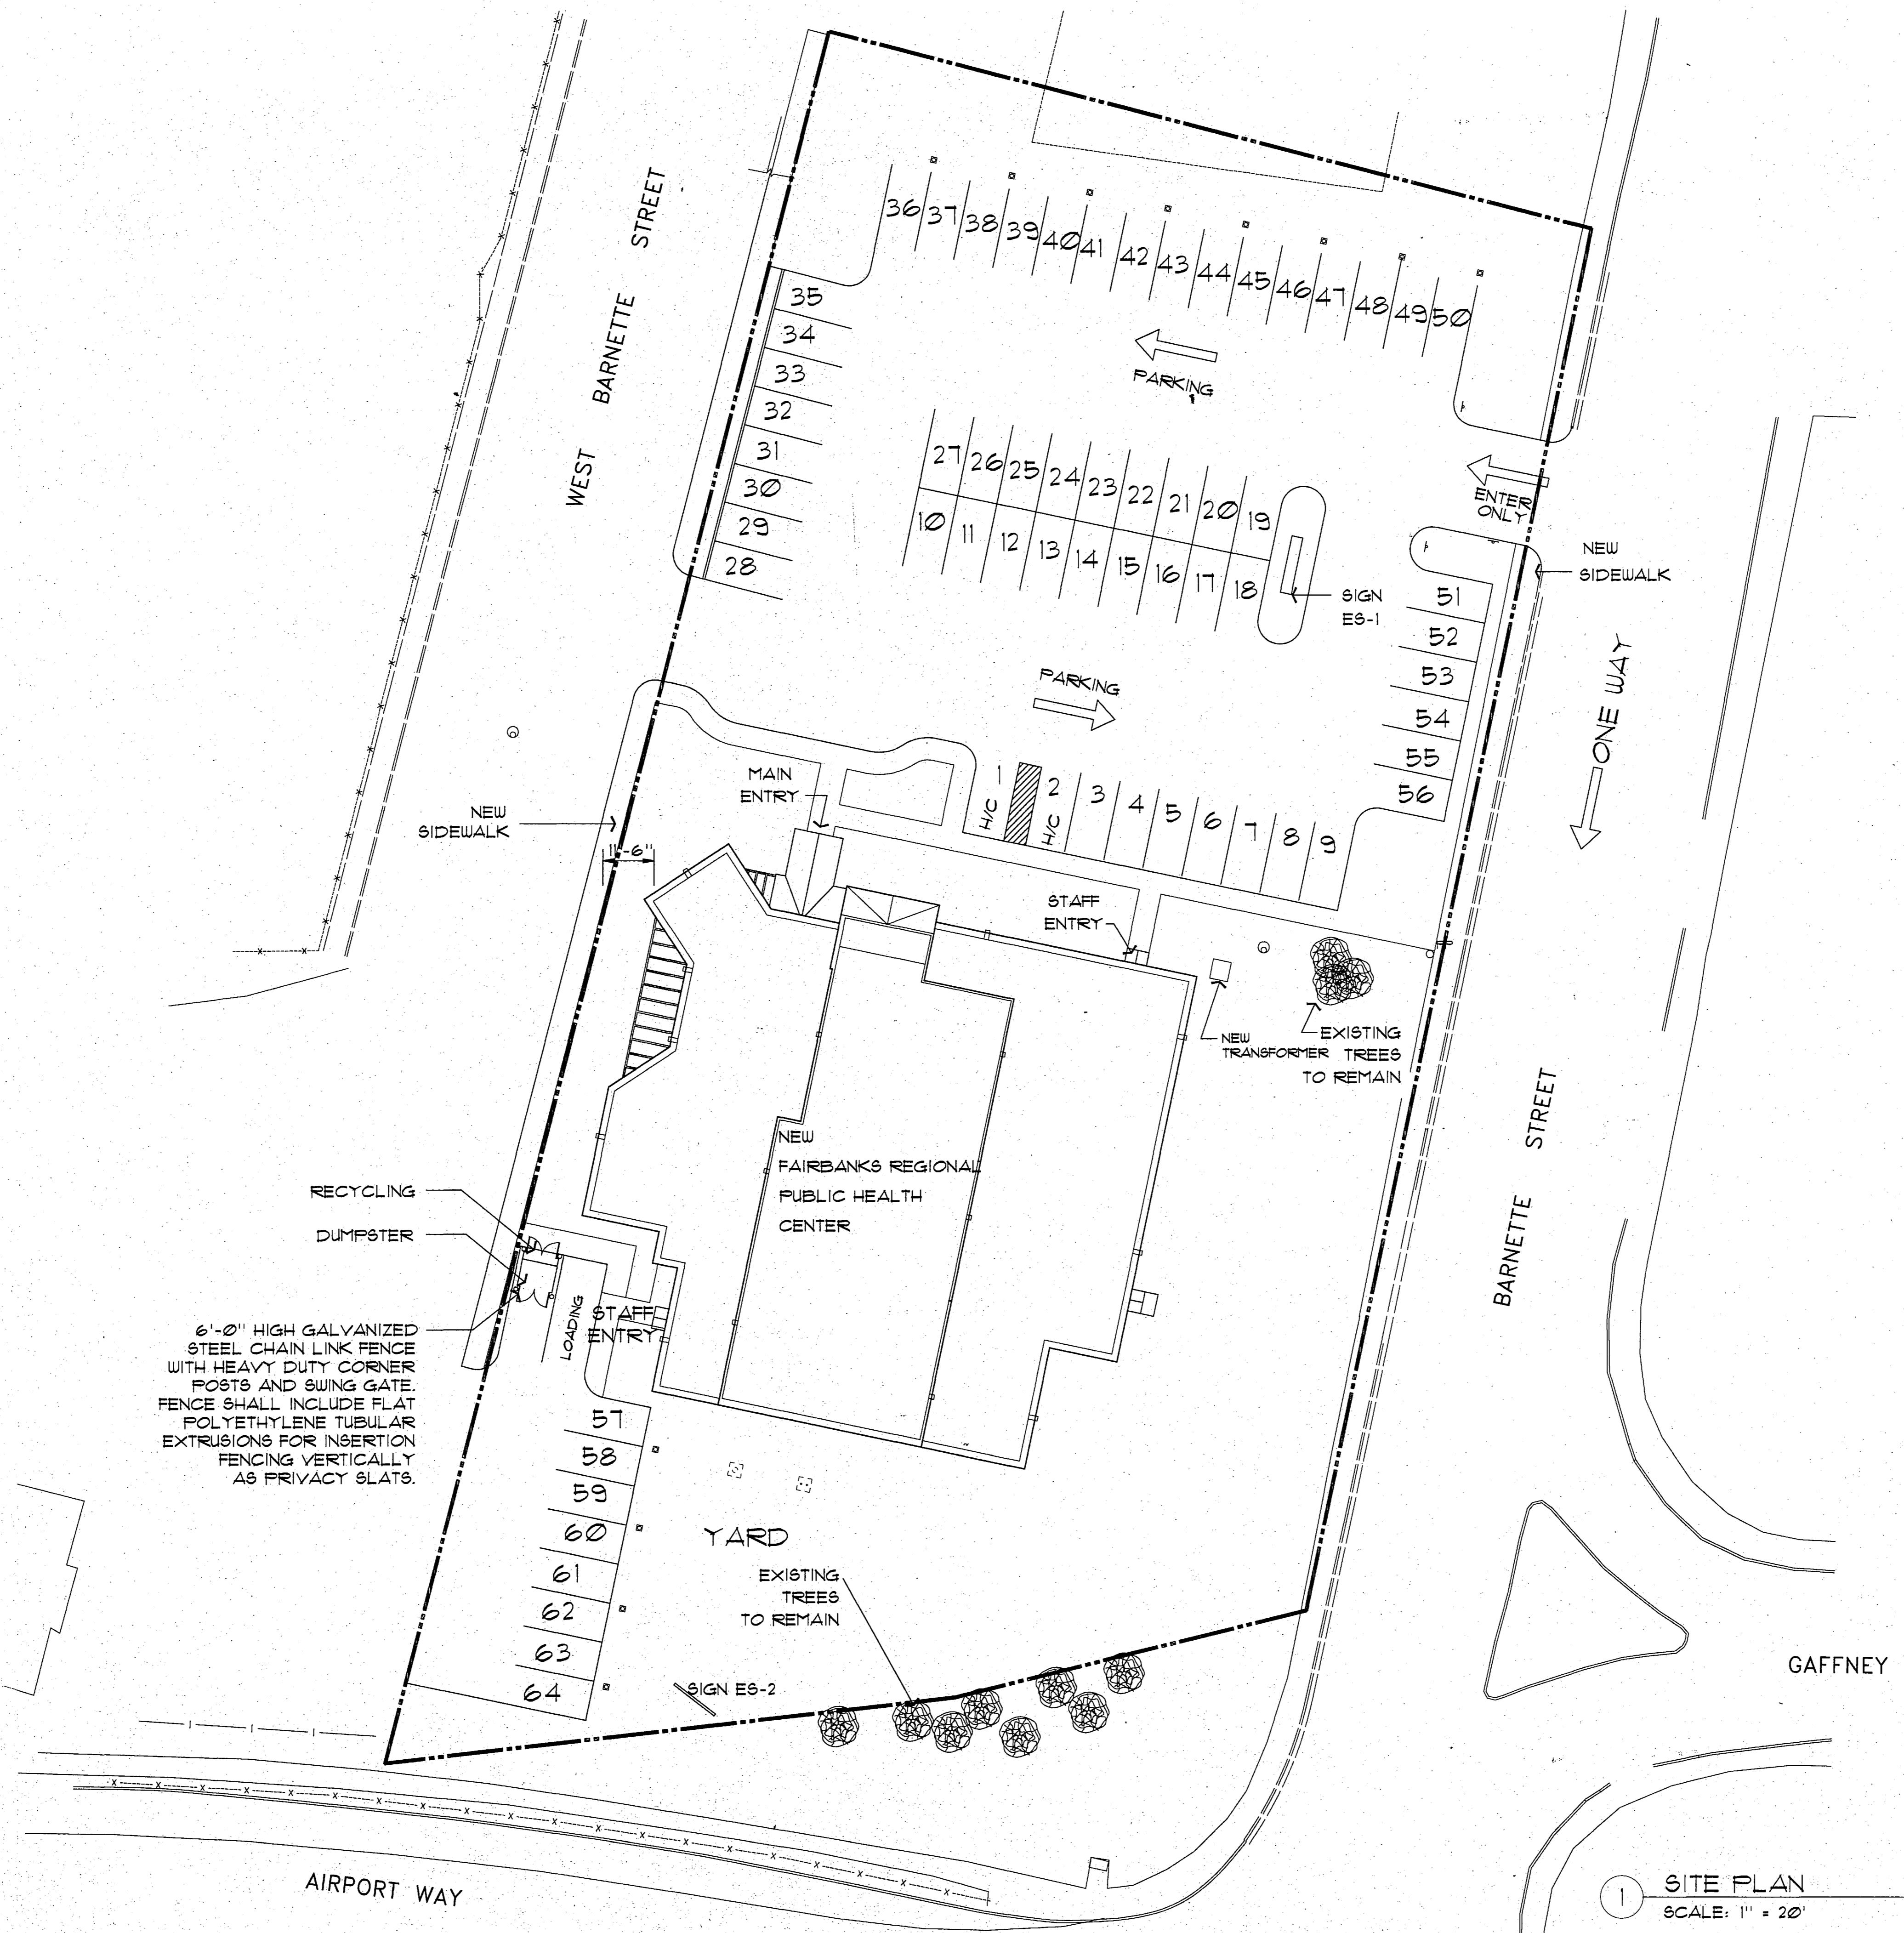
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**A3.0**

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Rufus B. Bond  
CITY ENGINEER, CITY OF FAIRBANKS

4-18-96

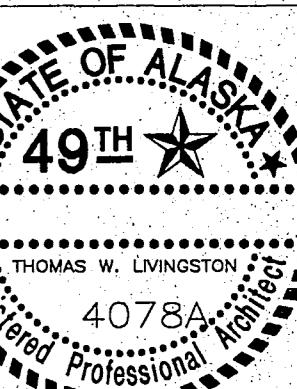

City of Fairbanks

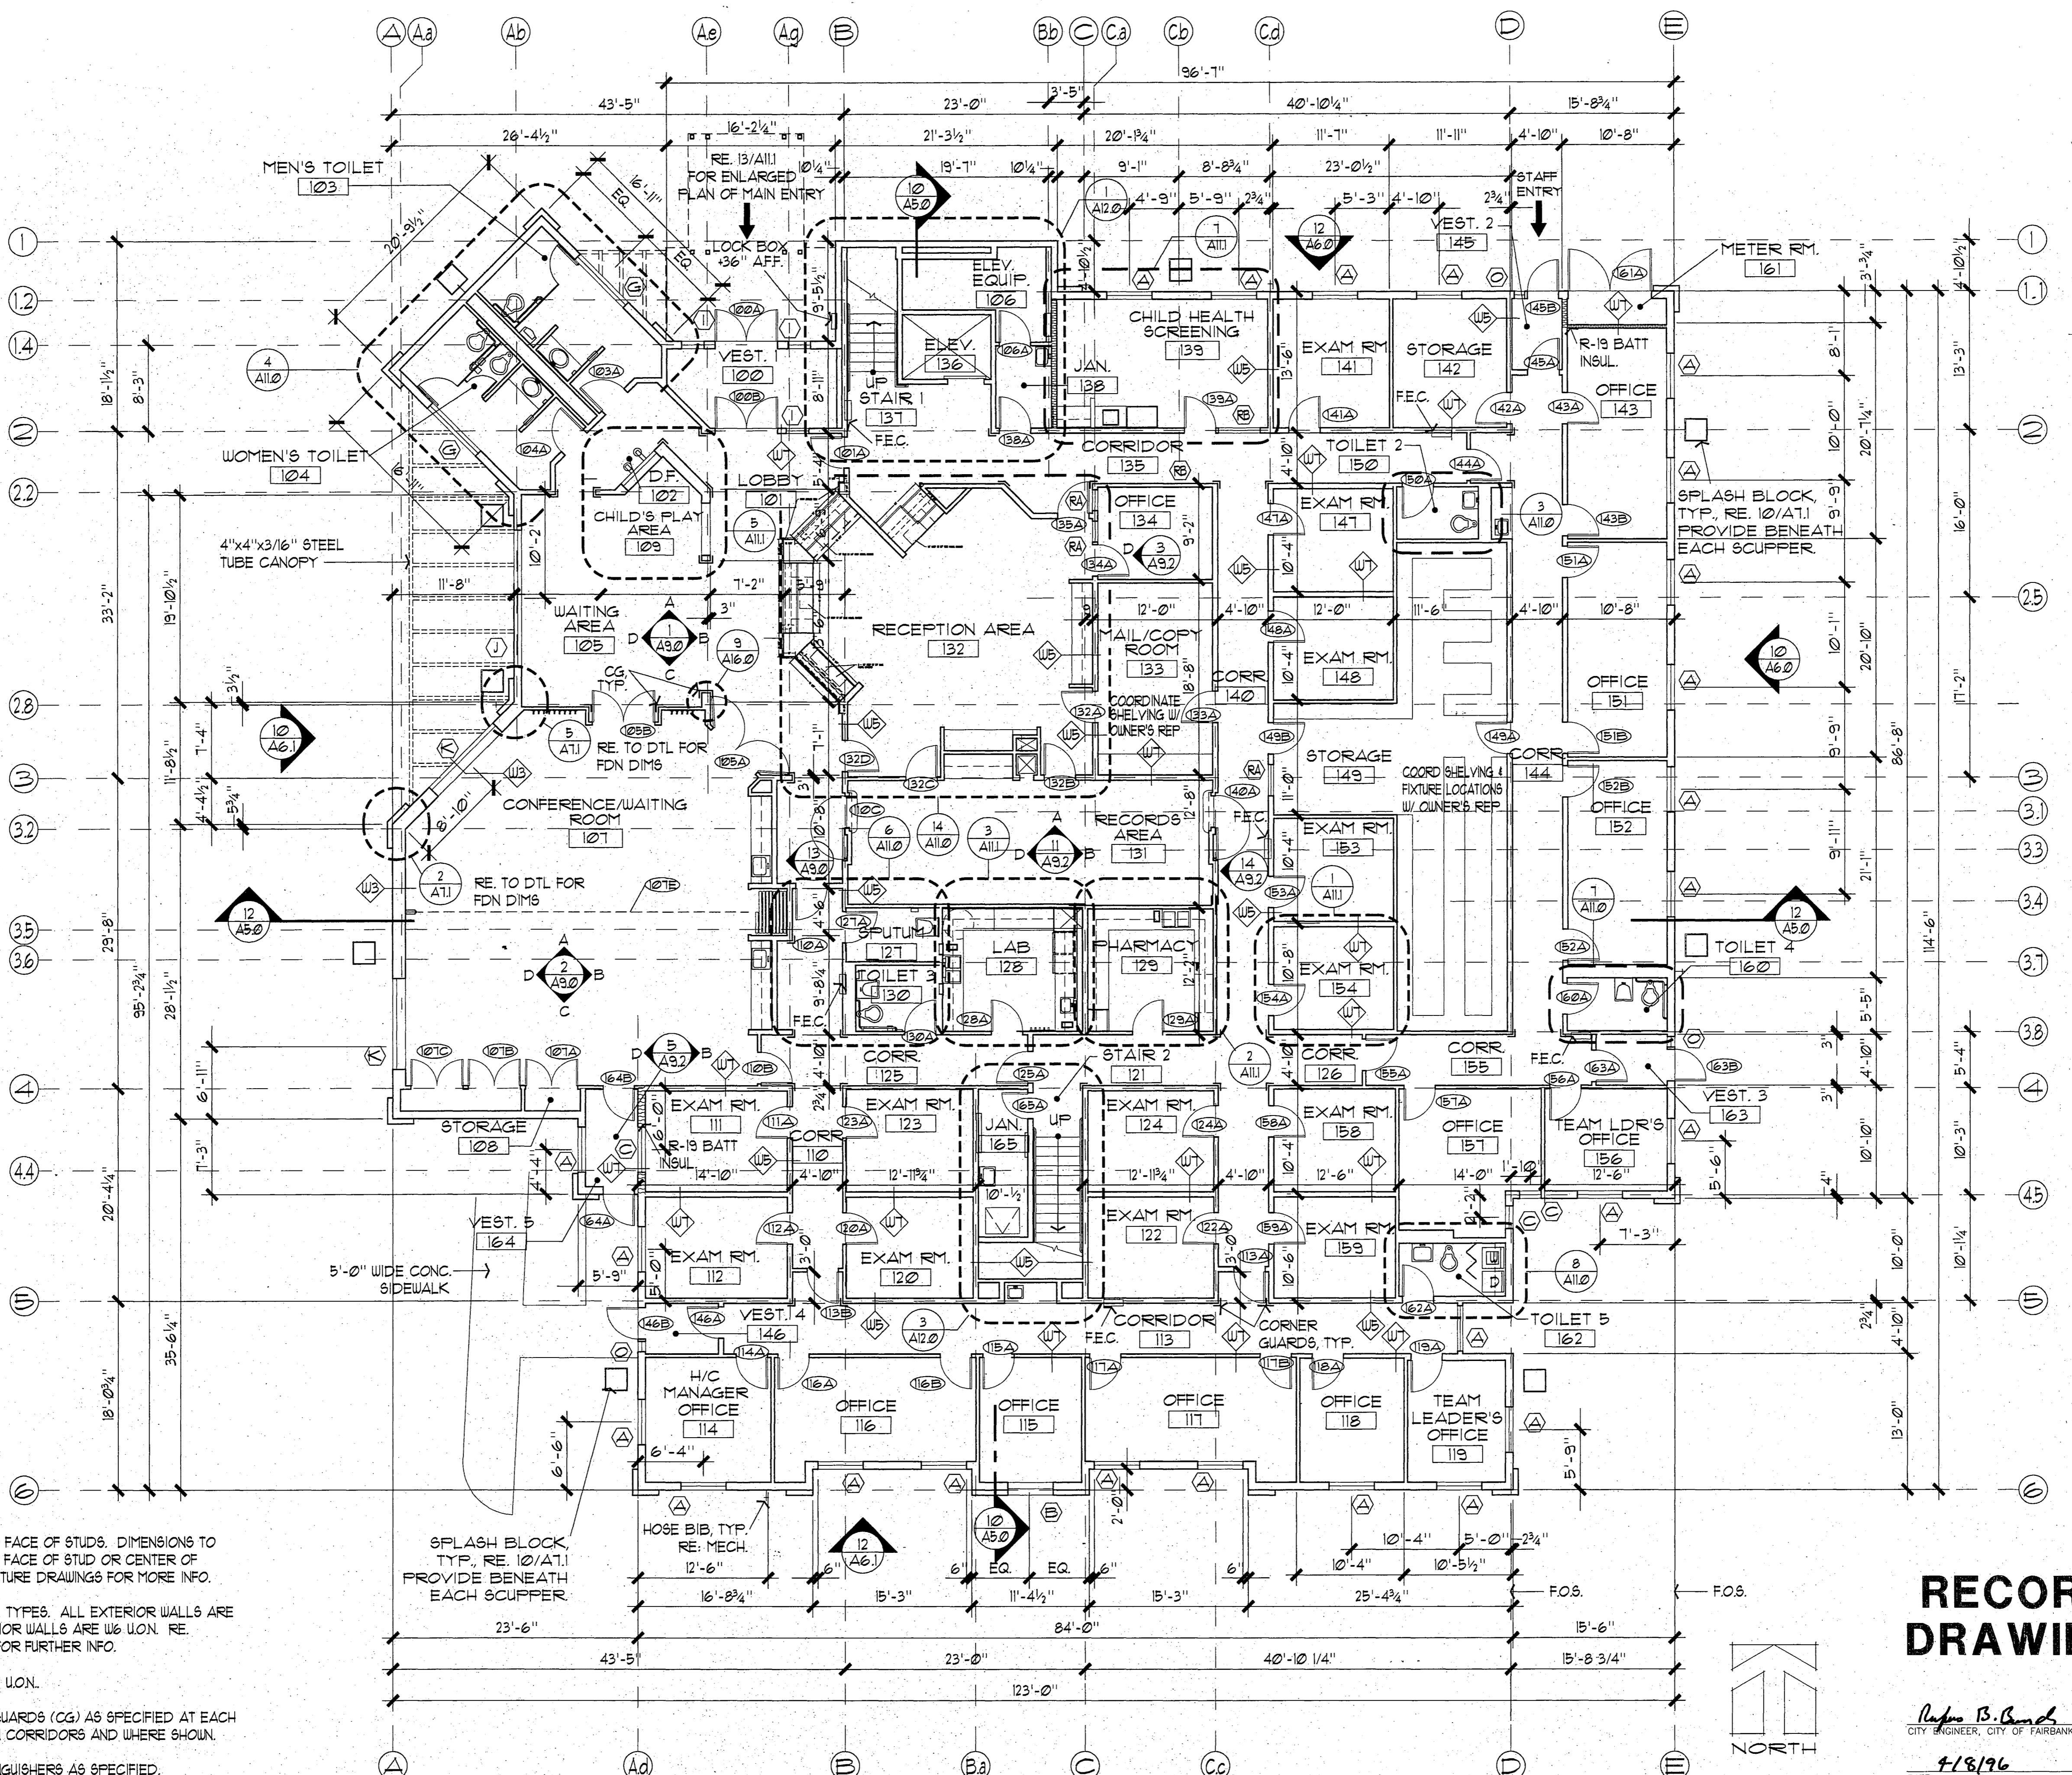
Fairbanks, Alaska

Fairbanks, Alaska  
FIRBANKS HEALTH CENTER

LIVINGSTON STONE Architecture, Engineering, Planning, Interior Design, Incorporated

3900 Arctic Blvd. Suite 301  
Fairbanks, Alaska 99703-5790

(907) 452-2055

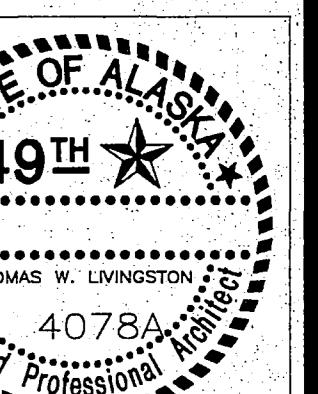

PROJECT NO. 115.00  
DRAWN BY JB,AS  
CHECKED BY JB,JA  
DATE DEC 9, 1992  
REVISED

TITLE  
SECOND LEVEL PLAN  
SHEET NO.


A3.1

**RECORD DRAWING**

*Rufus B. Beck*  
CITY ENGINEER, CITY OF FAIRBANKS

418196

DATE

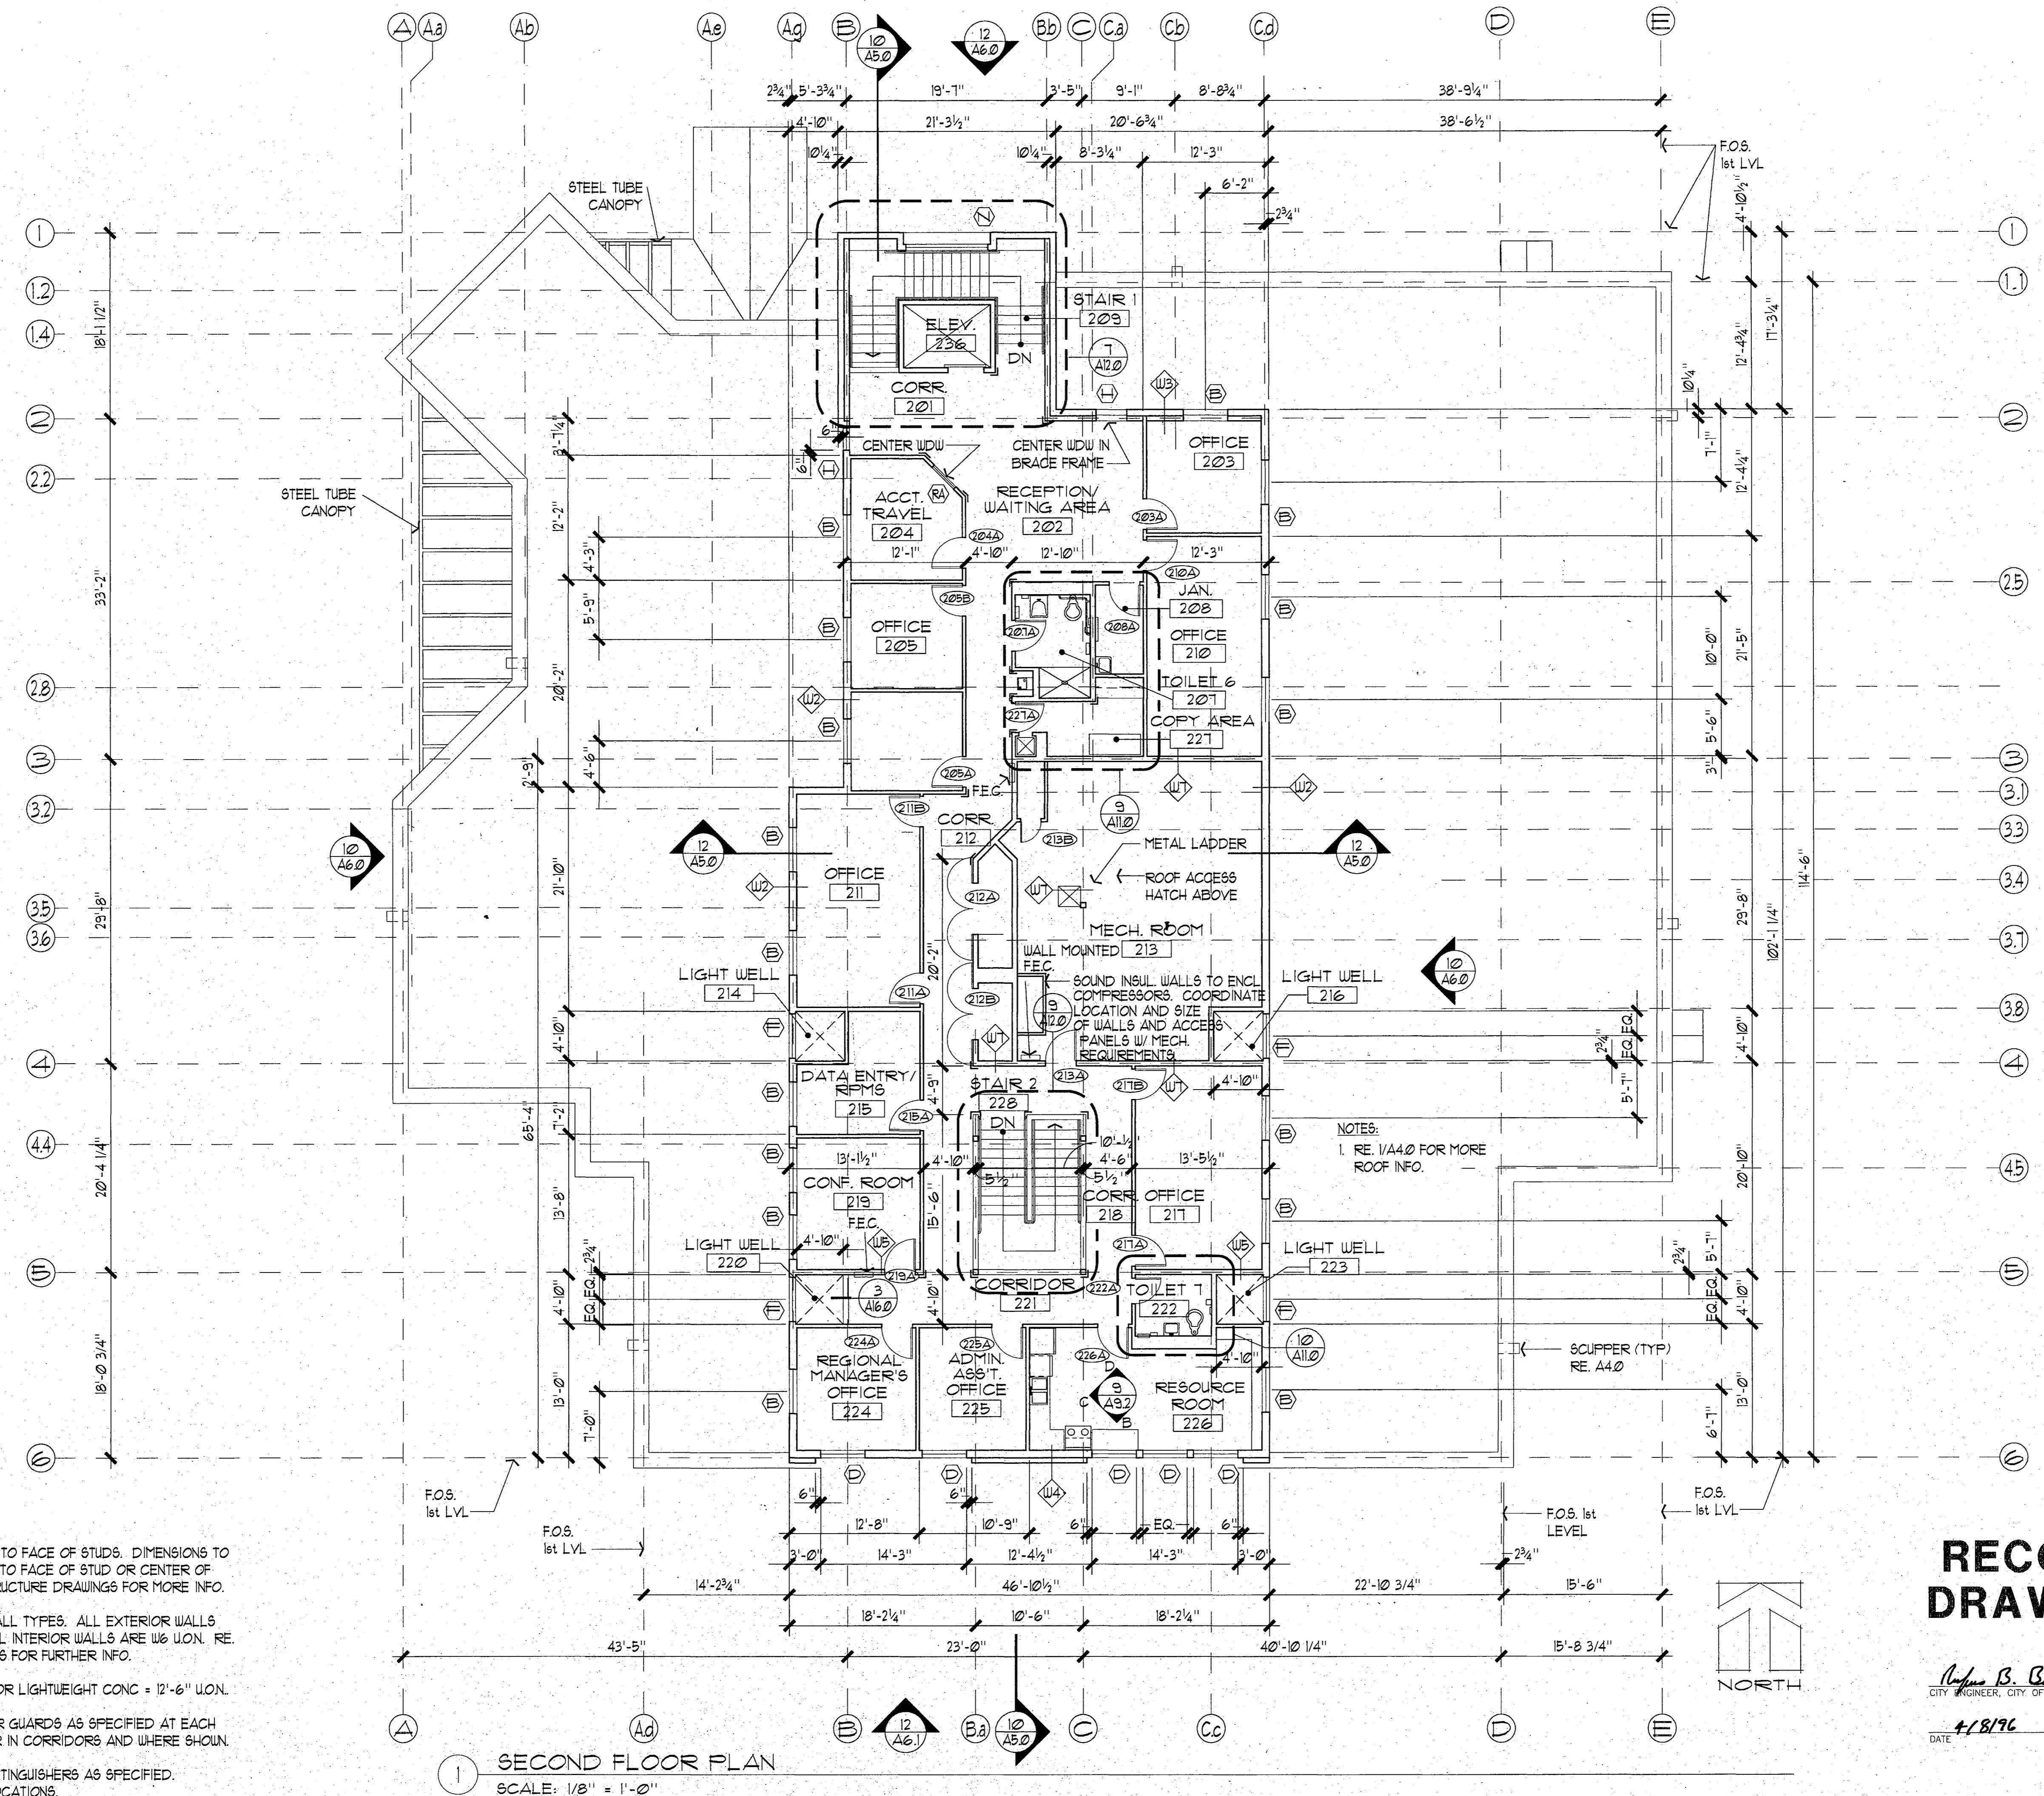


Fairbanks HEALTH CENTER

**LIVINGSTON STONE**

Architecture Engineering Interior Design Planning  
Incorporated

3800 Arctic Blvd, Suite 301  
Anchorage, Alaska 99503-0790  
(907) 562-2088

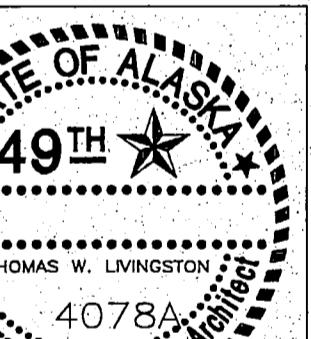


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DRAWN BY ALS  
CHECKED BY JB,JA  
DATE DEC 9, 1992  
REVISED

TITLE  
**ROOF PLAN**

SHEET NO.

**A4.0**

F3.0 .083

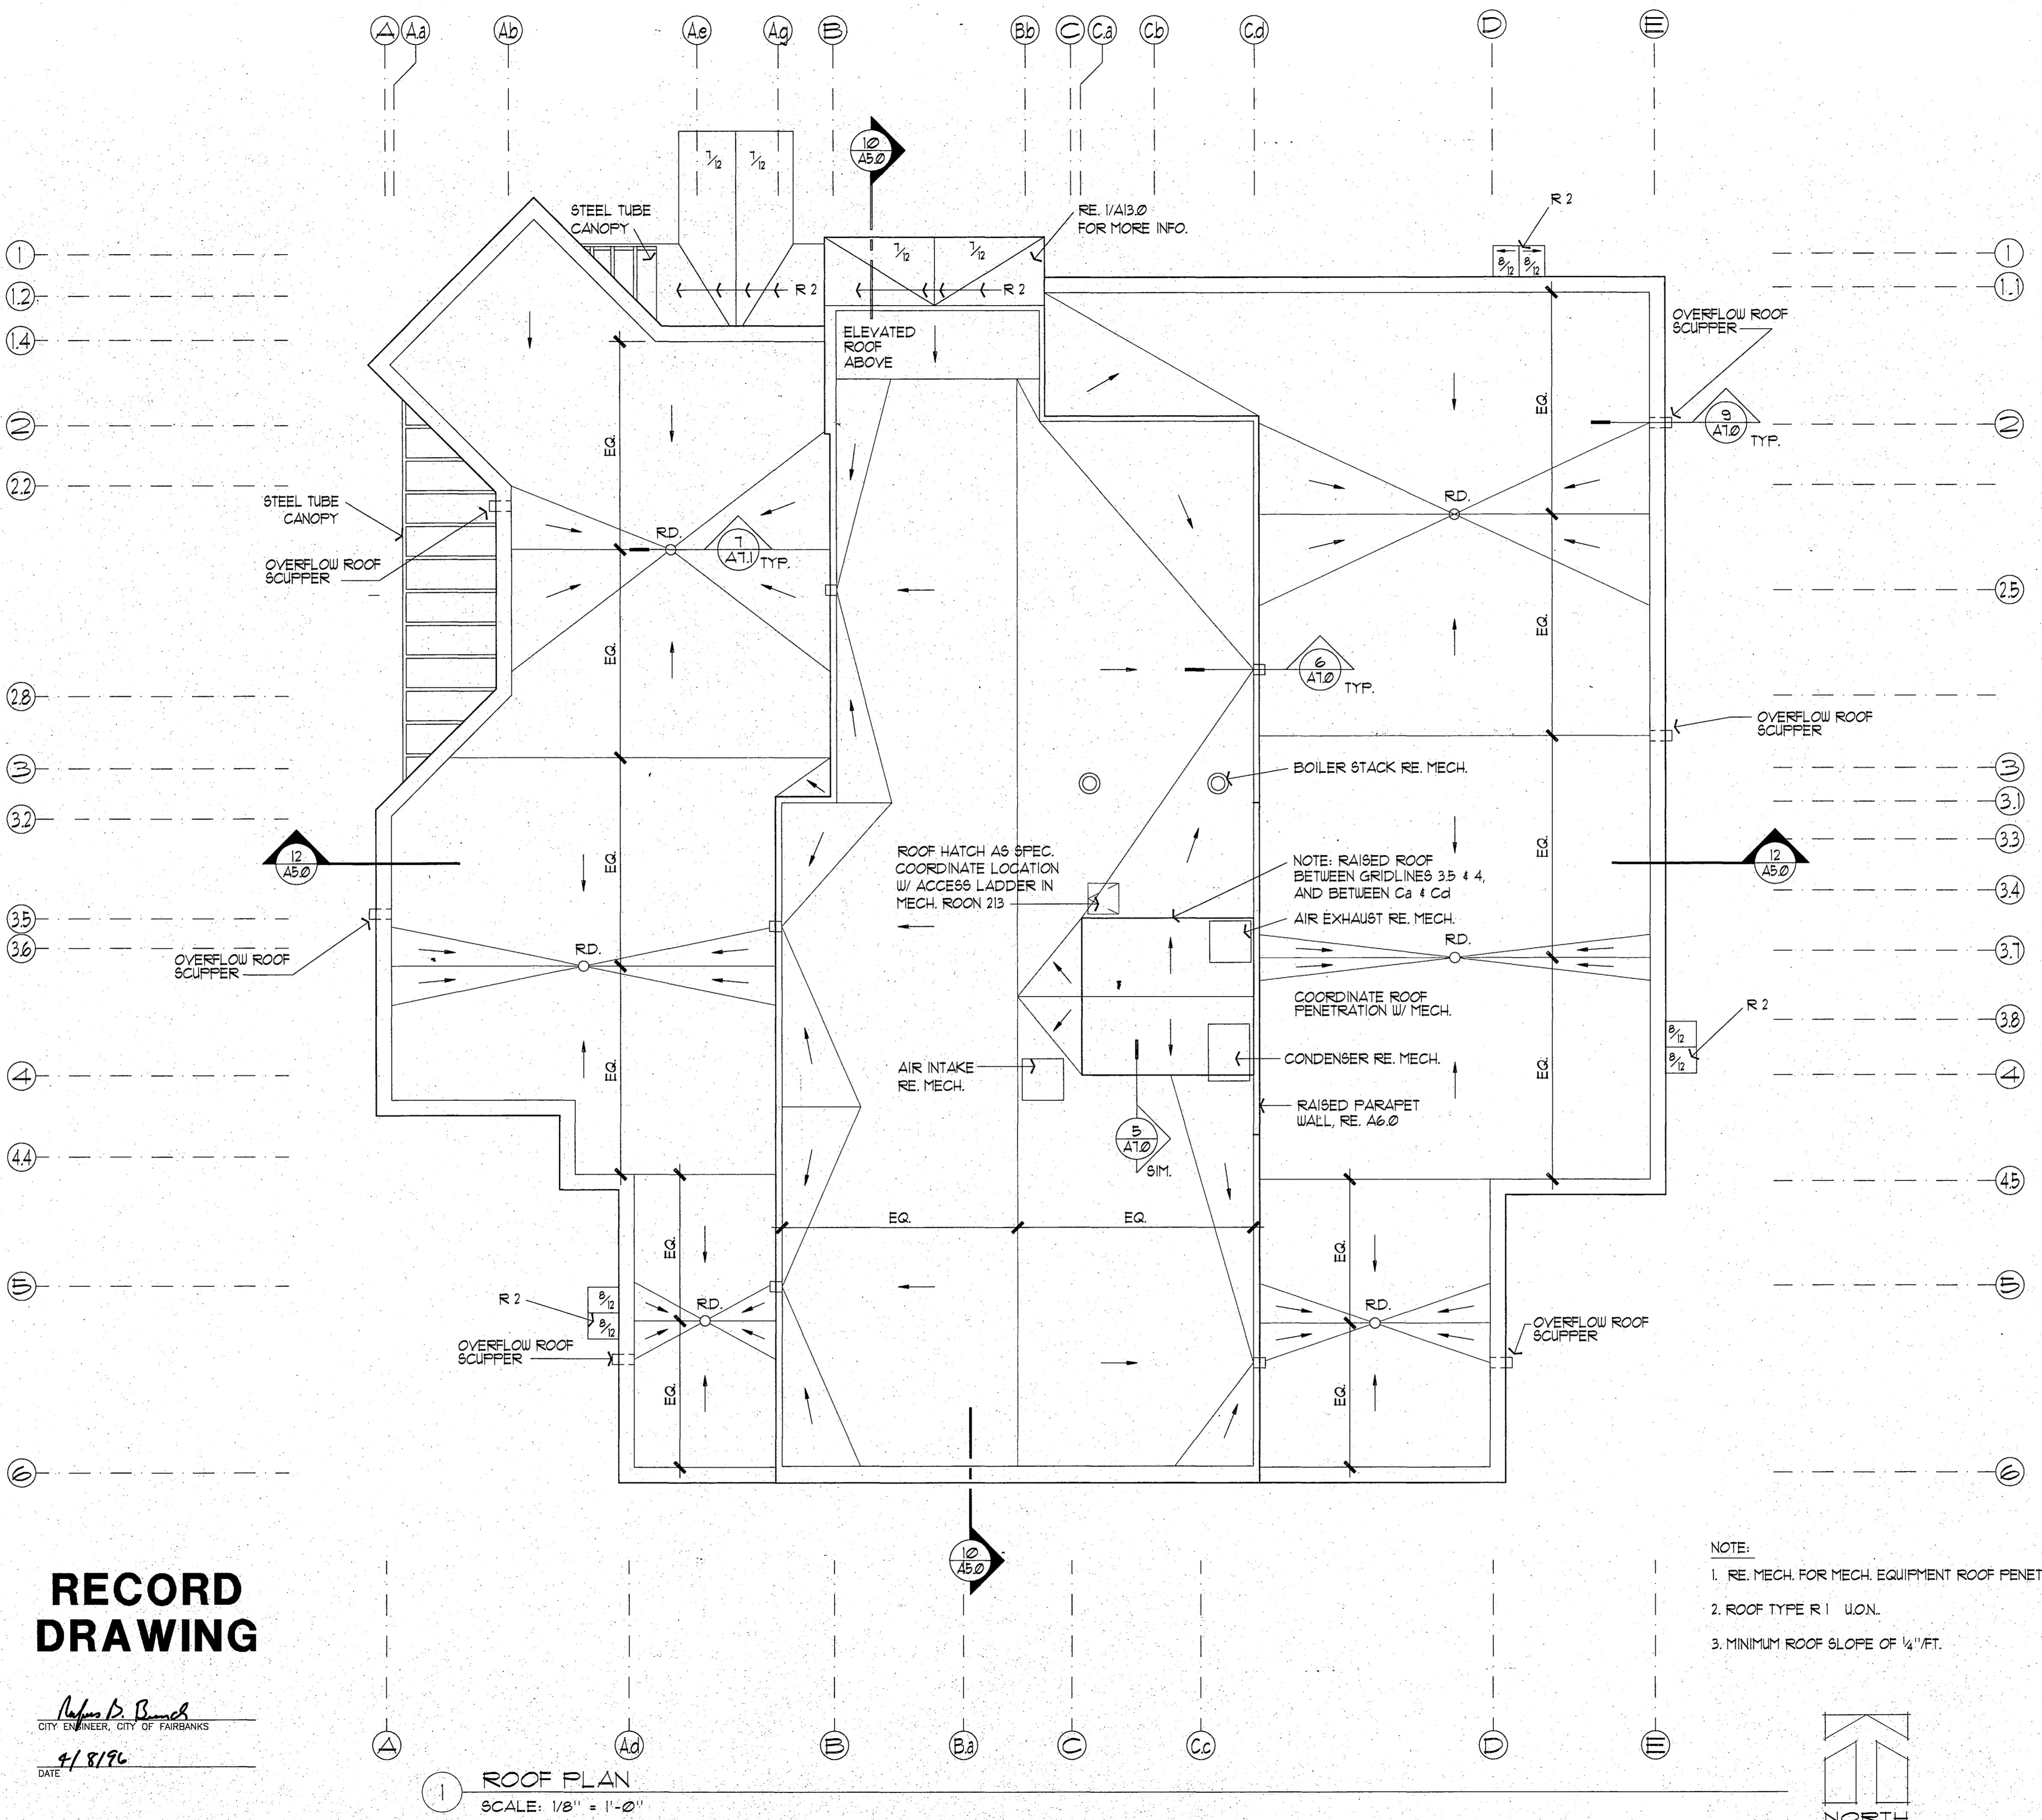

City of Fairbanks

Fairbanks, Alaska


Fairbanks, Alaska



# RECORD DRAWING


Rufus B. Bush  
CITY ENGINEER, CITY OF FAIRBANKS

DATE  
4/14/96

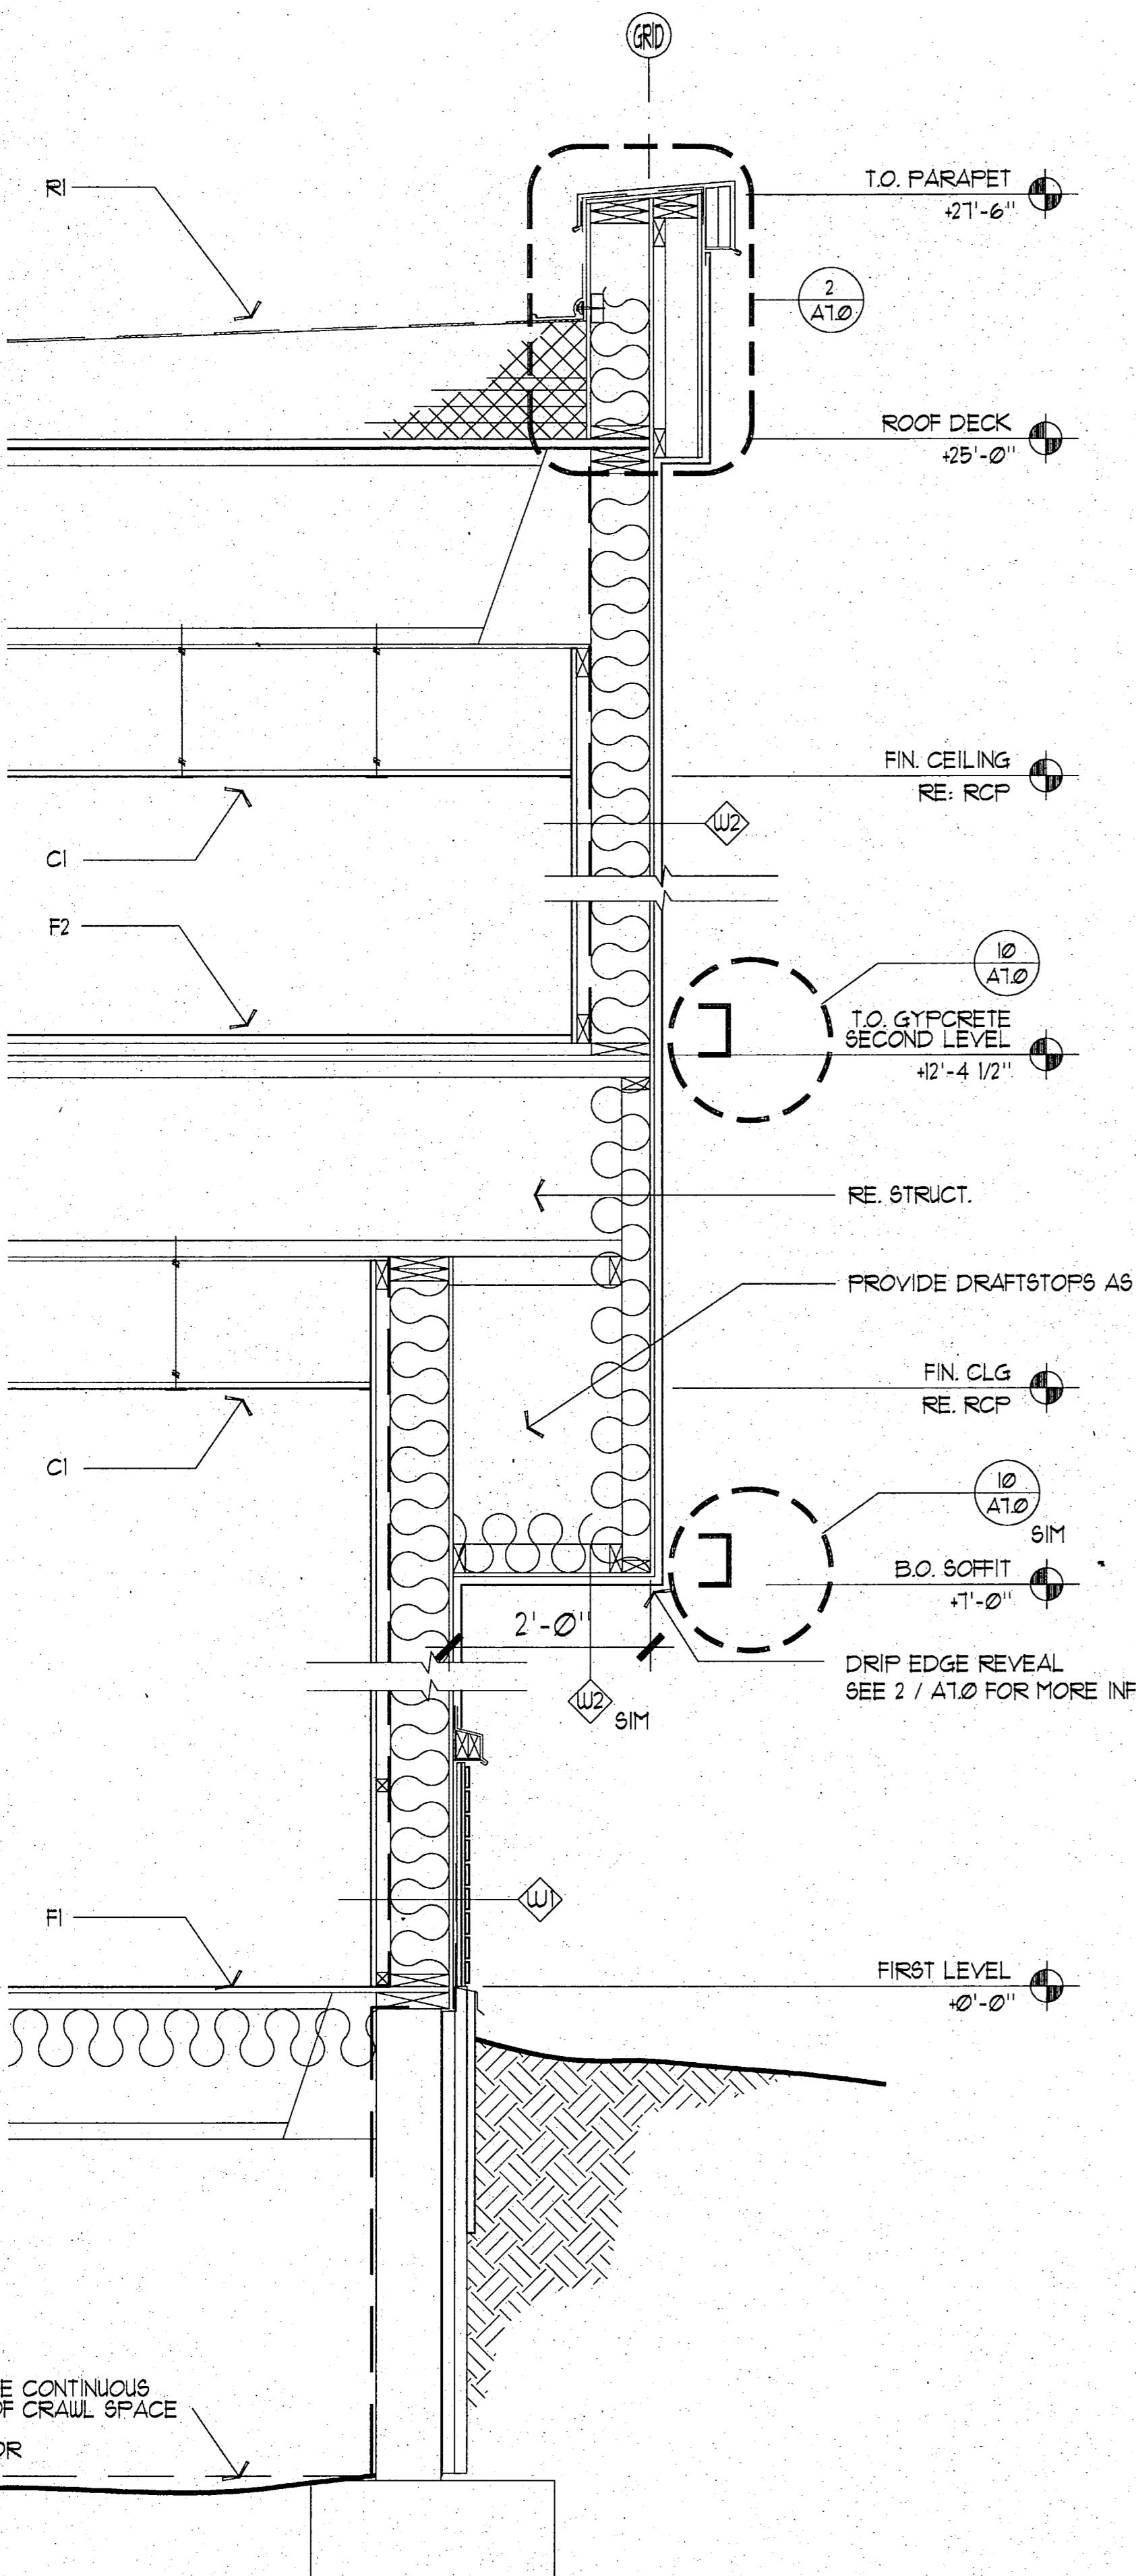


13 WALL SECTION

SCALE: 3/4" = 1'-0"

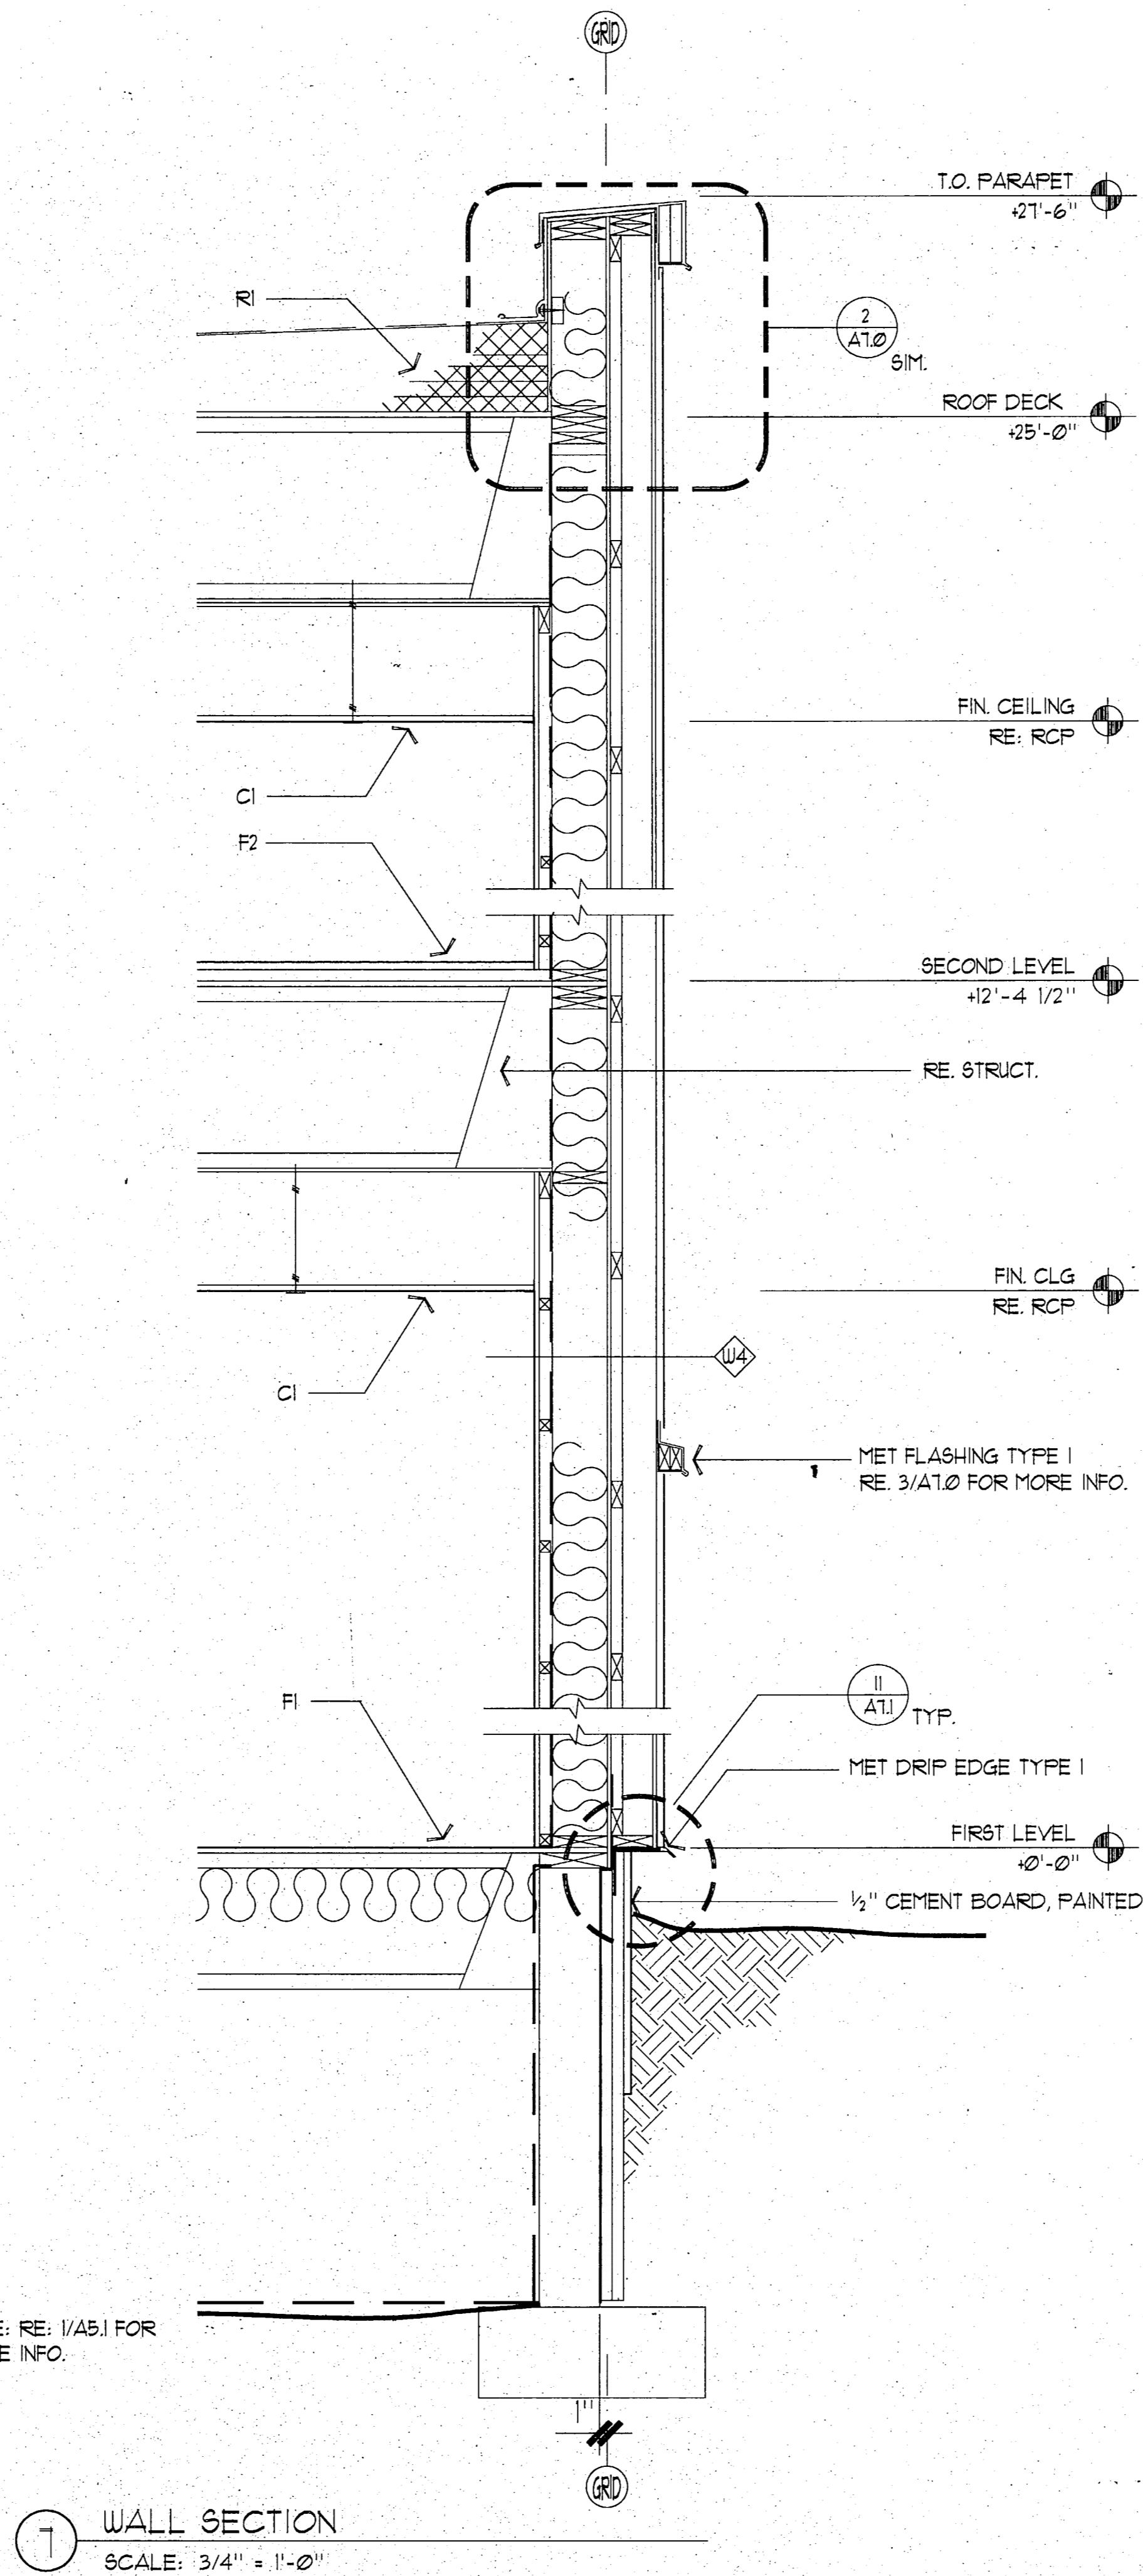

17 WALL SECTION

SCALE: 3/4" = 1'-0"

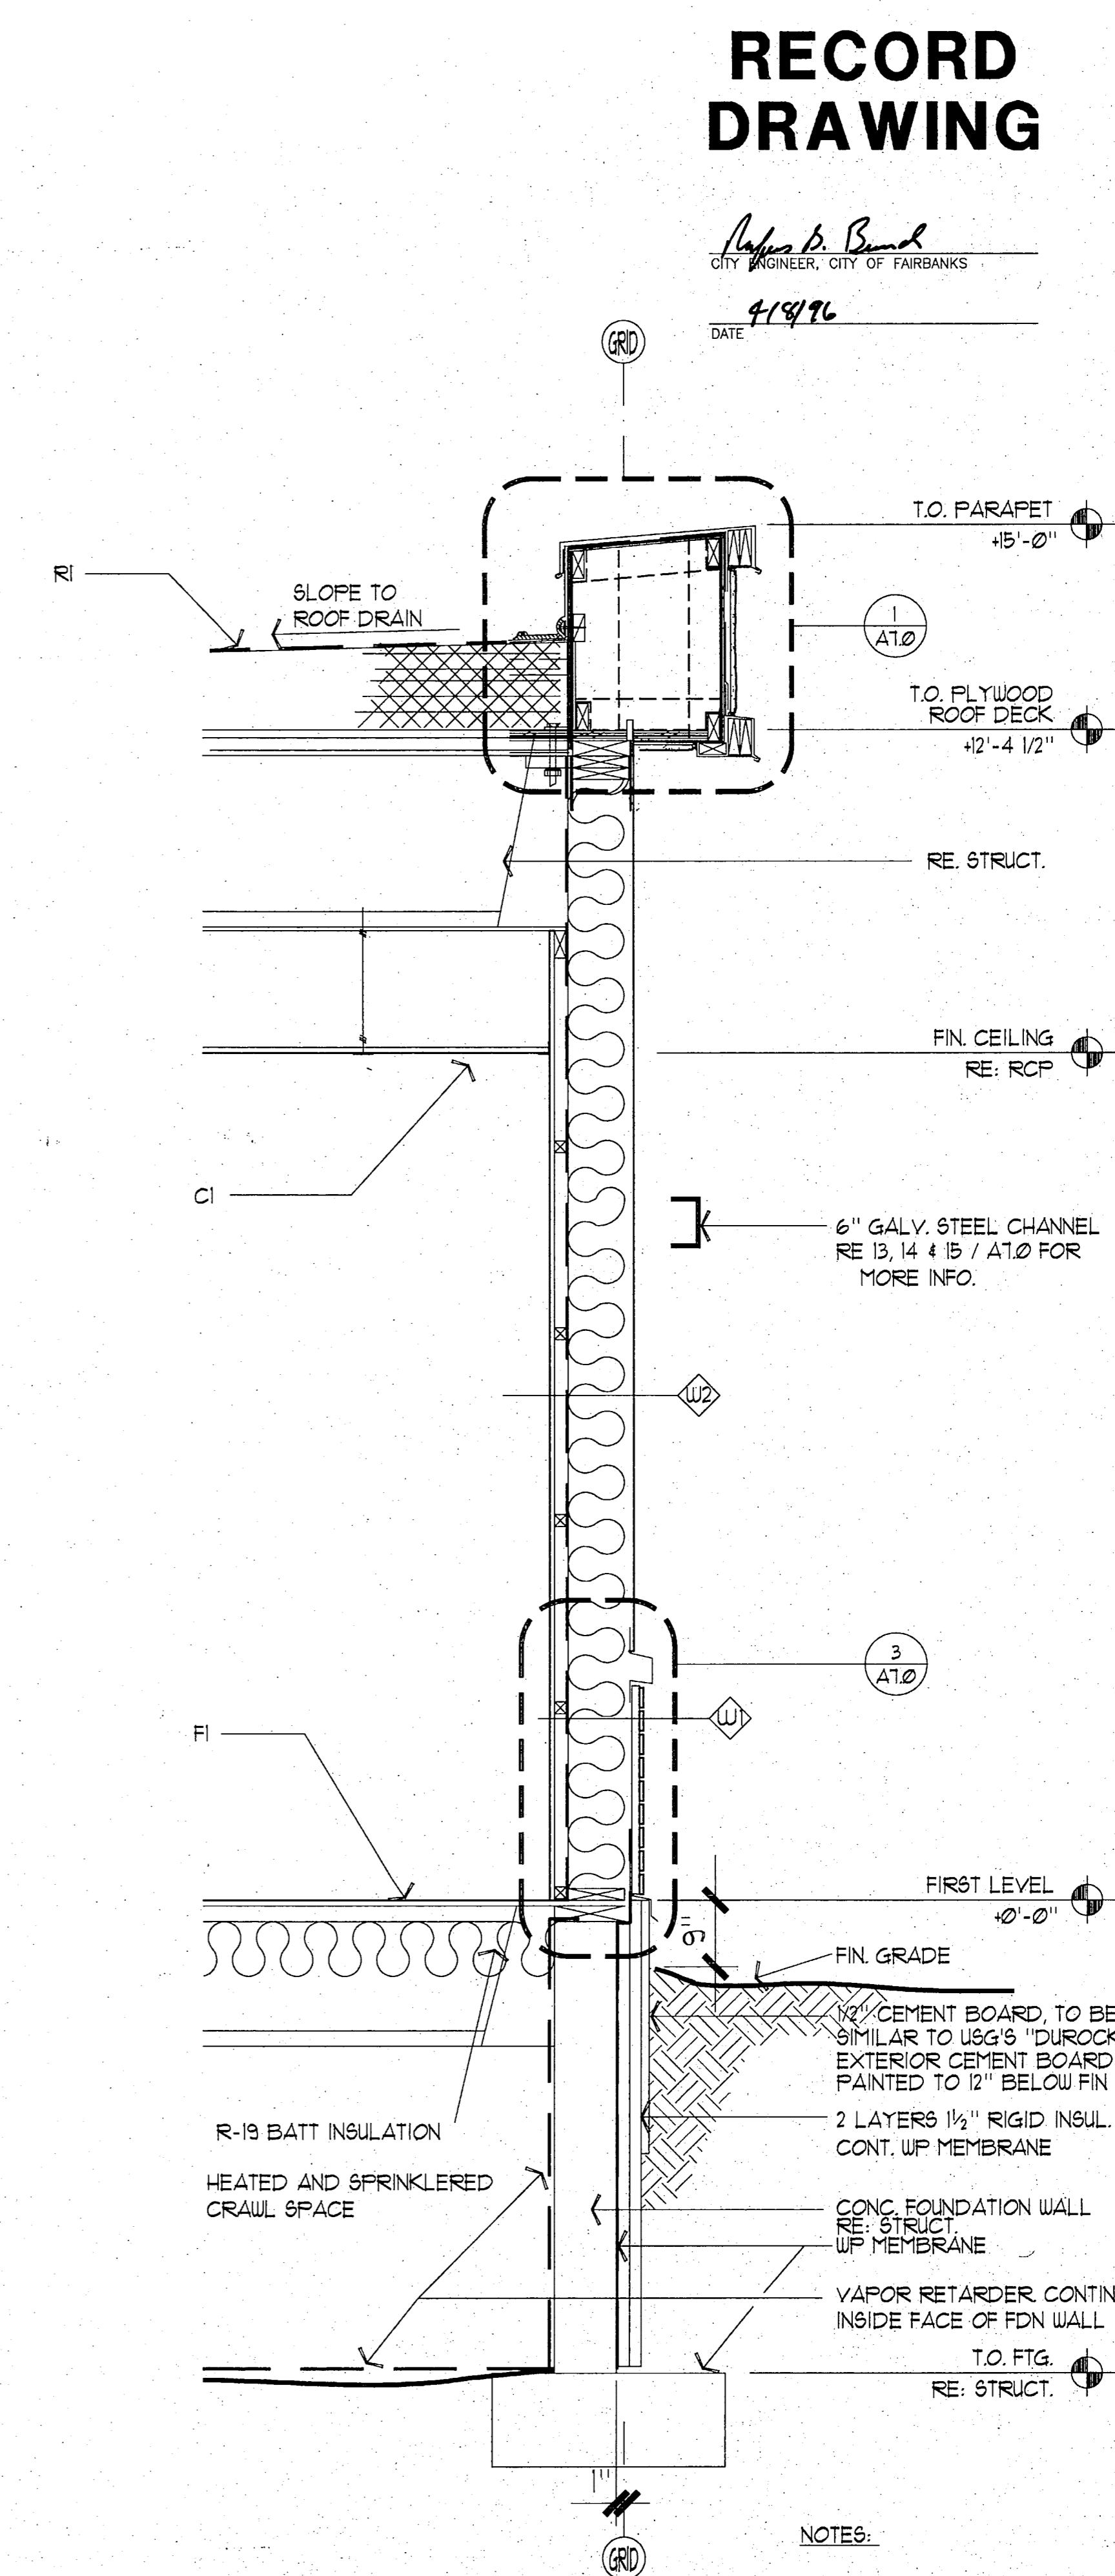

1 TYPICAL WALL SECTION

SCALE: 3/4" = 1'-0"

**LIVINGSTON**  
**SLOWNE**

Architecture Engineering  
Interior Design Planning

incorporated

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(907) 562-2055



PROJECT NO. 115.00

DRAWN BY JB

CHECKED BY JB/JA

DATE DEC. 9, 1992

REVISED

TITLE  
WALL  
SECTIONS

SHEET NO.

A5.1


Fairbanks  
FAIRBANKS HEALTH CENTER

City of Fairbanks

Fairbanks, Alaska

**LIVINGSTON**  
architecture Engineering  
interior Design Planning  
incorporated

3900 Arctic Blvd. Suite 301  
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(907) 562-2058

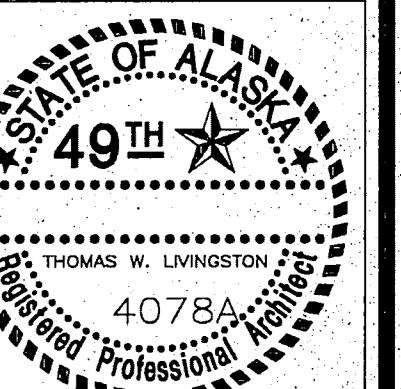


PROJECT NO. 115.00  
DRAWN BY JB,JA,ALS  
CHECKED BY JB,JA  
DATE DEC 9, 1992  
REVISED

TITLE  
EXTERIOR  
ELEVATIONS

SHEET NO.


A6.0

F3.0.080

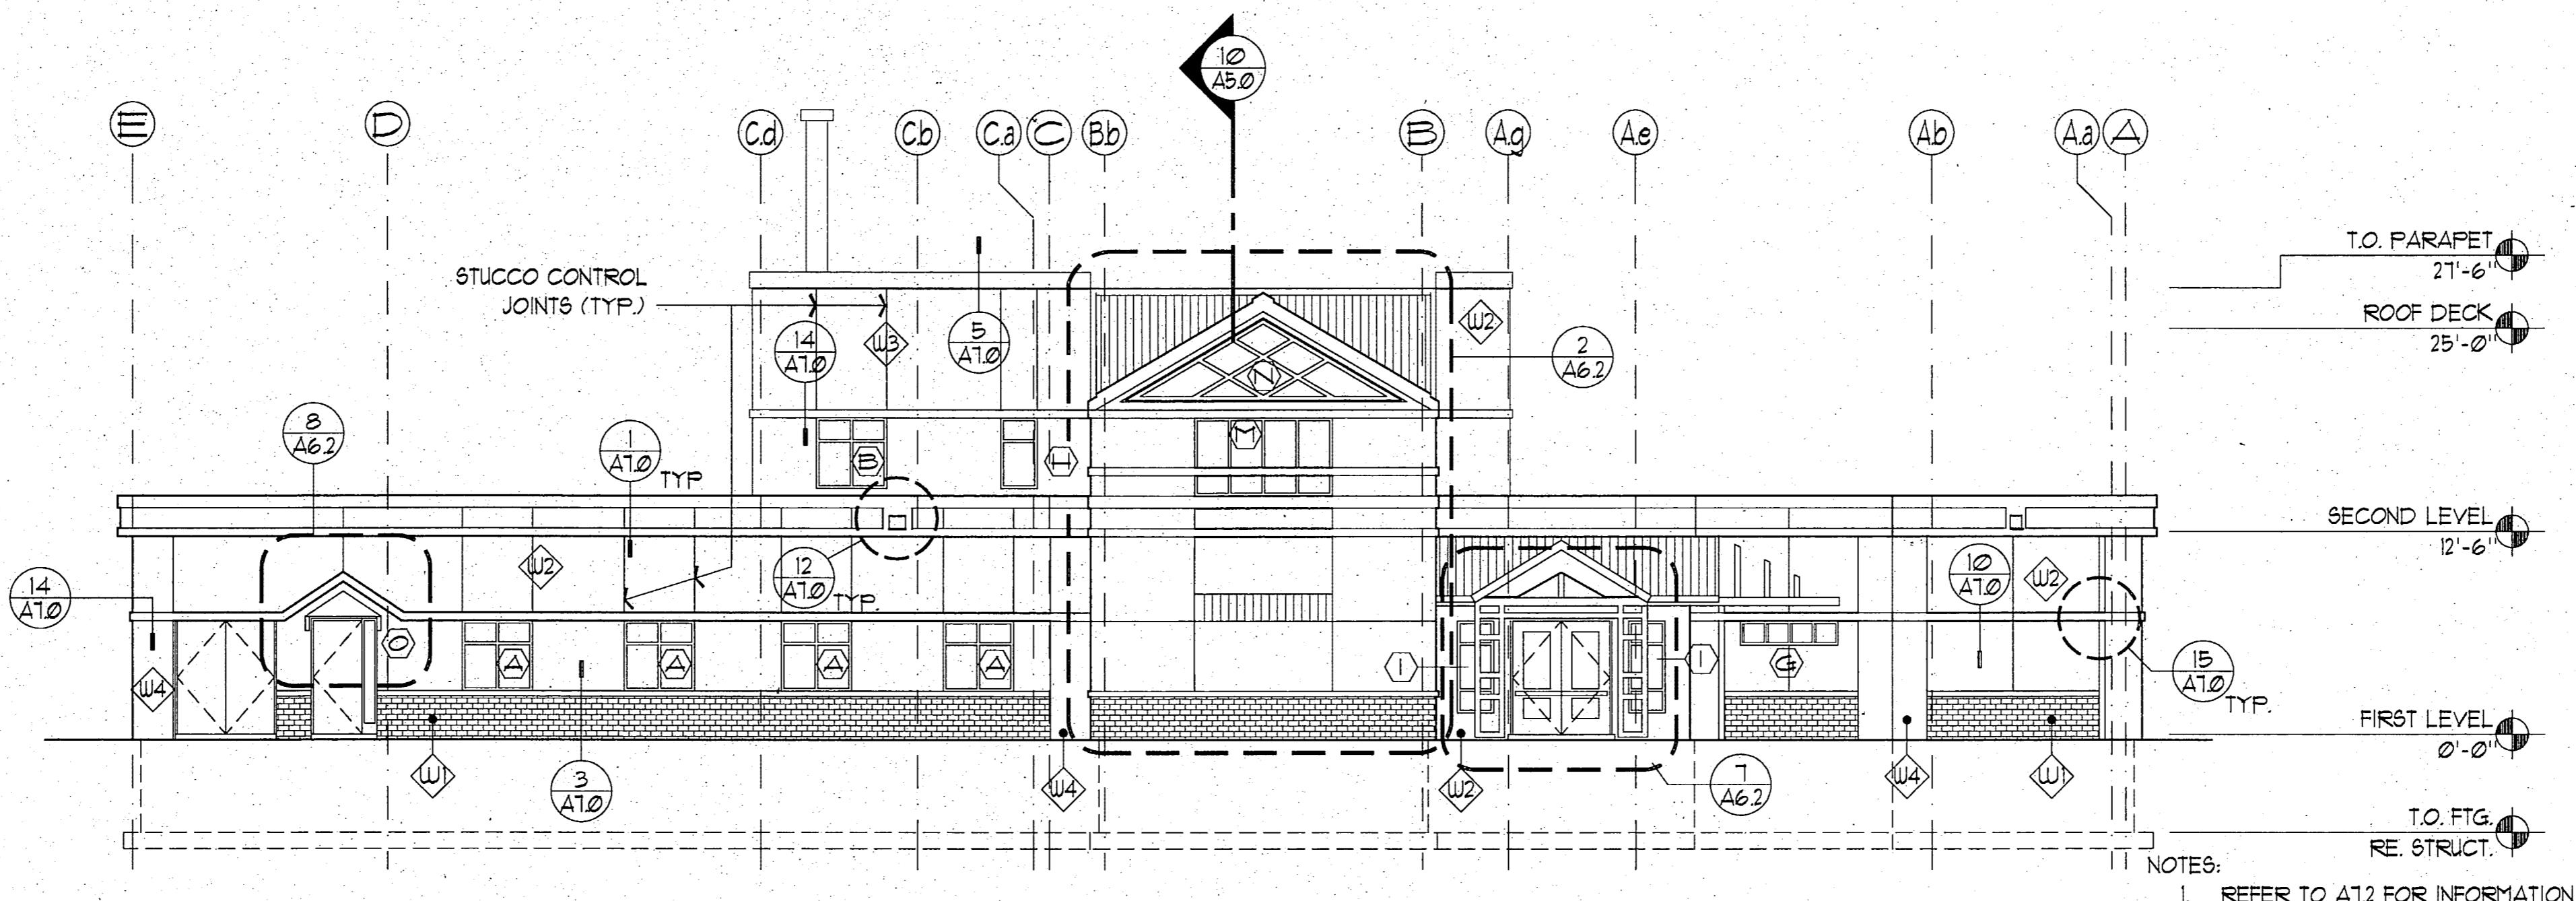

12 NORTH ELEVATION

SCALE: 1/8" = 1'-0"

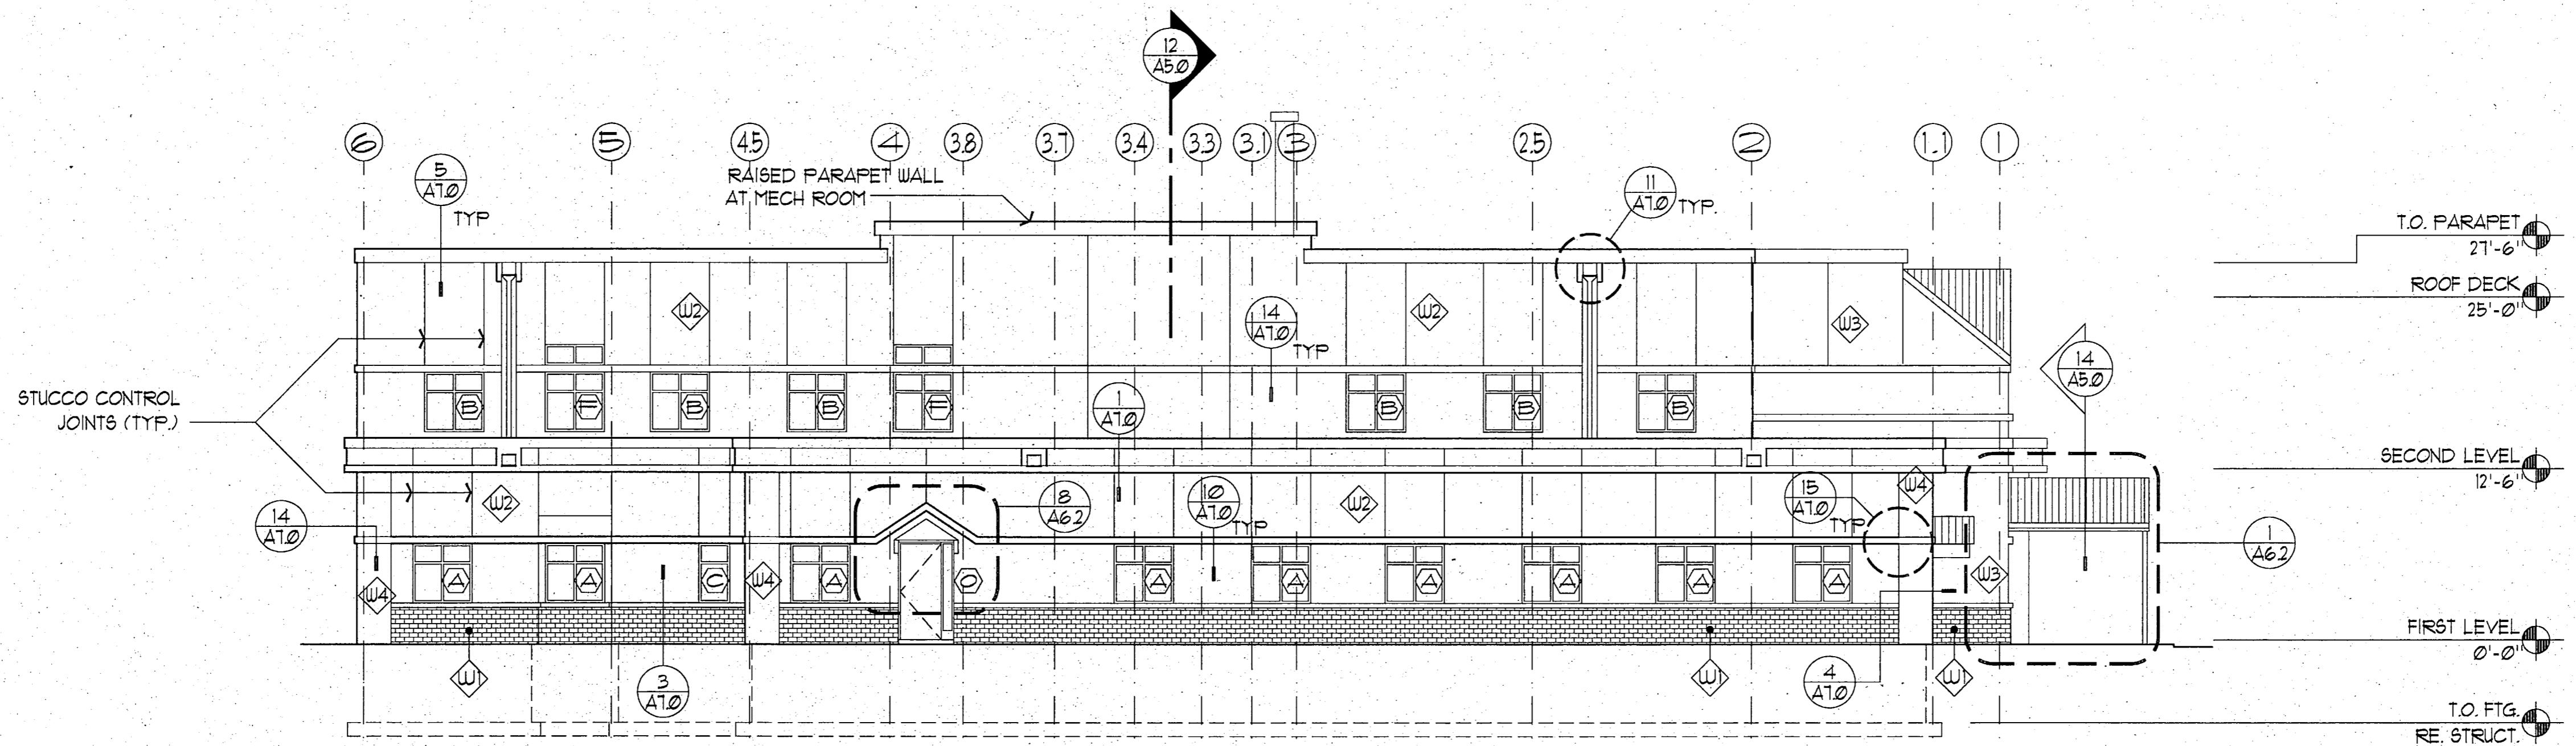

10 EAST ELEVATION

SCALE: 1/8" = 1'-0"

**RECORD  
DRAWING**


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CITY ENGINEER, CITY OF FAIRBANKS  
DATE 7/18/96

CITY OF FAIRBANKS  
FAIRBANKS HEALTH CENTER

LIVINGSTON  
STONE

Architecture Engineering  
Interior Design Planning

Incorporated  
3900 Arctic Blvd. Suite 301  
Anchorage, Alaska 99503-5790  
(907) 562-2058

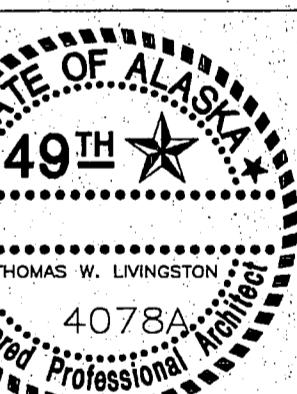

PROJECT NO. 115.00  
DRAWN BY JB  
CHECKED BY JB, JA  
DATE DEC 9, 1992  
REVISED



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EXTERIOR  
ELEVATIONS  
SHEET NO.






A6.1

CITY OF FAIRBANKS

Fairbanks, Alaska



F3.0.079

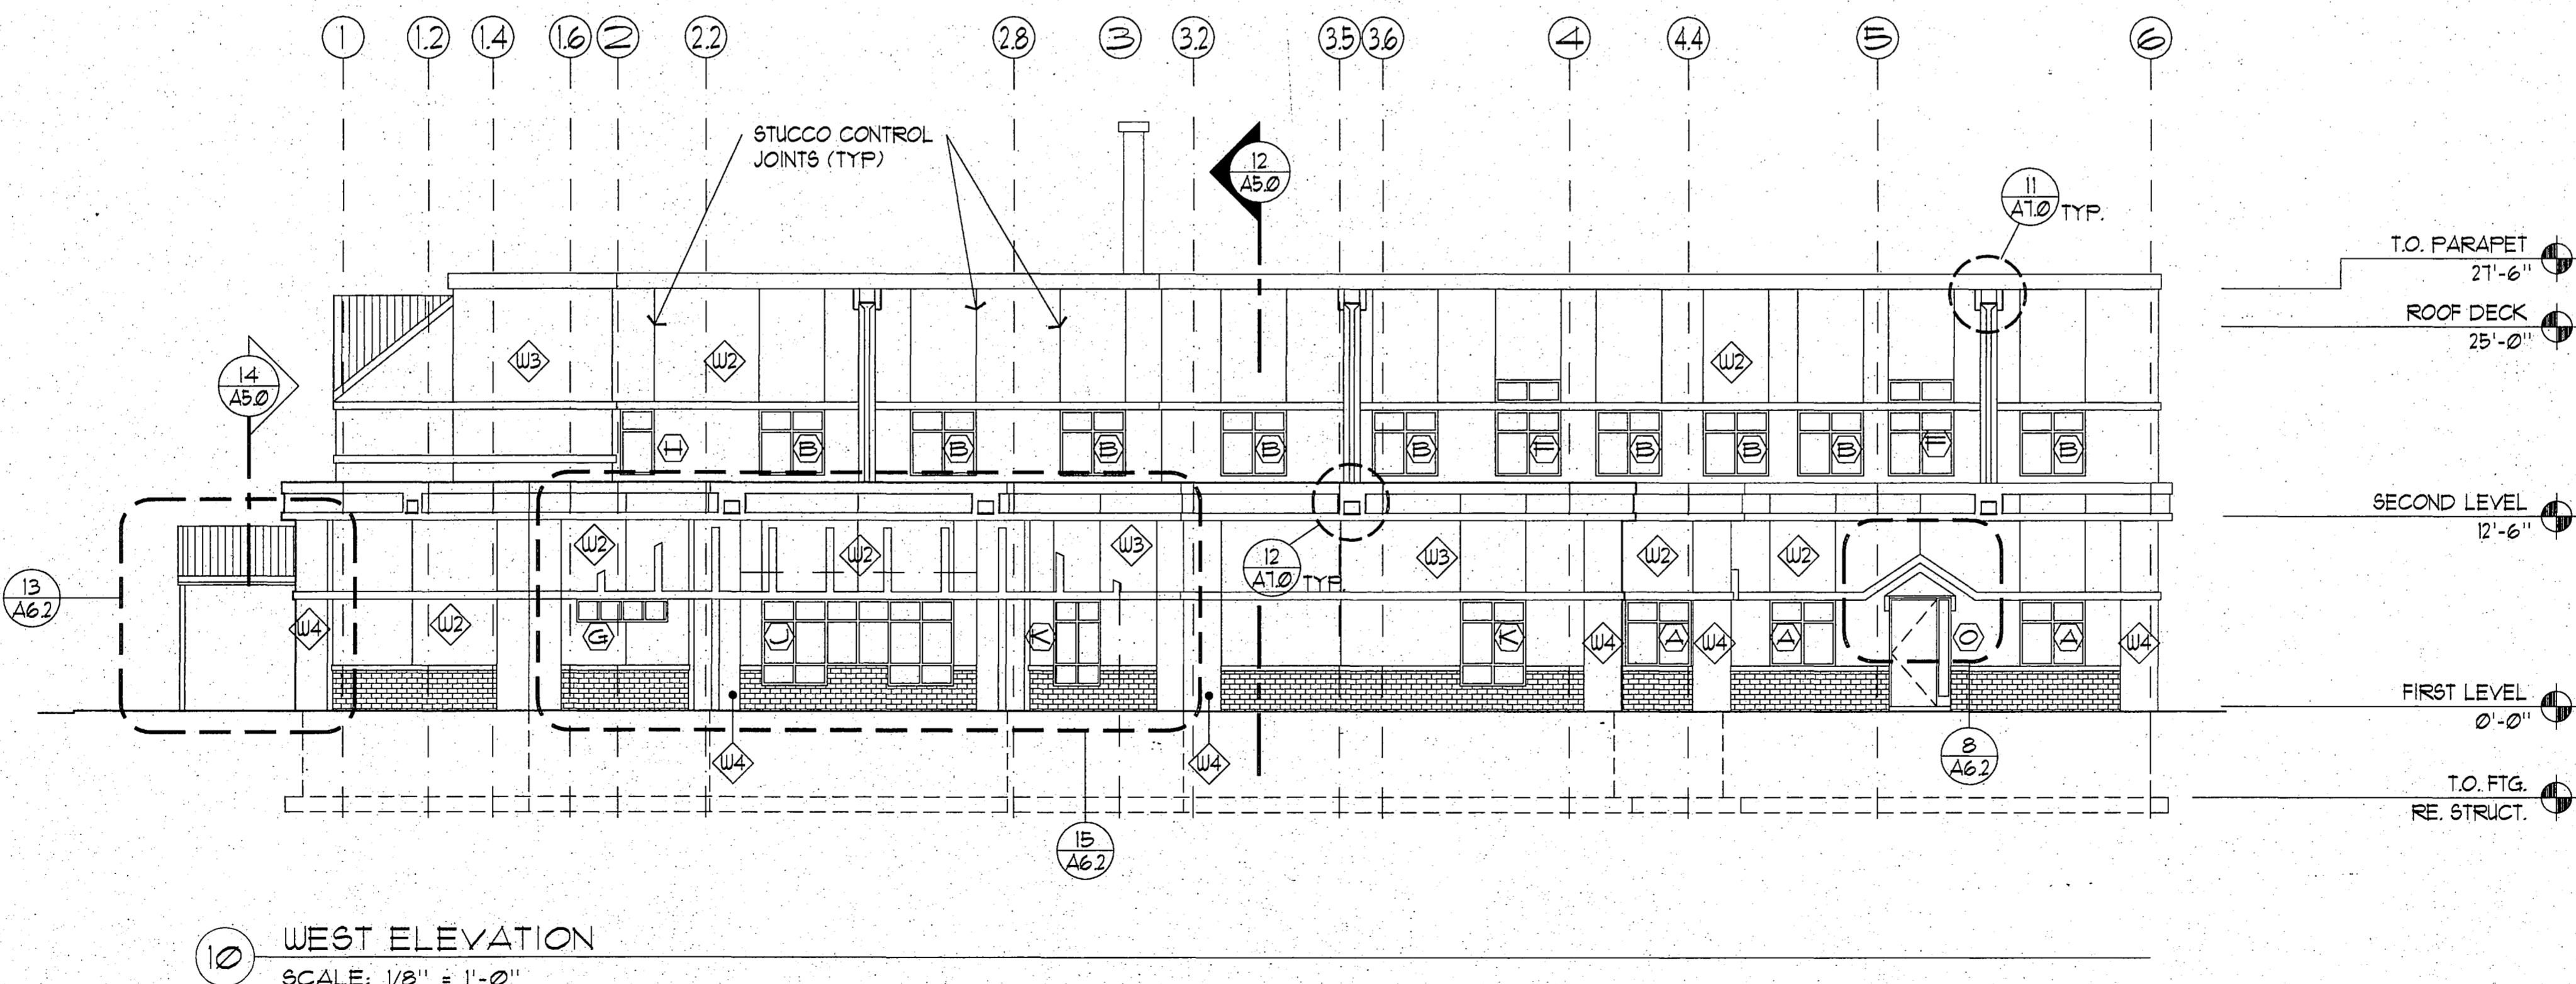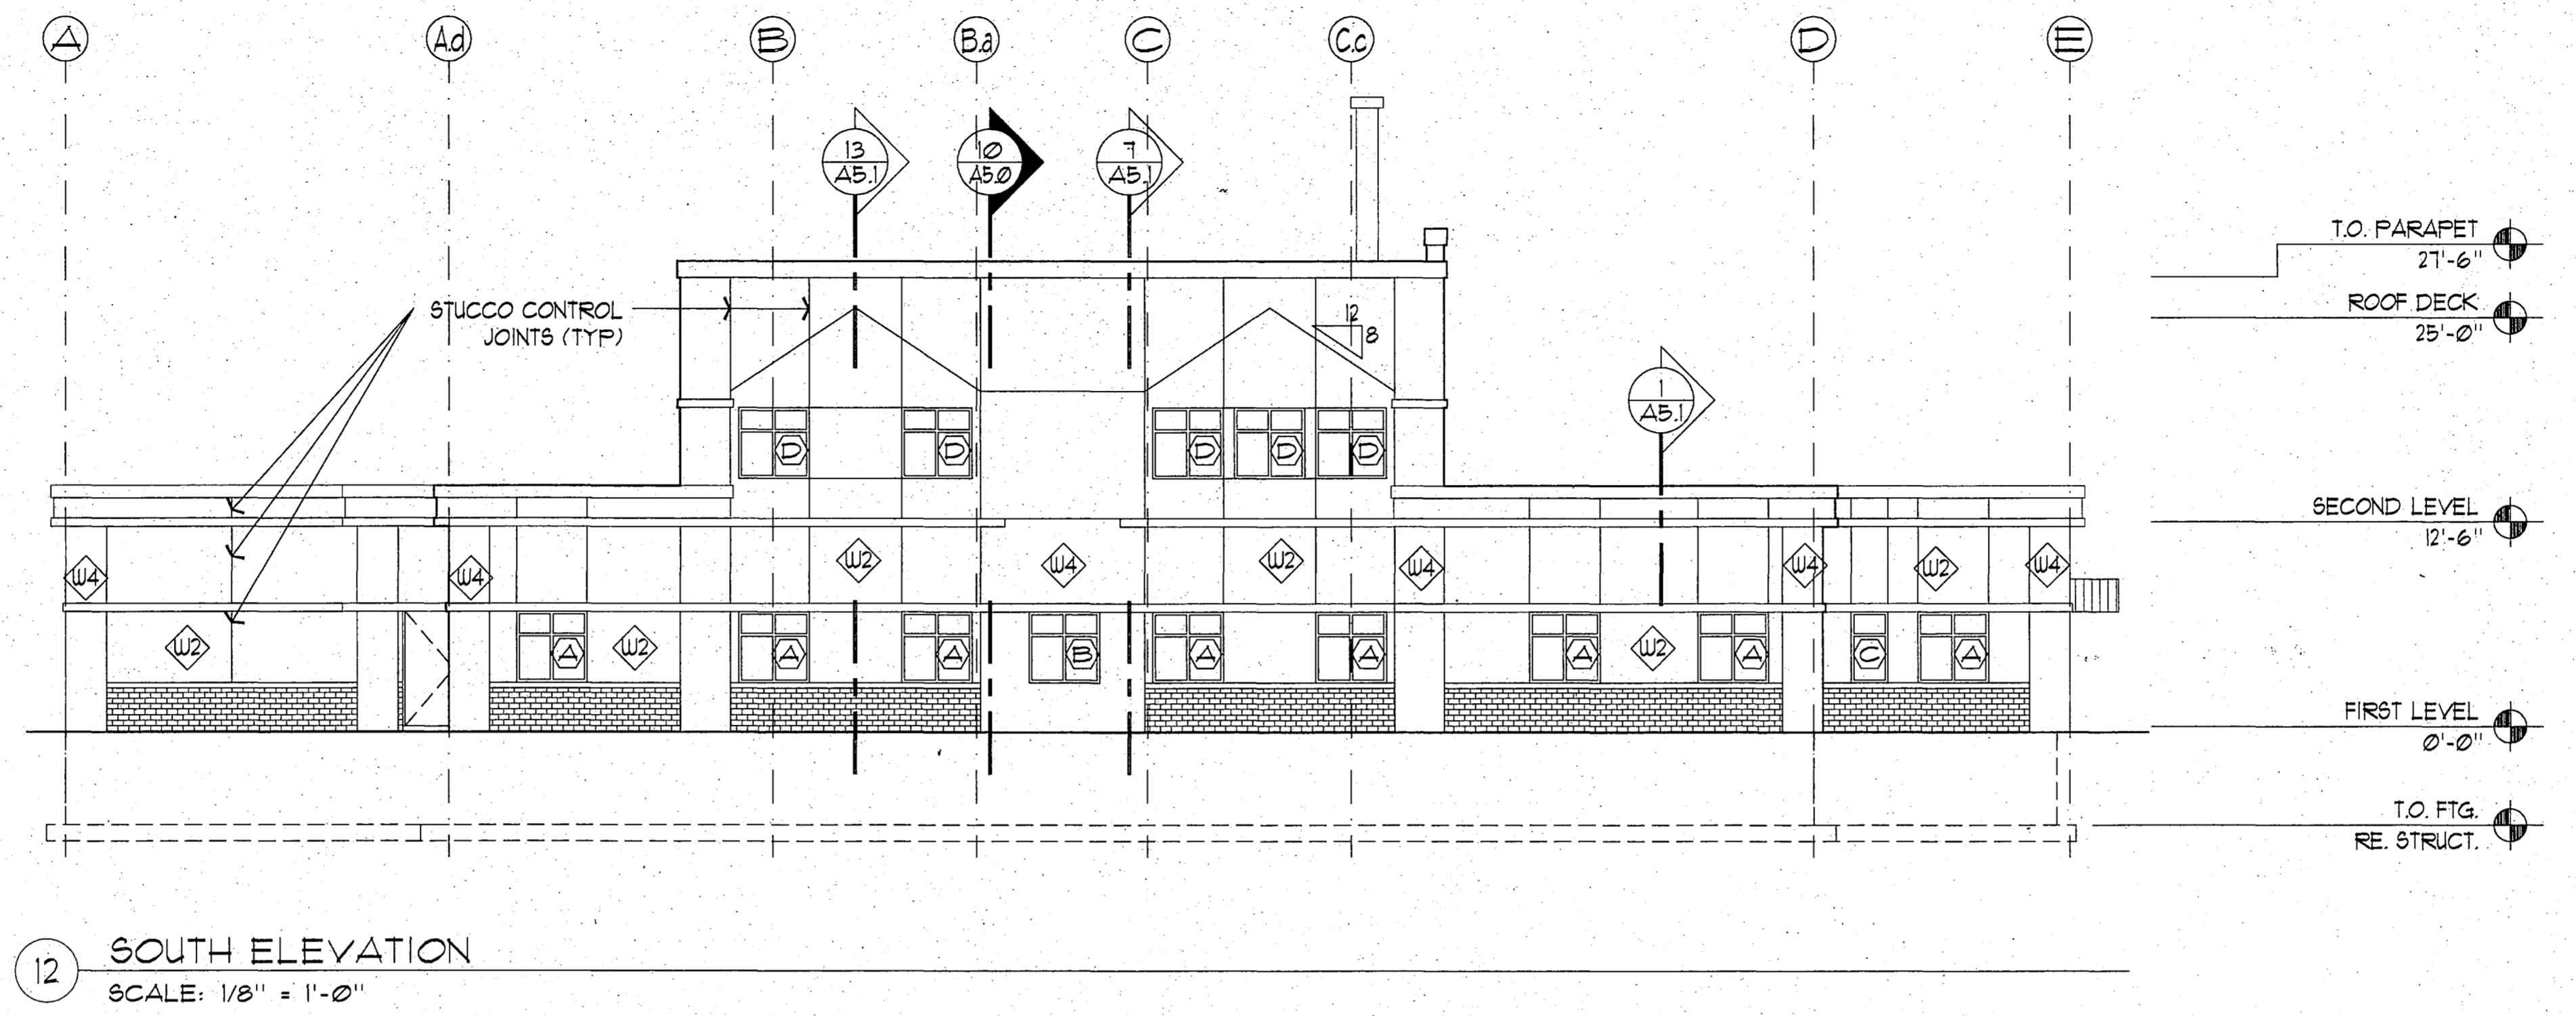

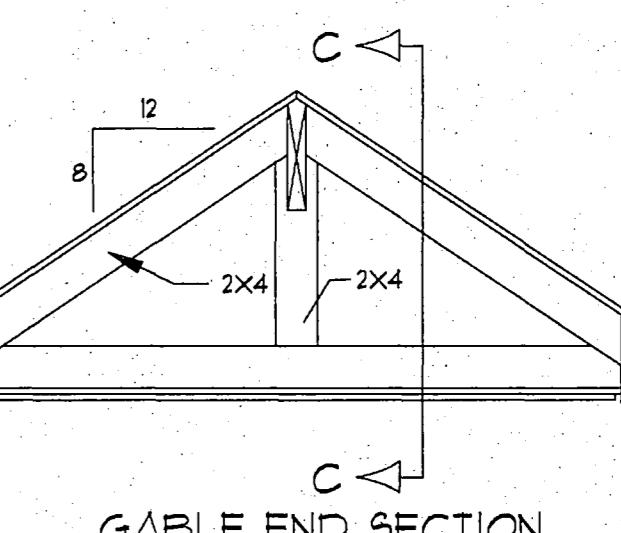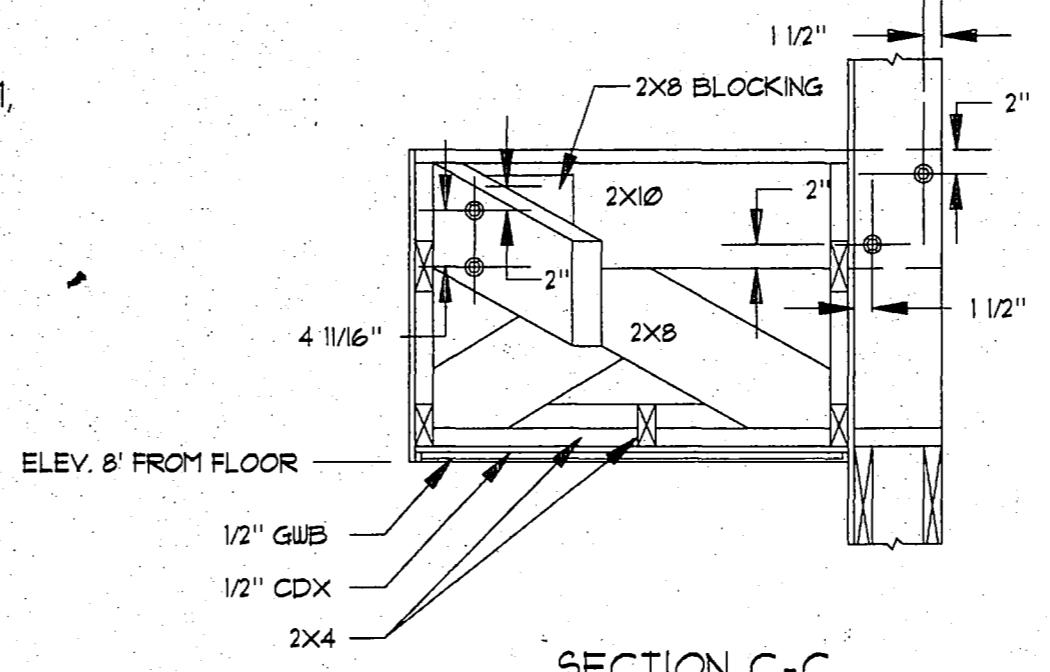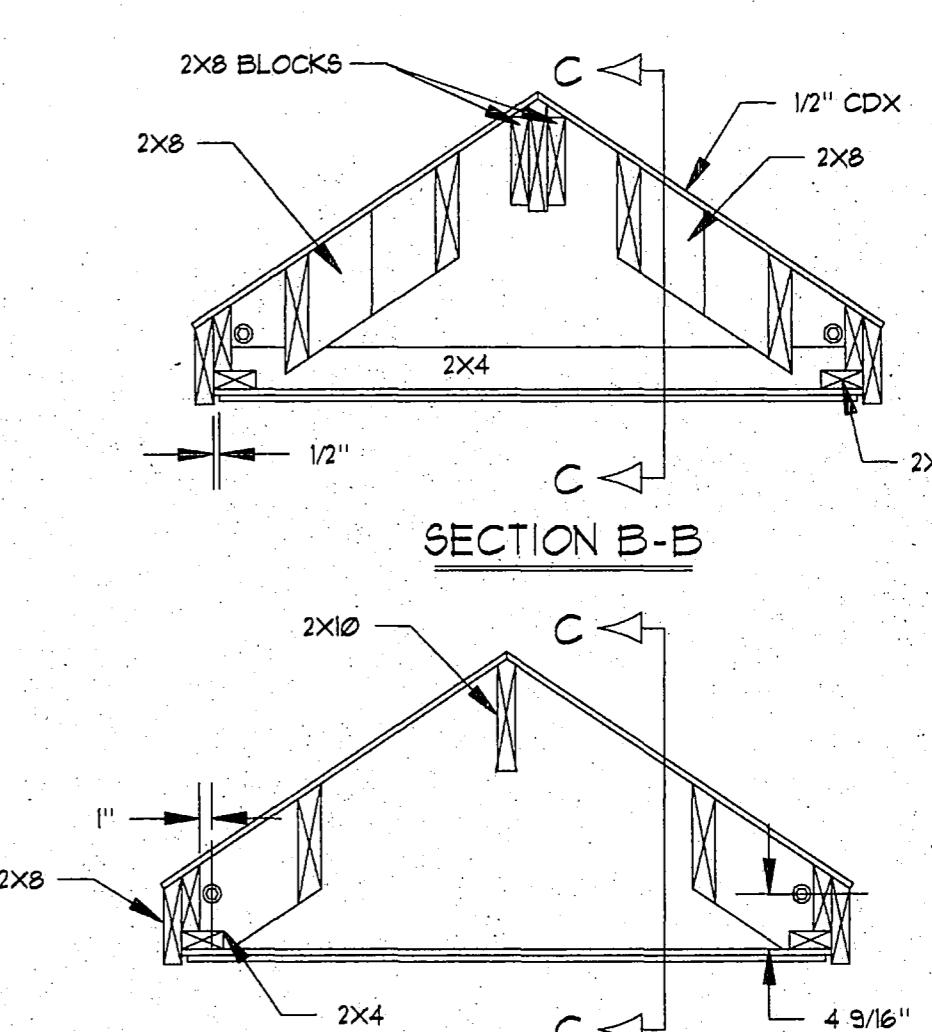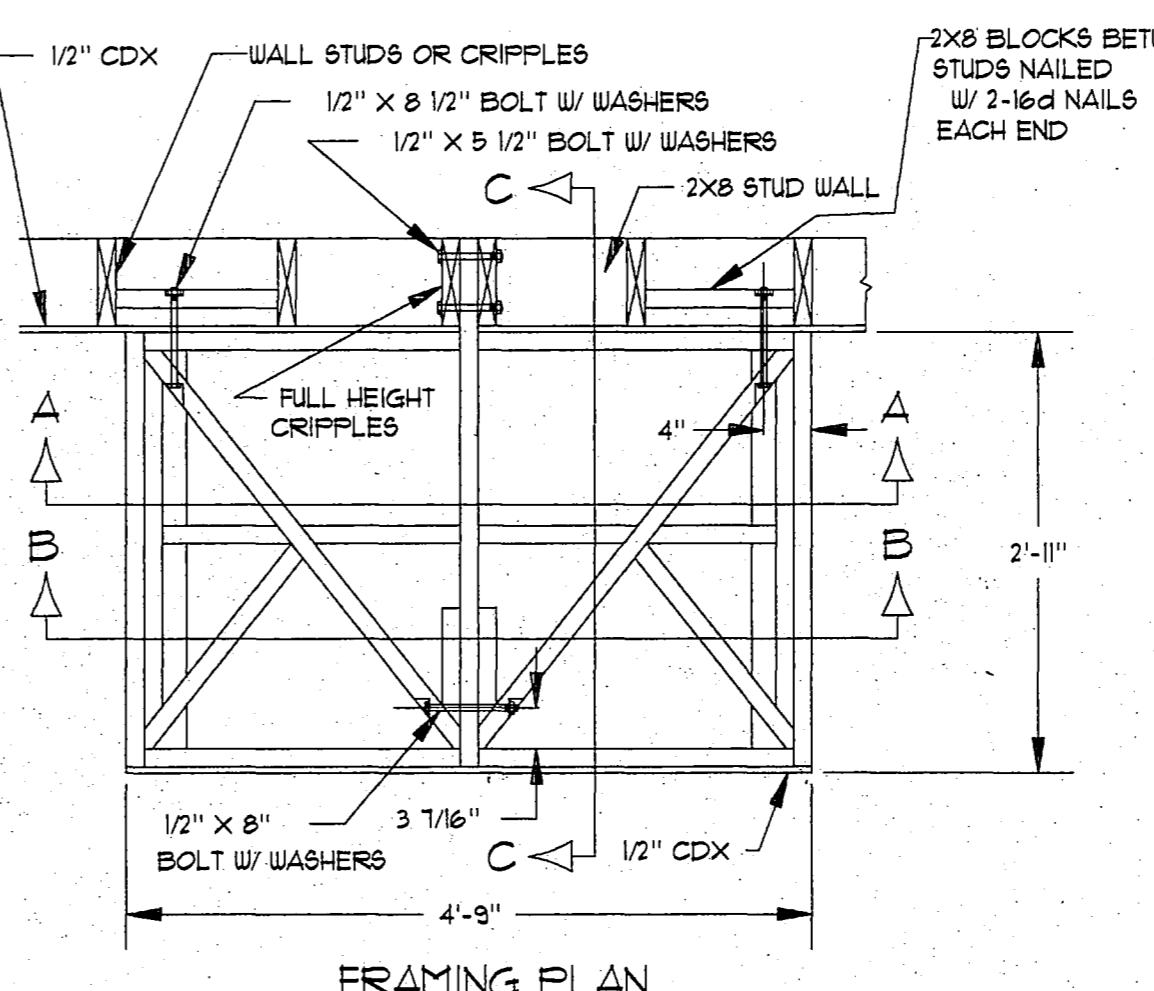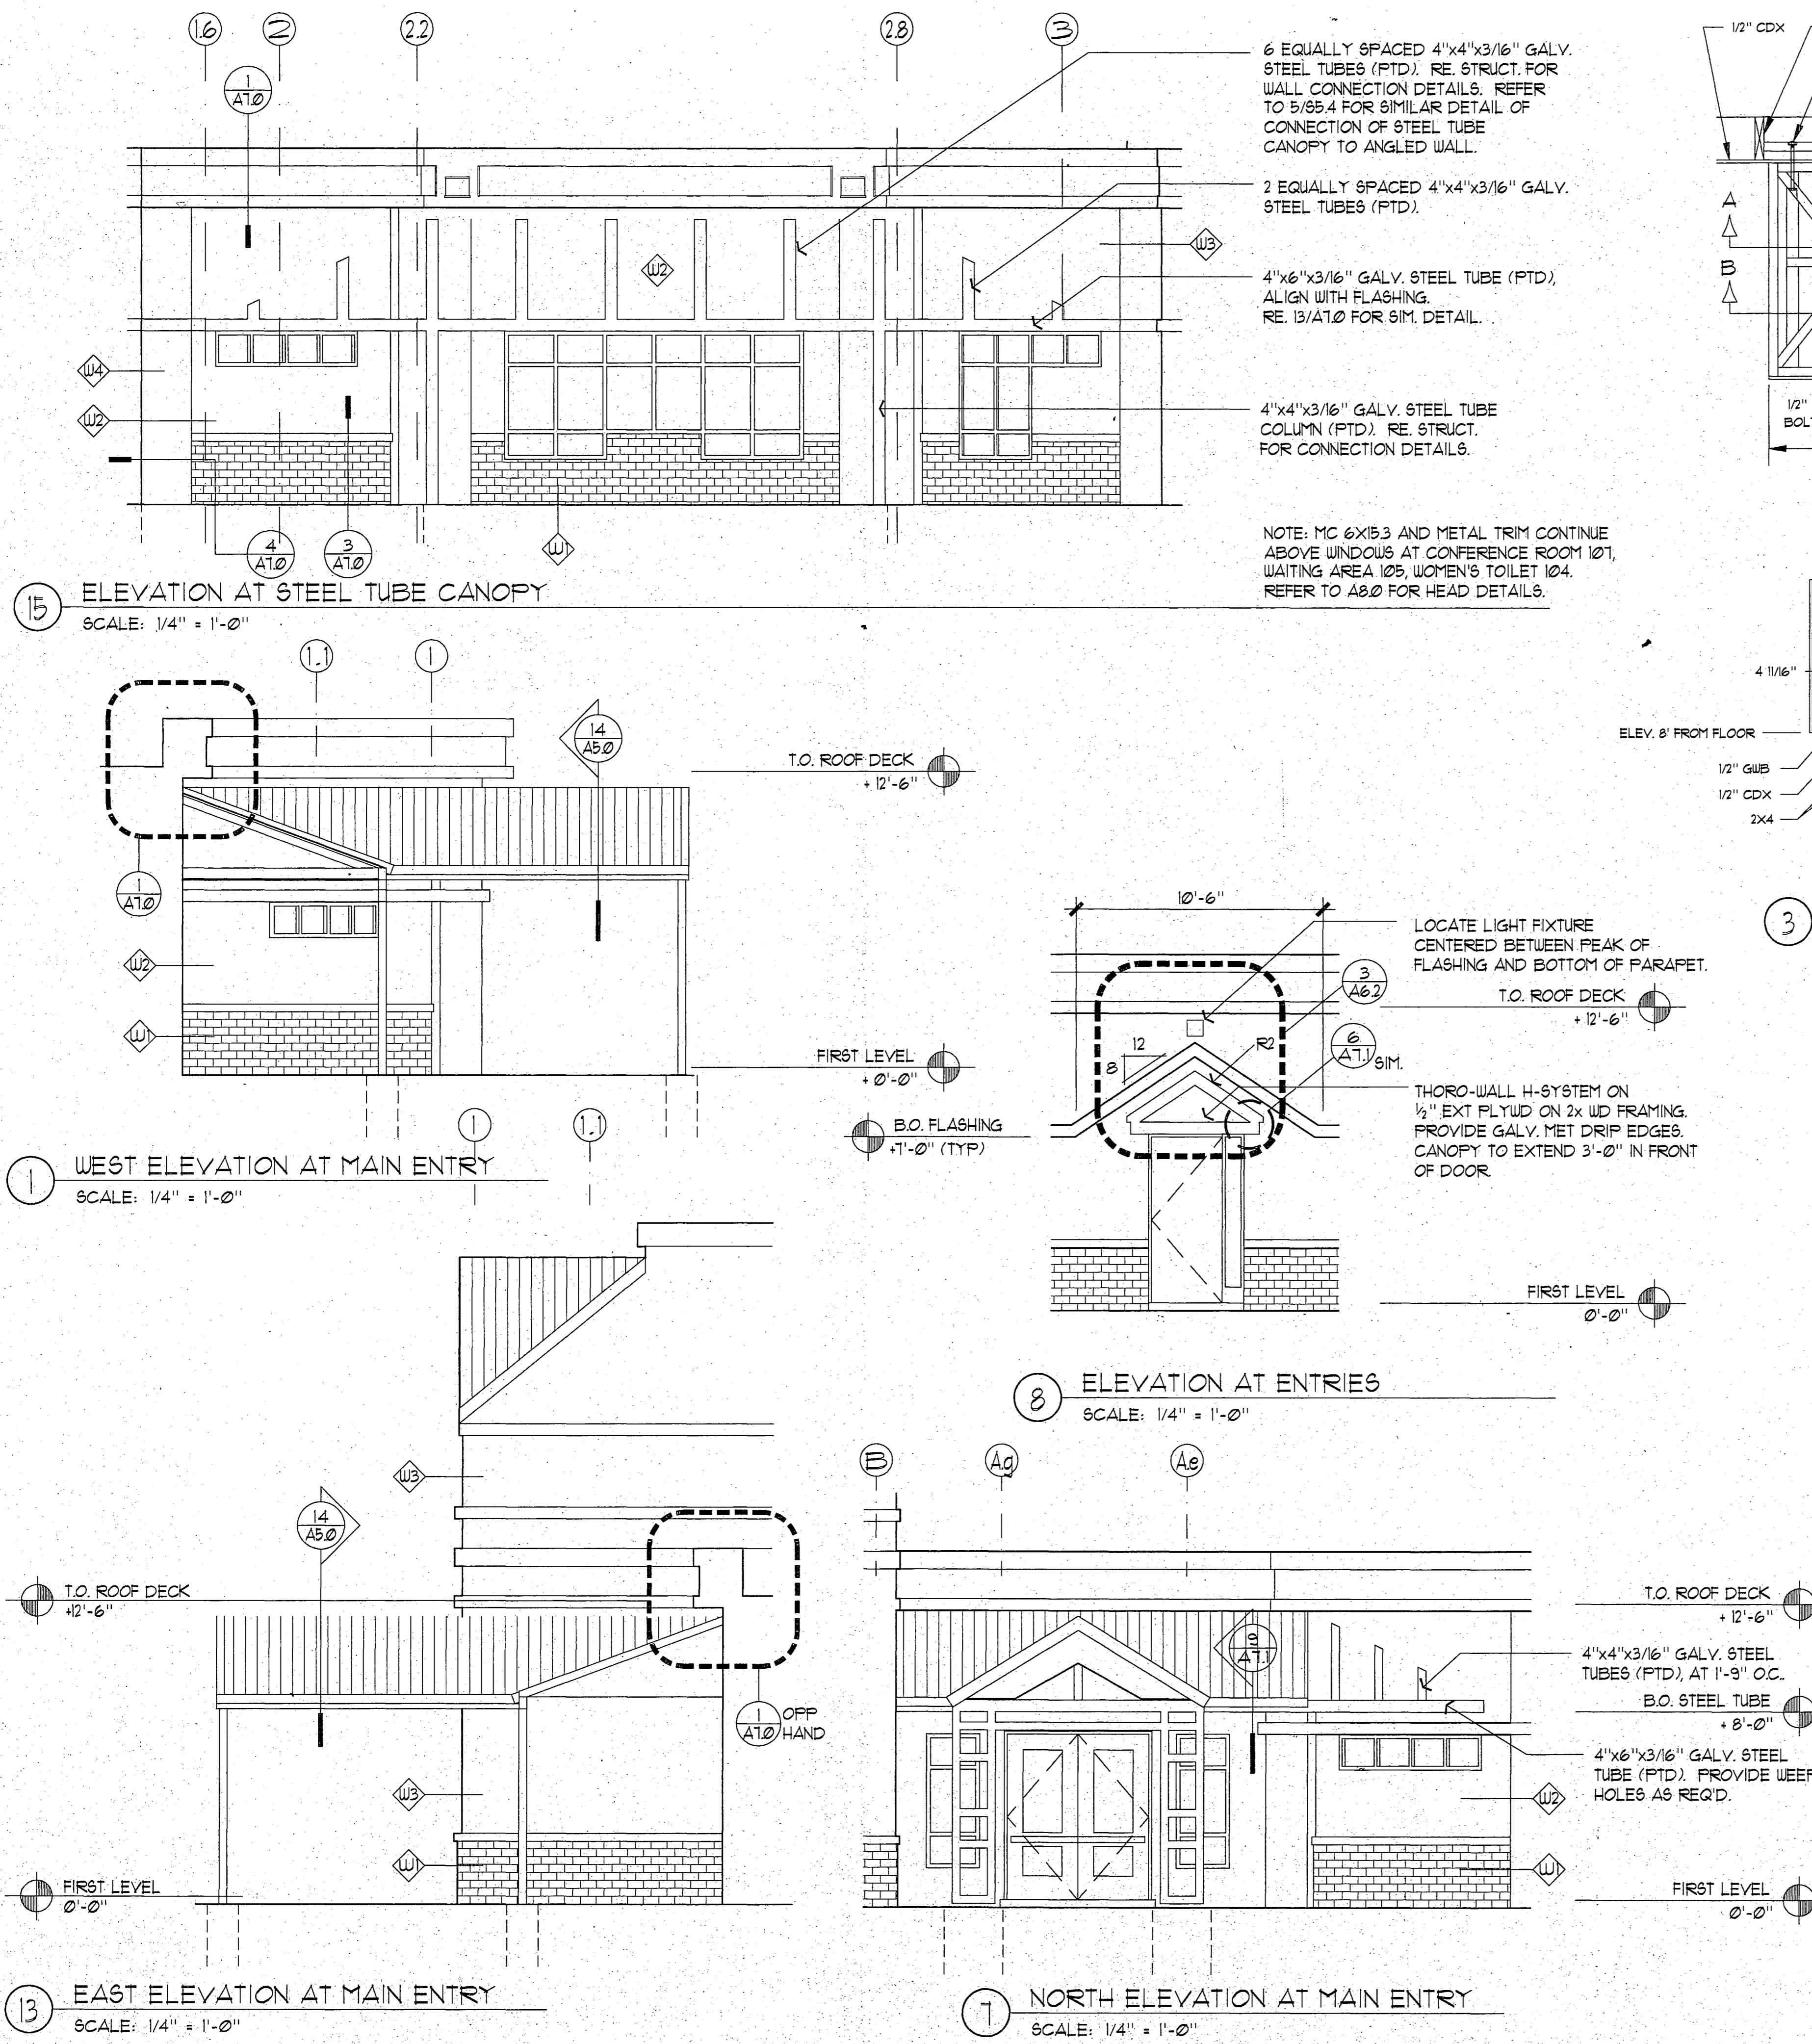

# **RECORD DRAWING**

Ralph B. Beaudry  
CITY ENGINEER, CITY OF FAIRBANKS  
4/8/96

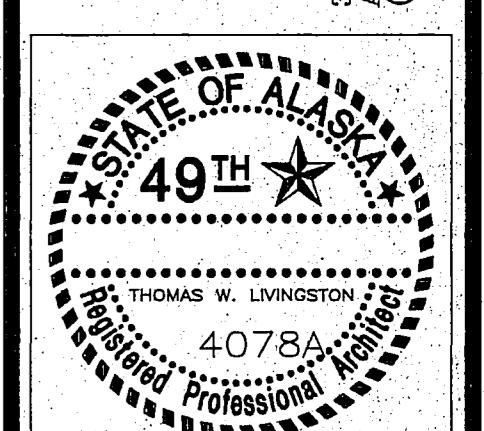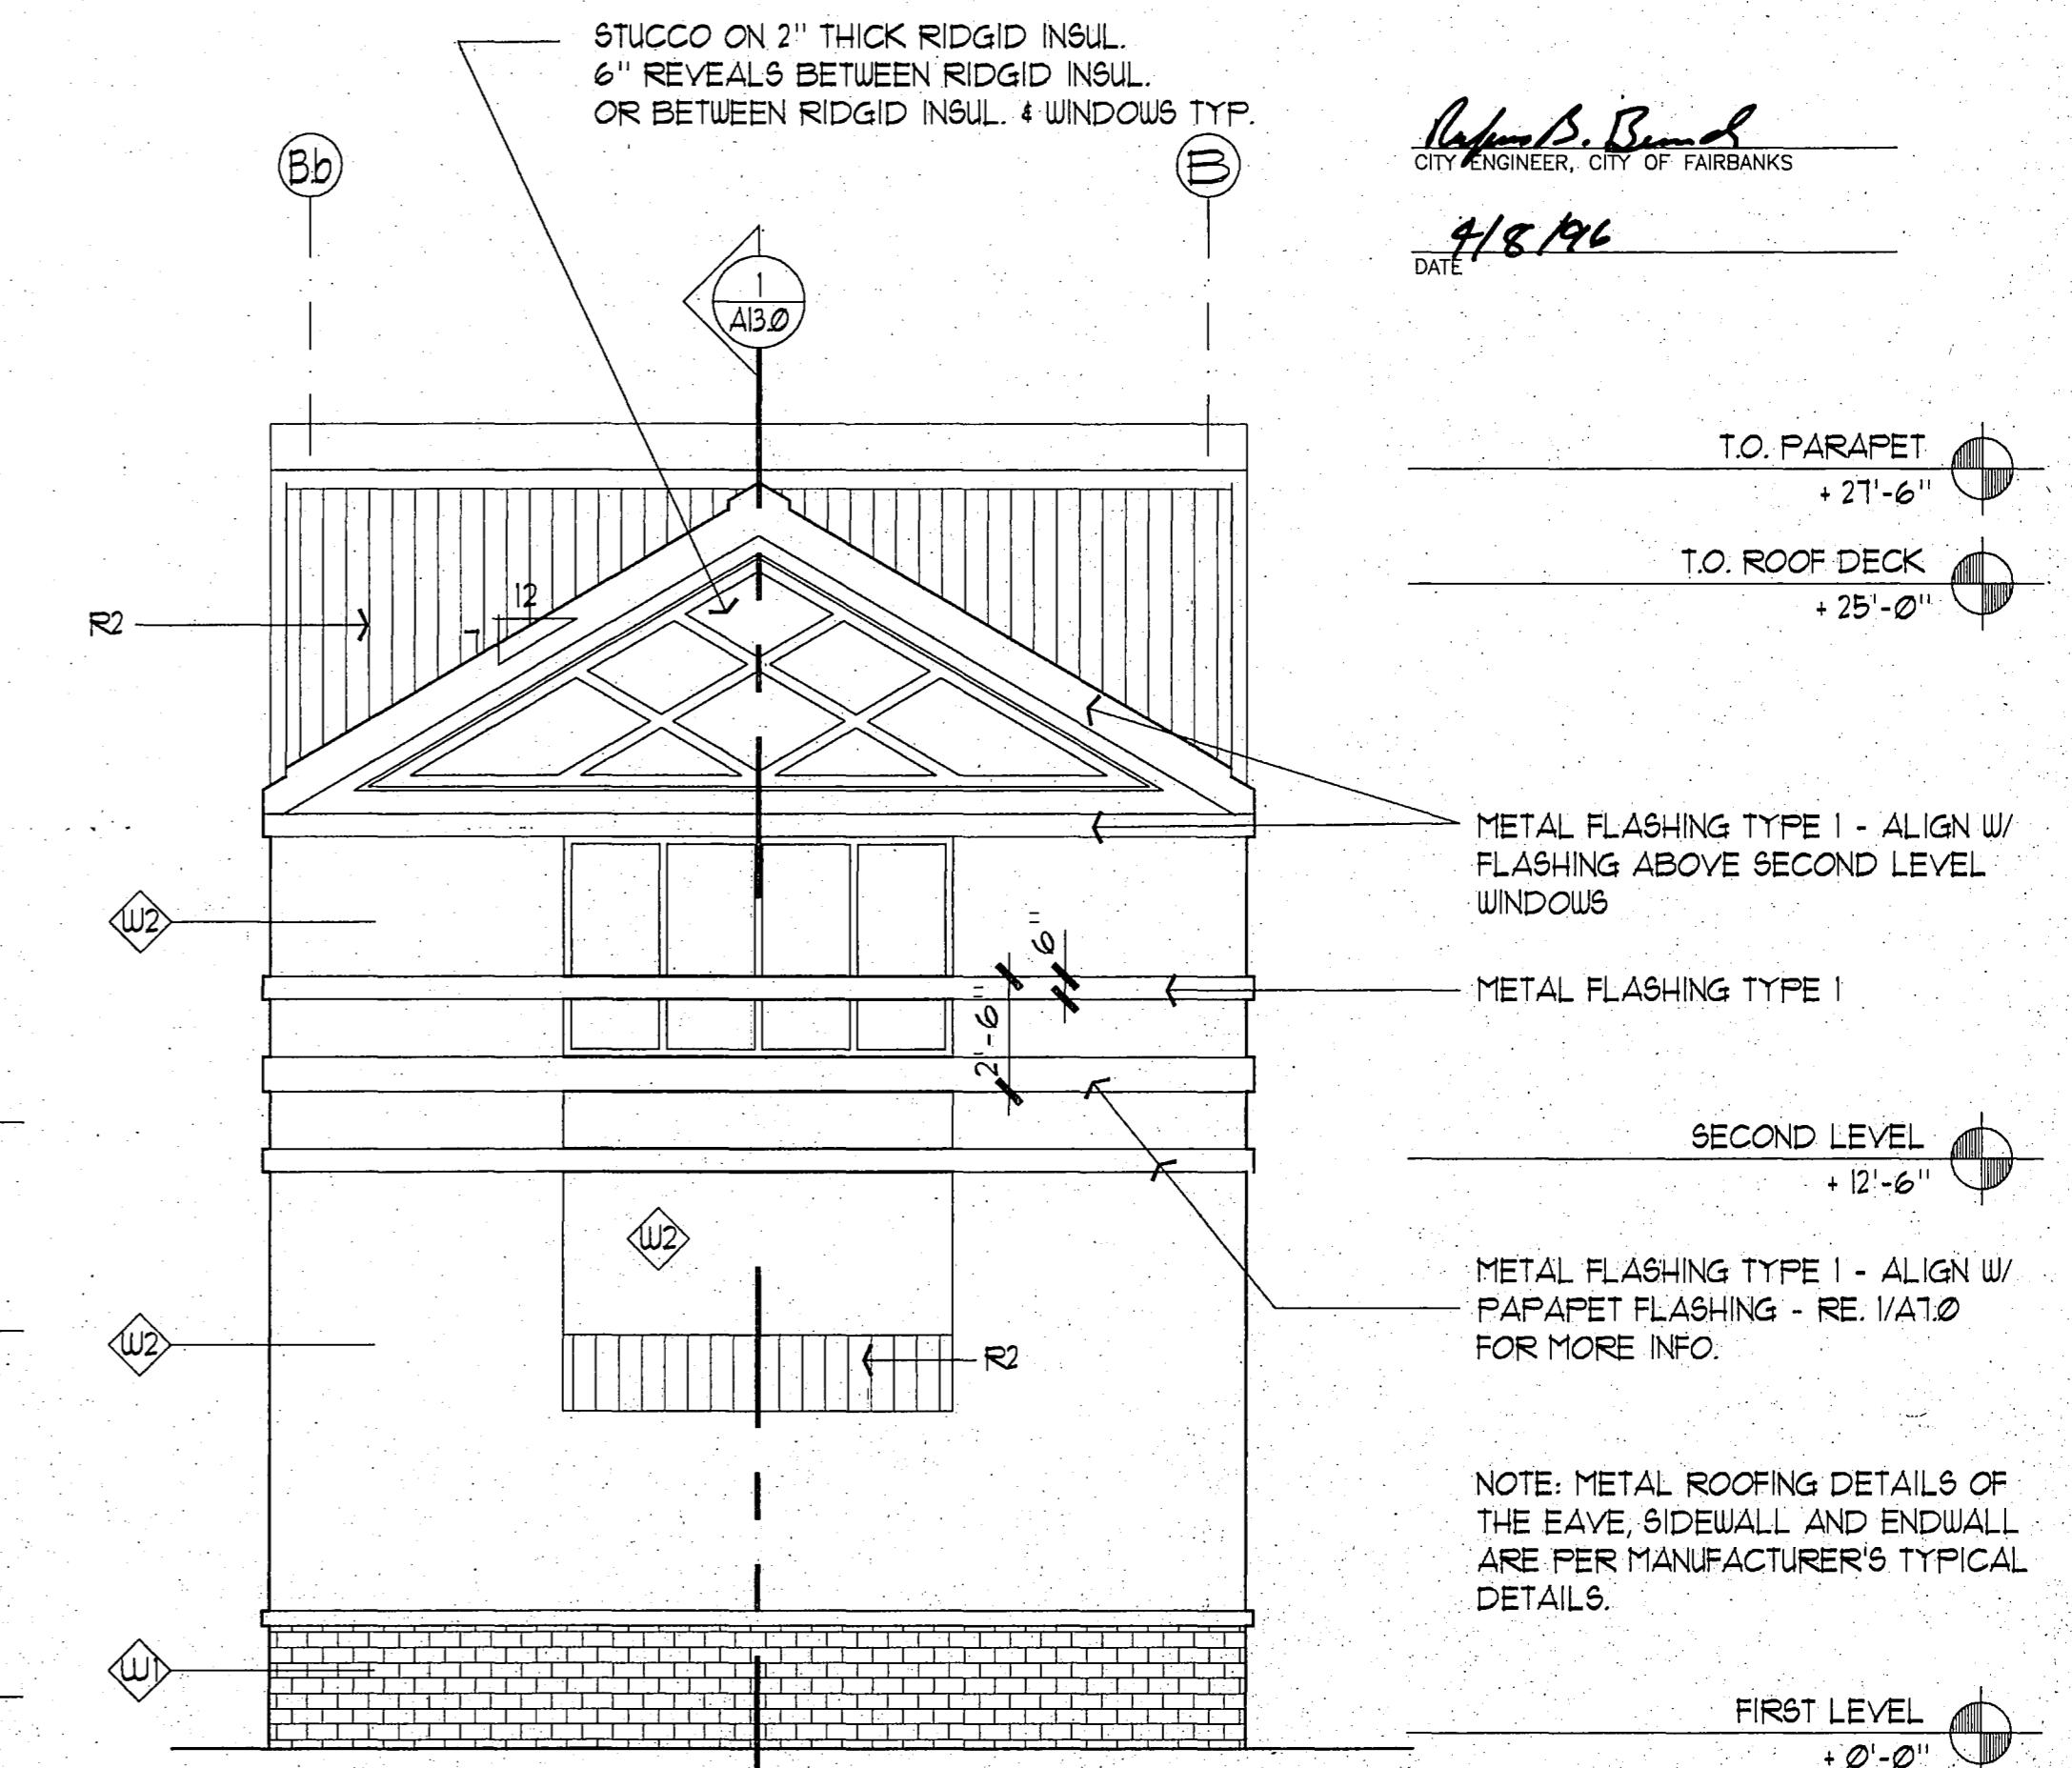

**PROJECT NO. 115.00**

DRAWN BY OM, ALS

**CHECKED BY** JB, JA

**DATE** DEC 9, 1992

**REVISED**

10. The following table shows the number of hours worked by each employee in a company.

10. The following table gives the number of cases of smallpox reported in each State during the year 1802.

# TITLE **EXTERIOR ELEVATIONS**


SHEET NO.

10. The following table gives the number of cases of smallpox reported in each State during the year 1802.

A63

**AC-2**

A6.2

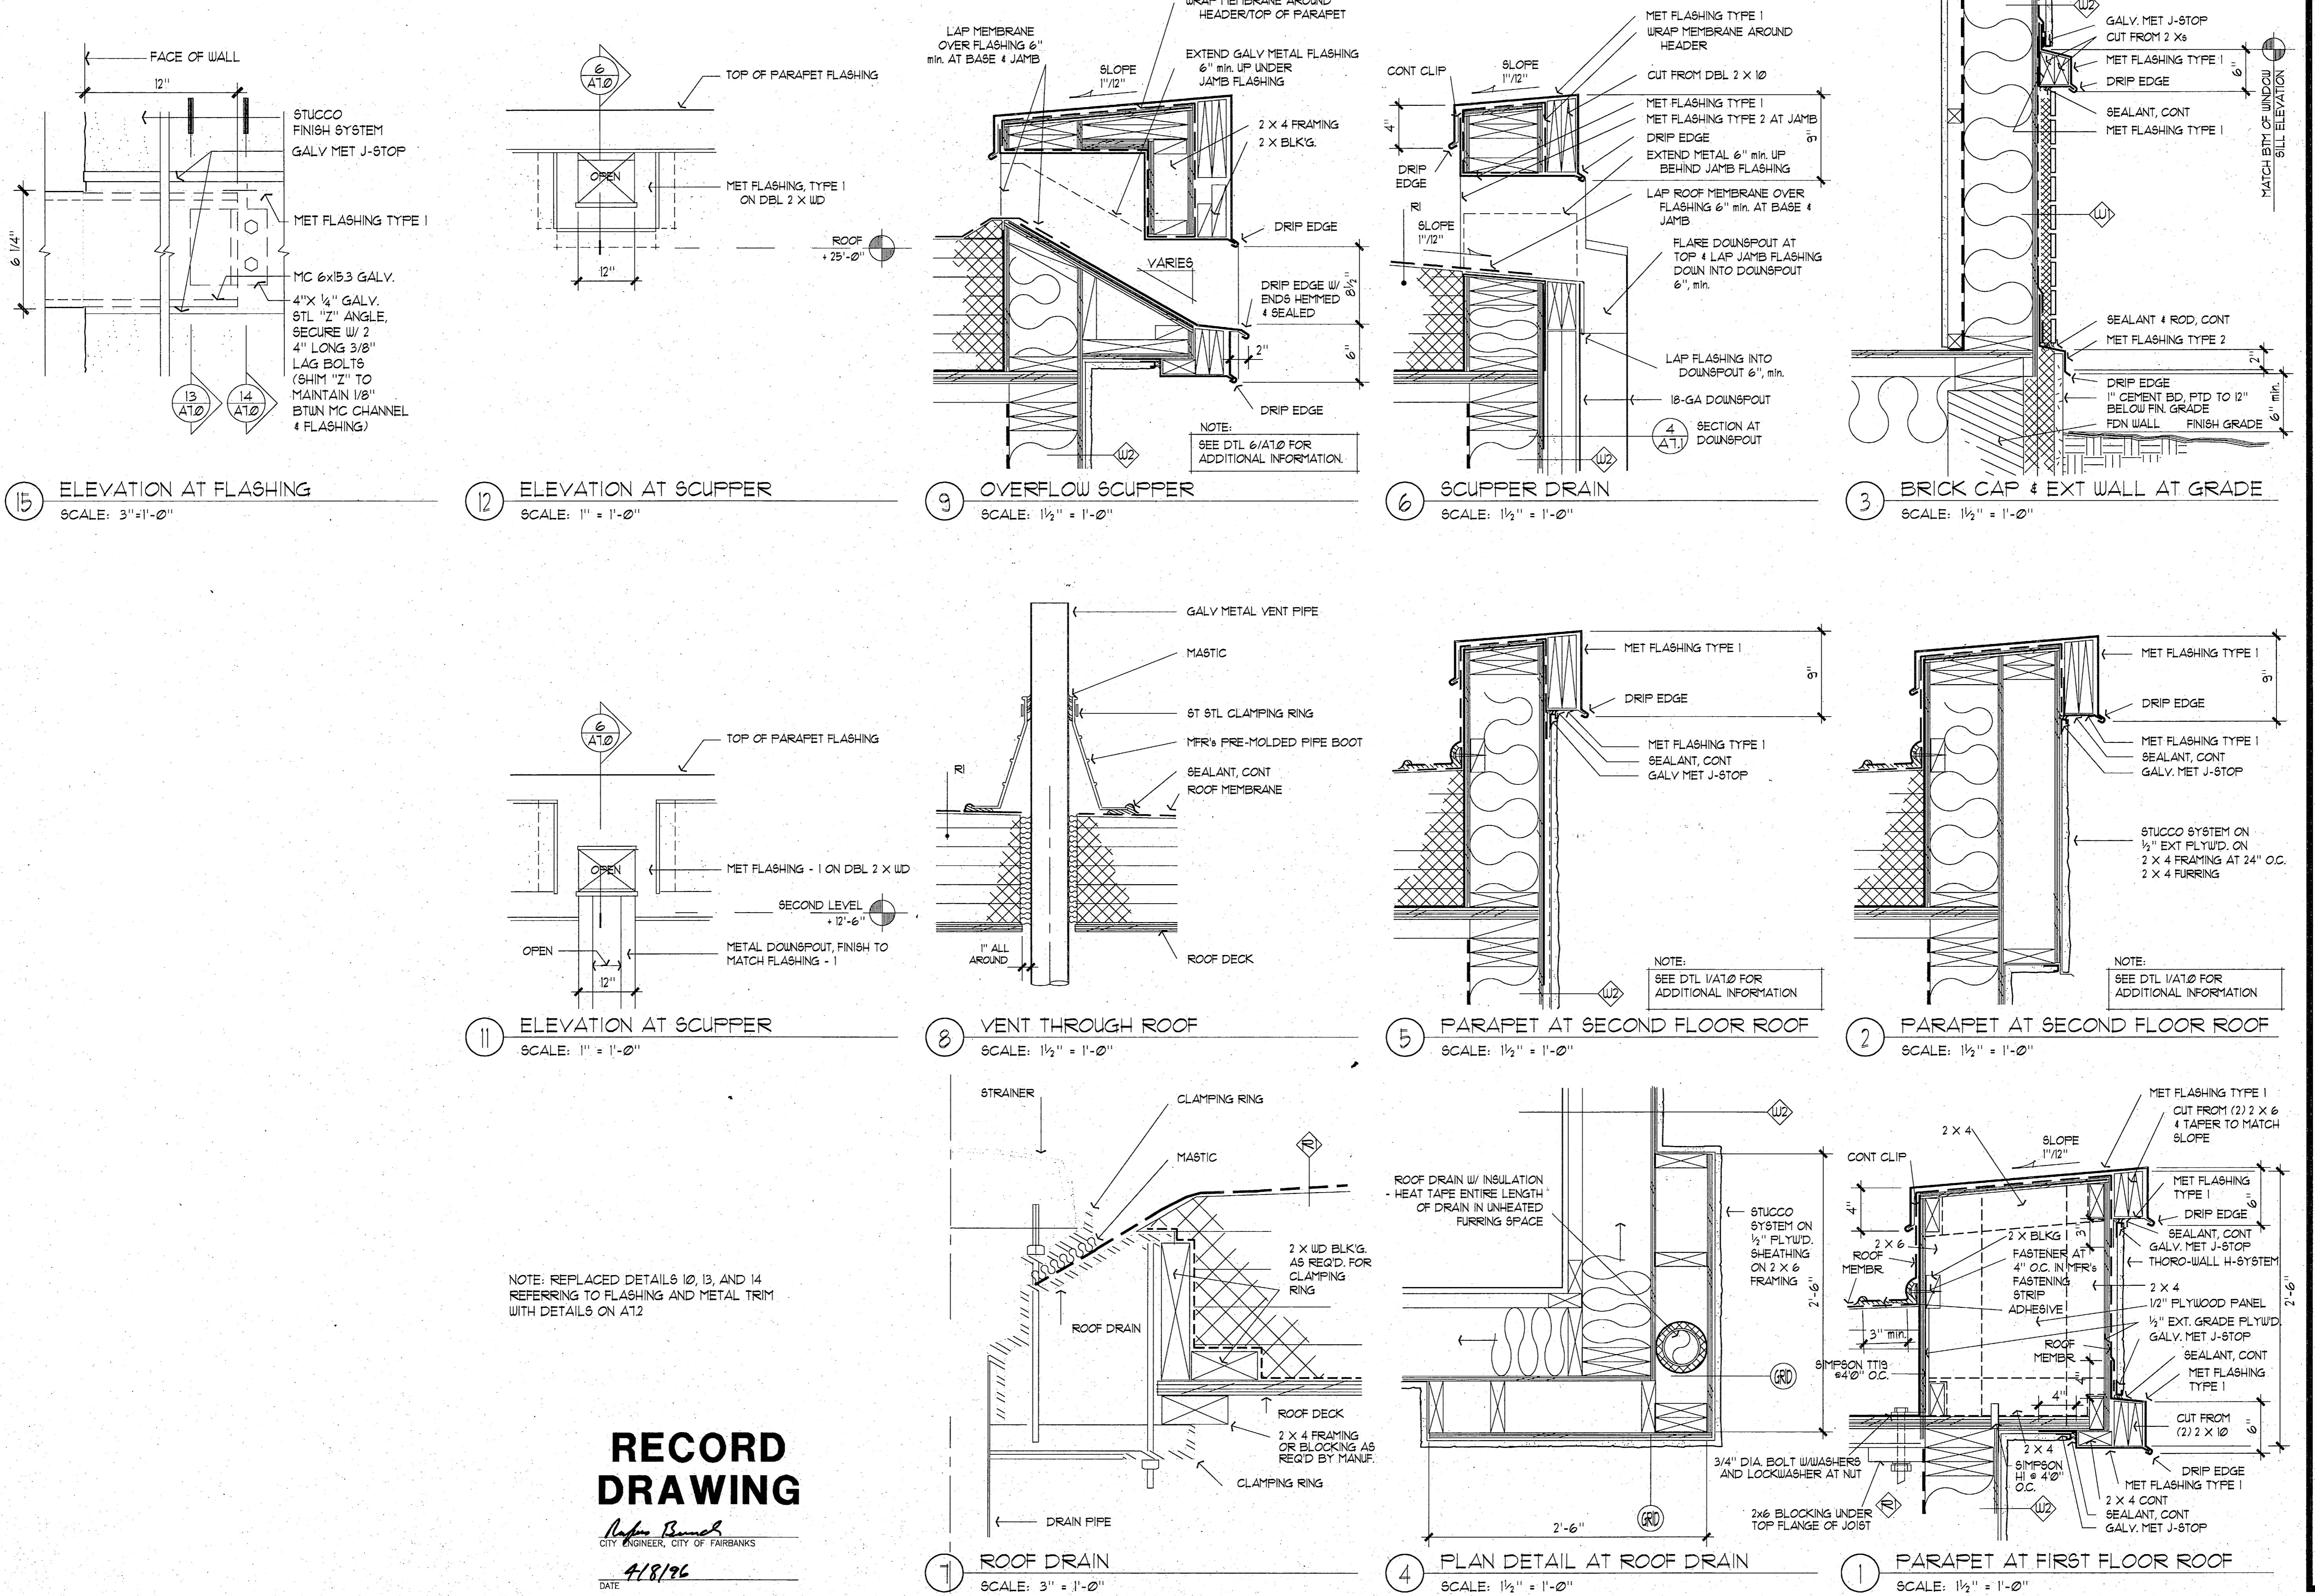

## FAIRBANKS HEALTH CENTER

Fairbanks, Alaska

# STONE

Architecture   Interior   Design   Engineering   Planning

290

(907) 562-2058

**T NO.** 115.00  
**BY** CLARK  
**D BY** J.G.A.  
DEC 9, 1992

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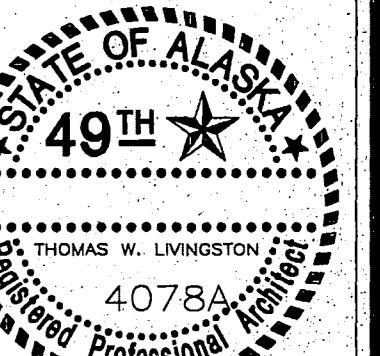
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1960-1961

11

**A 7.0**











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PROJECT NO. 115.00  
DRAWN BY CLARK  
CHECKED BY JB  
DATE DEC 9, 1992  
REVISED

TITLE  
**EXTERIOR DETAILS**

SHEET NO.

**A7.1**


## RECORD DRAWING

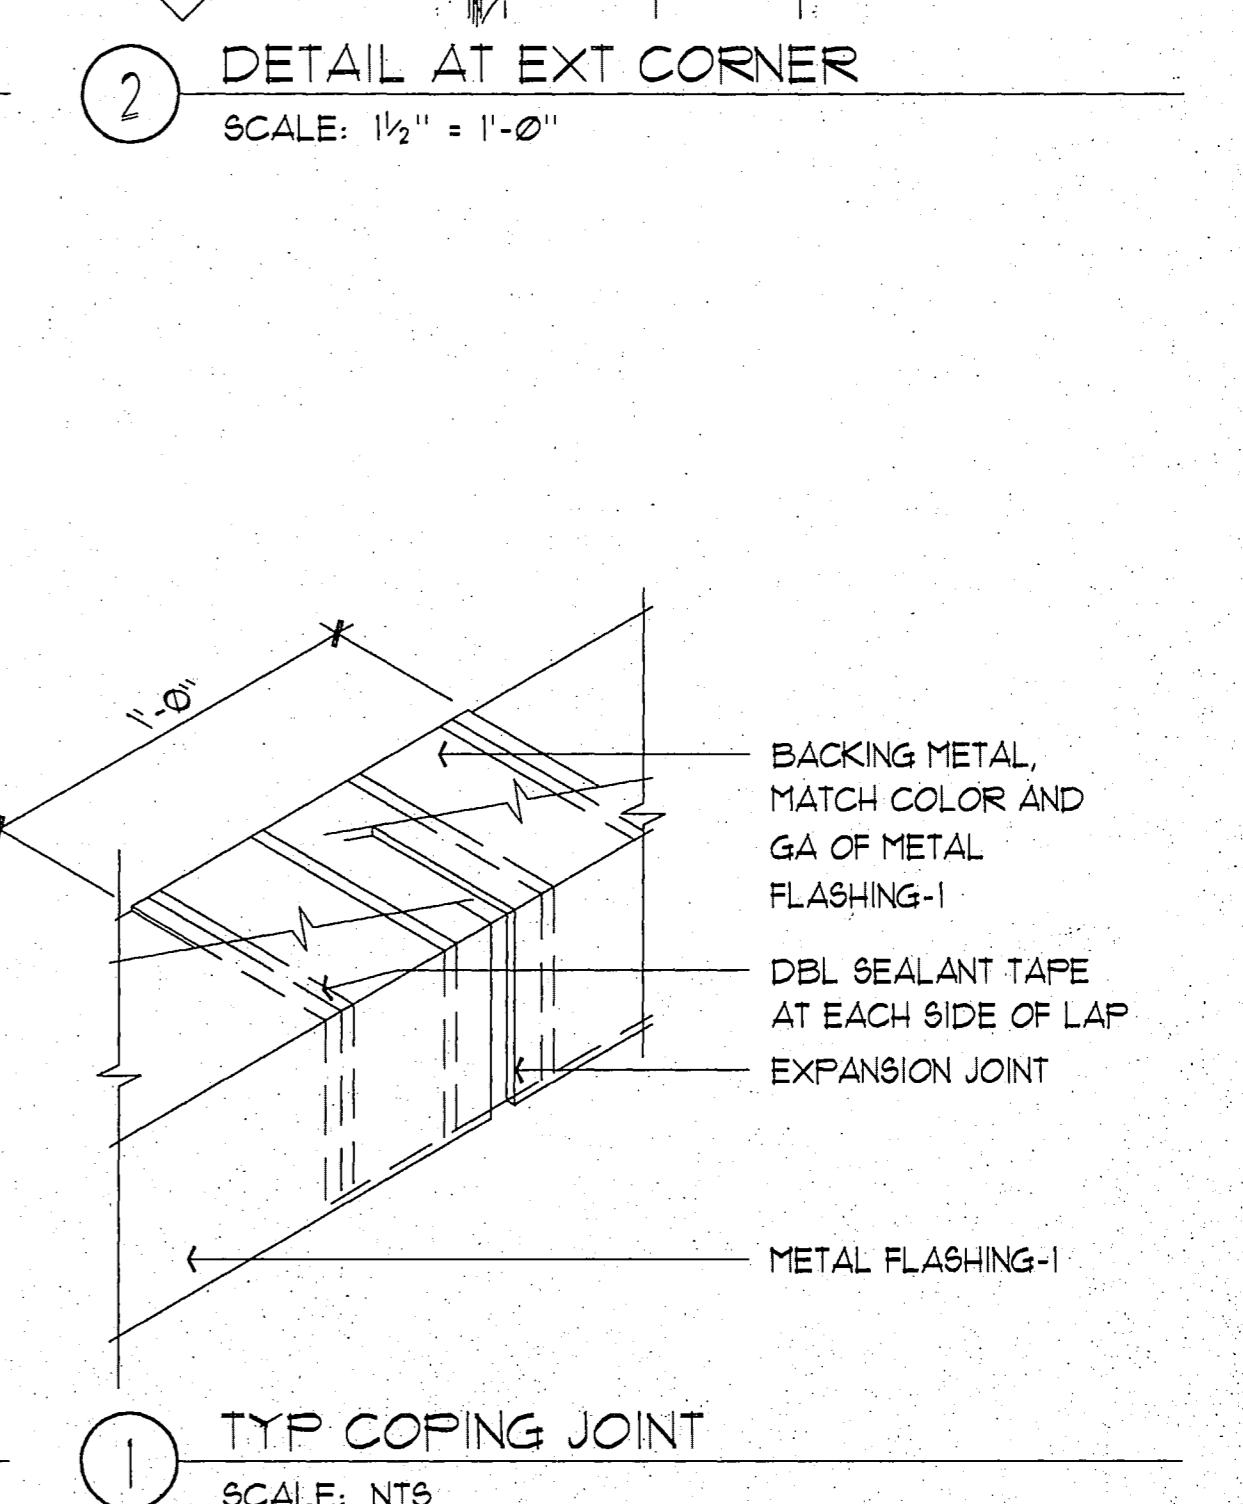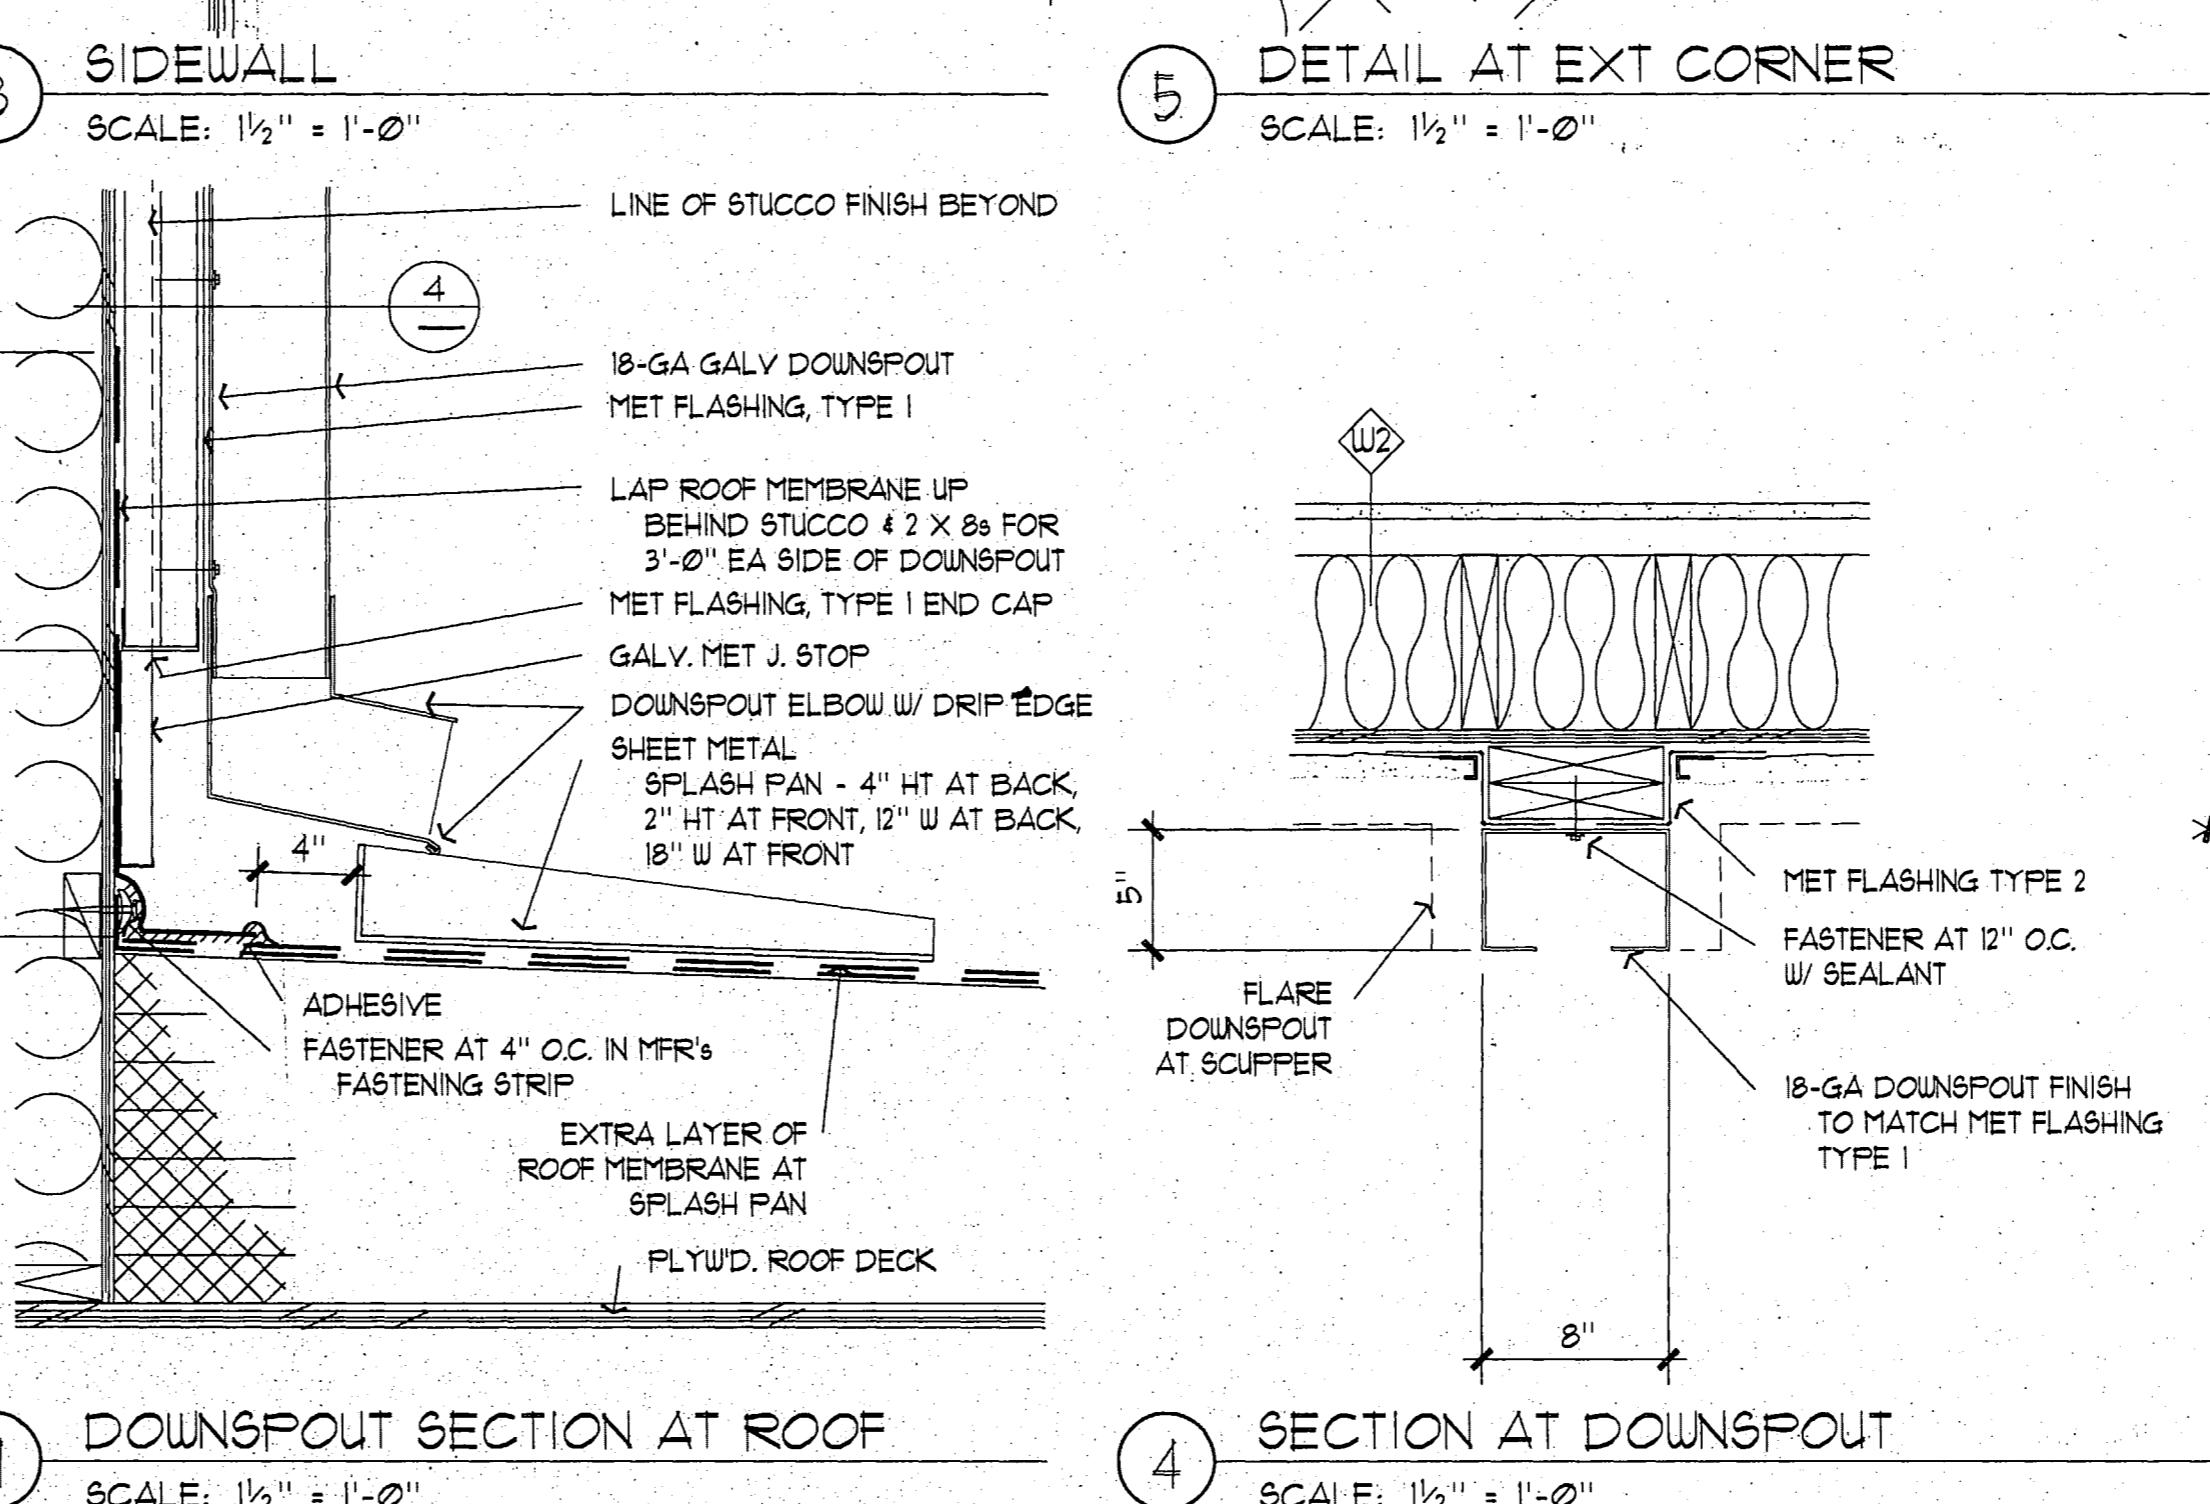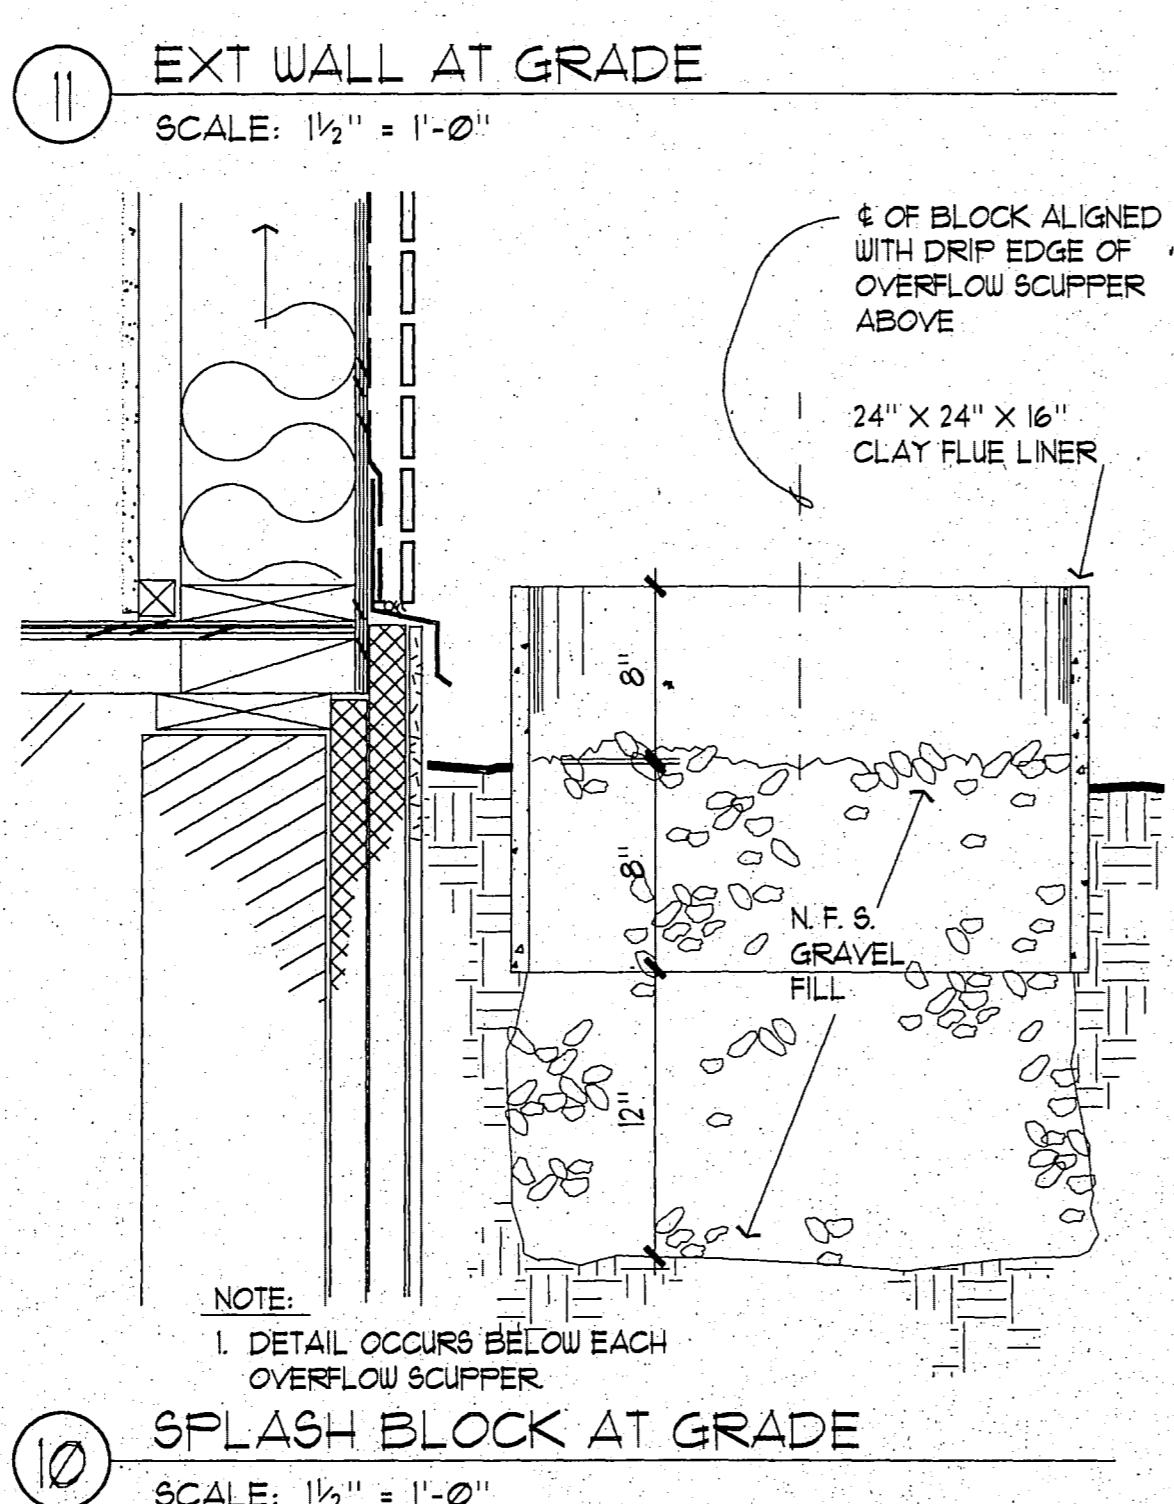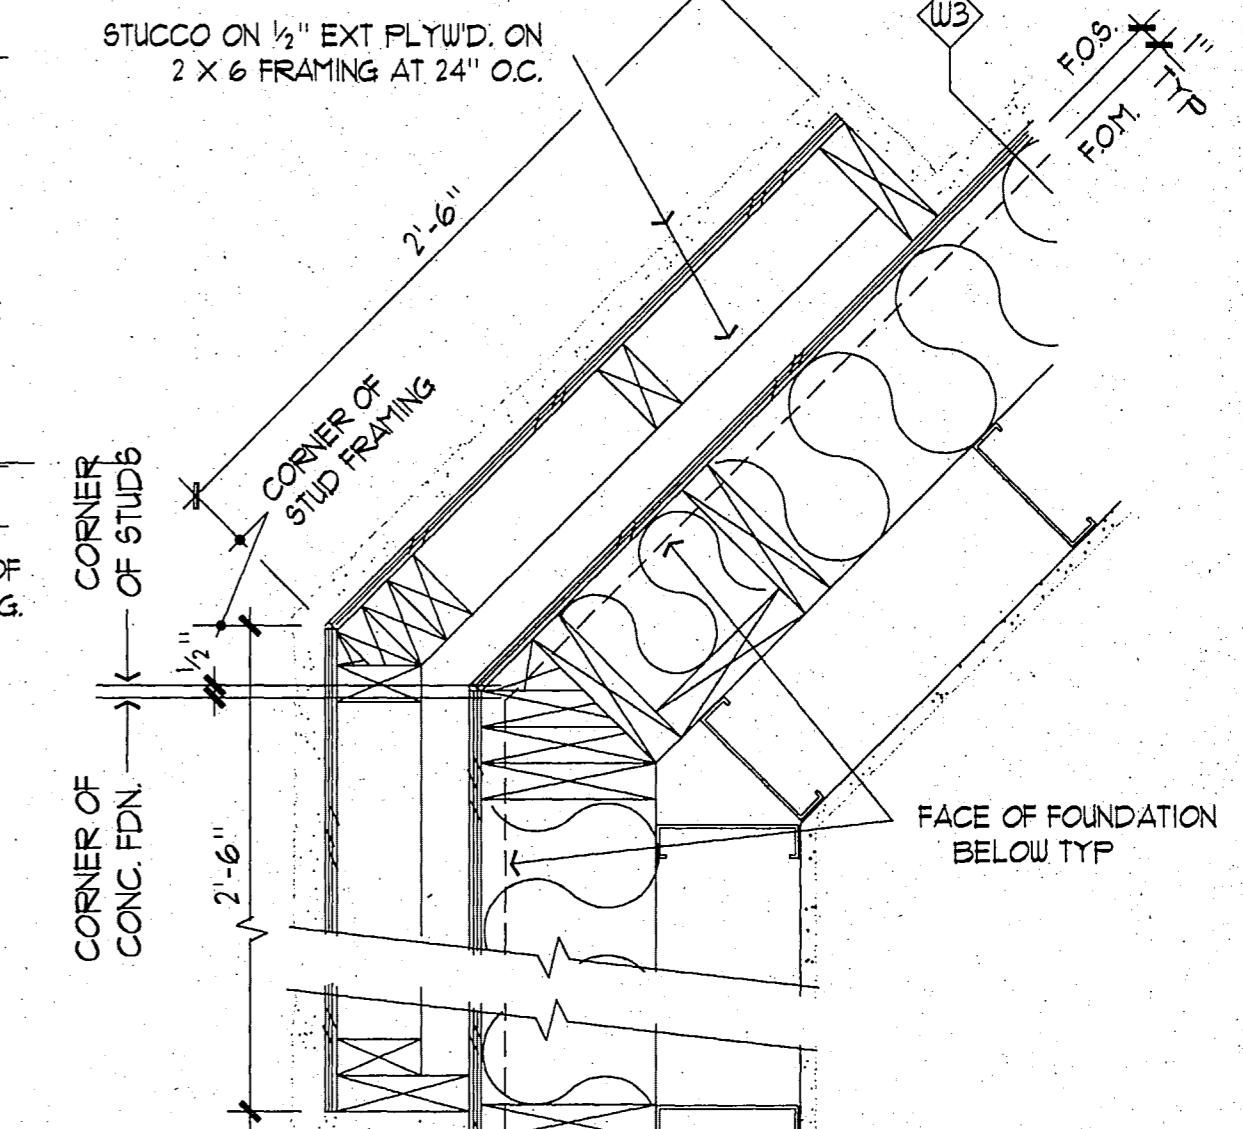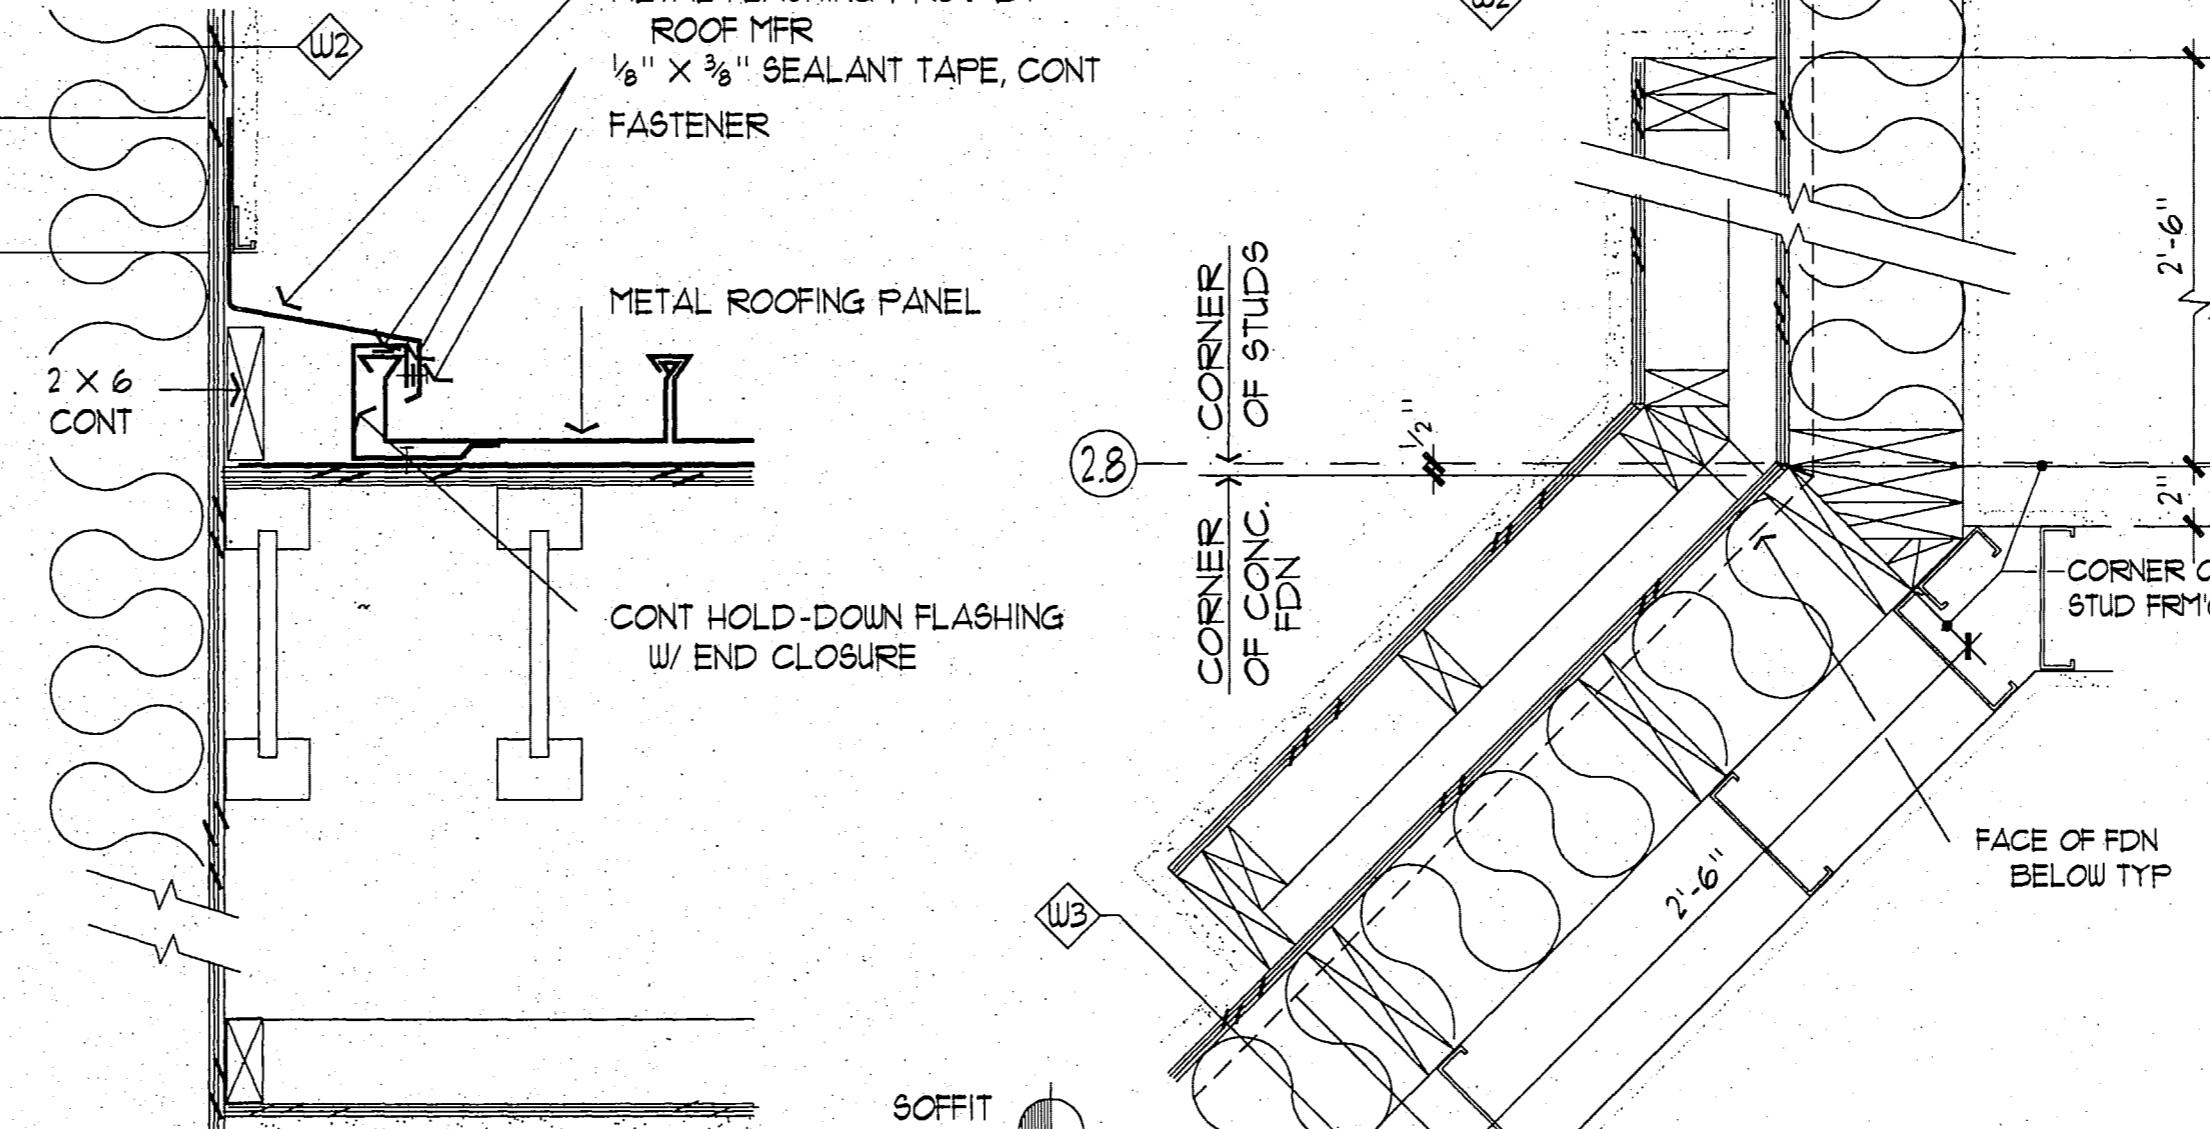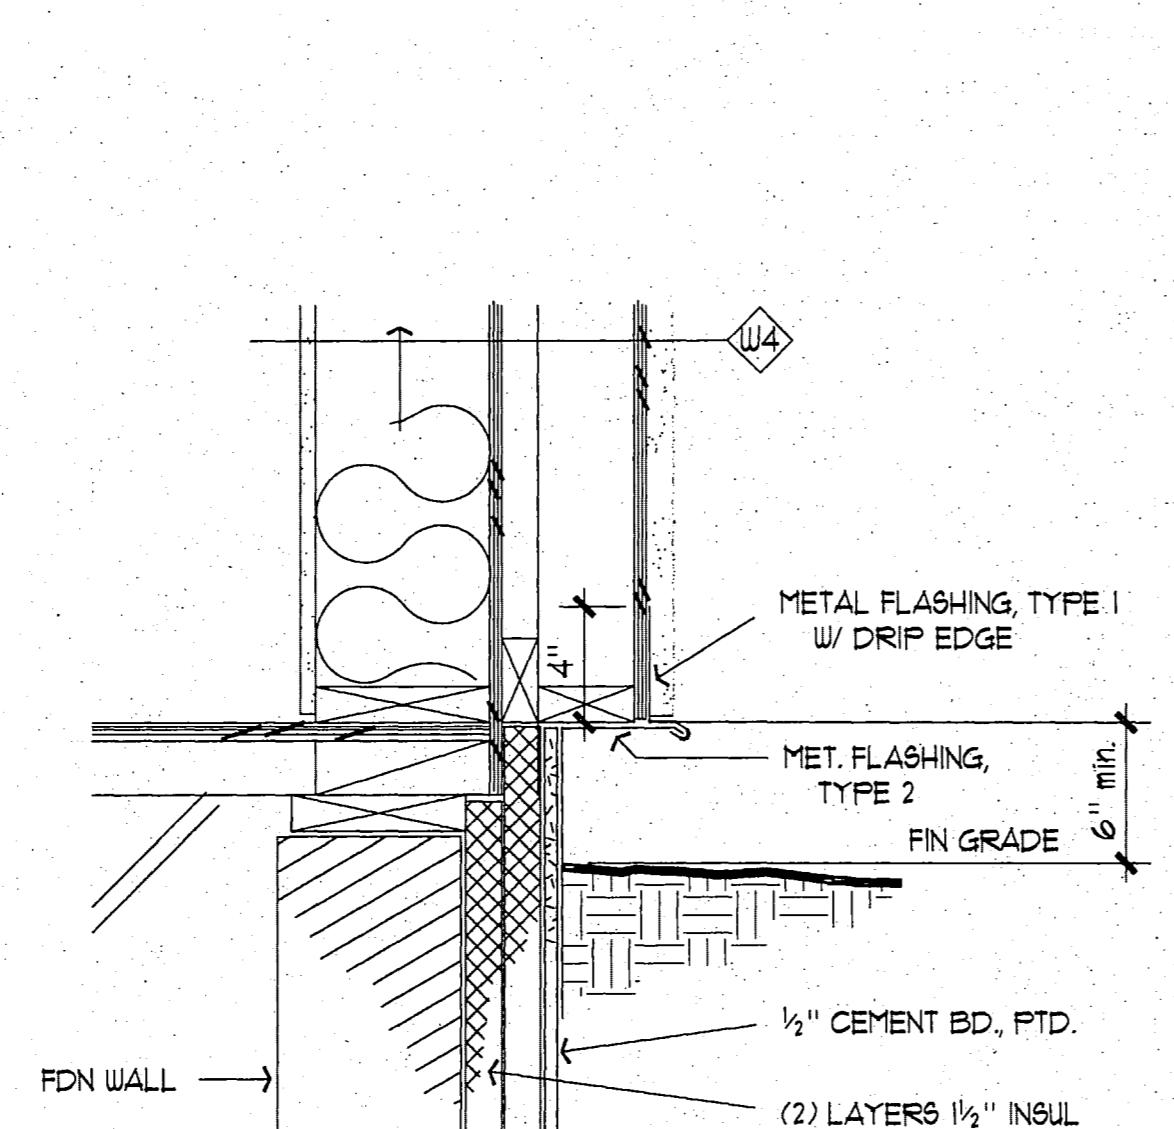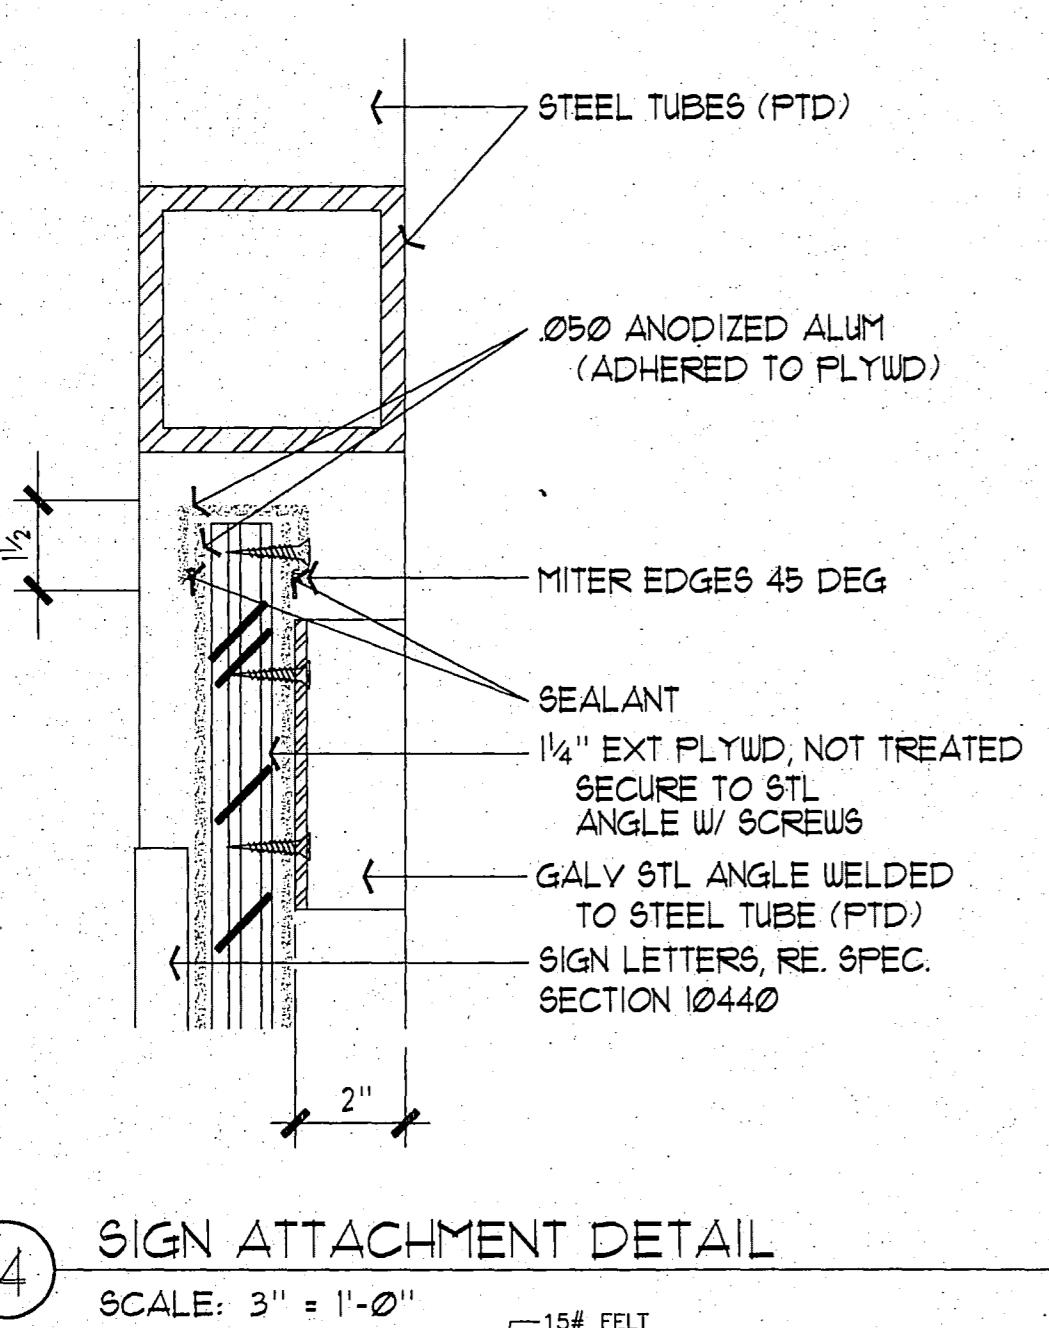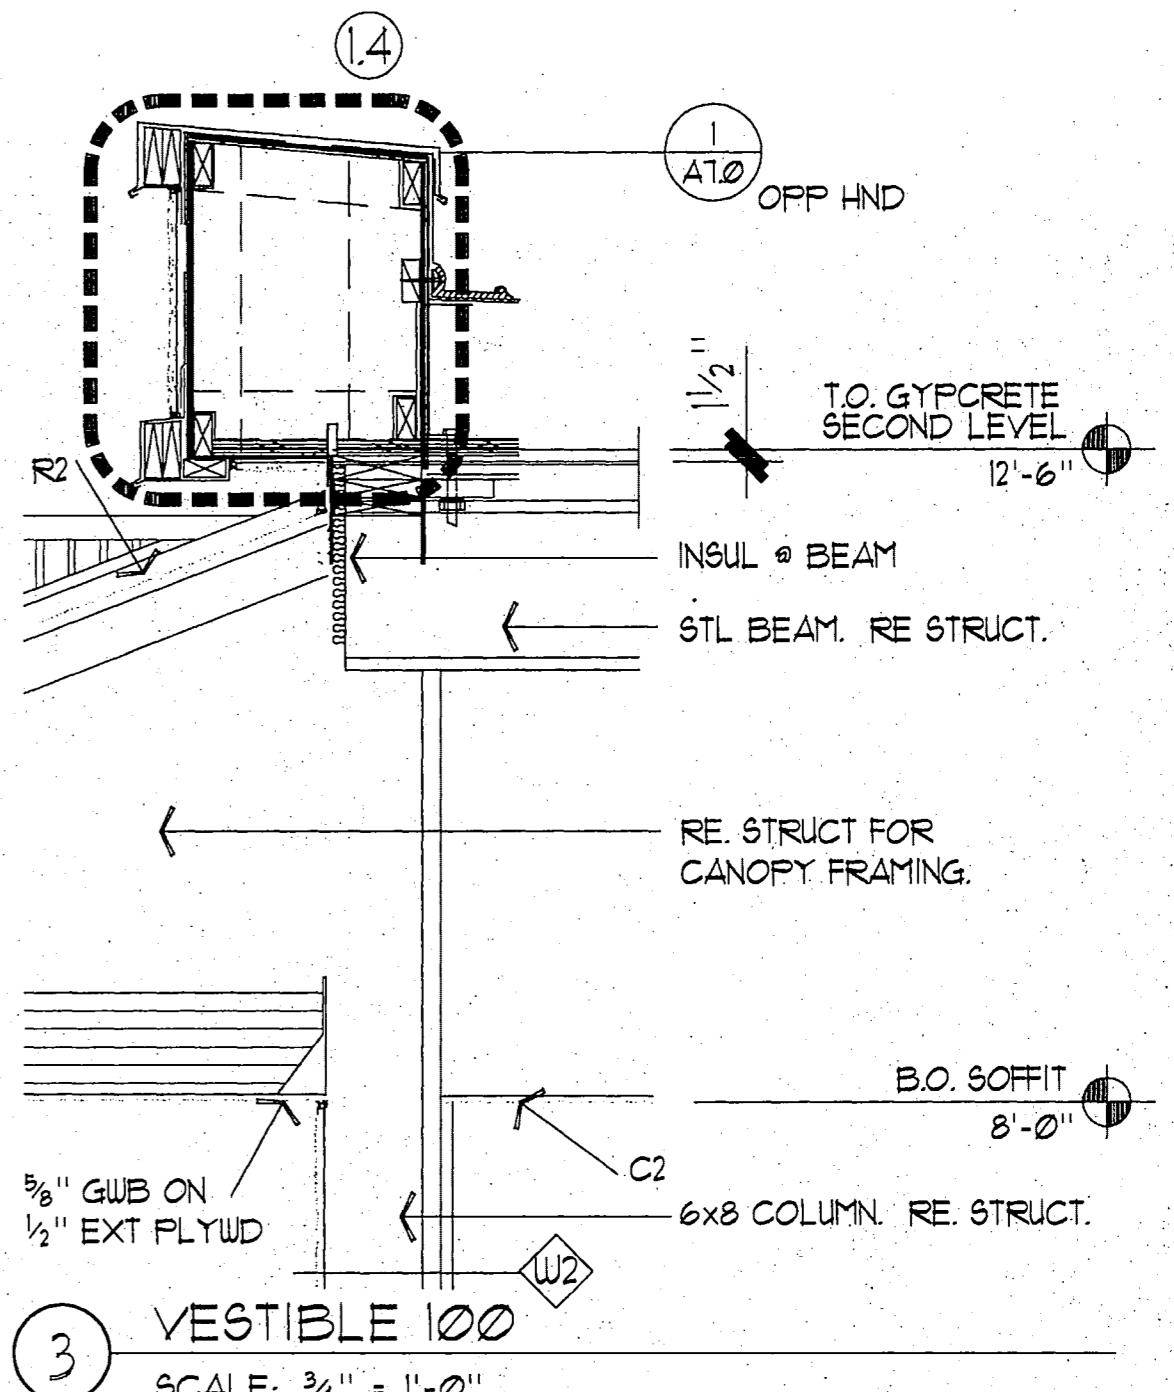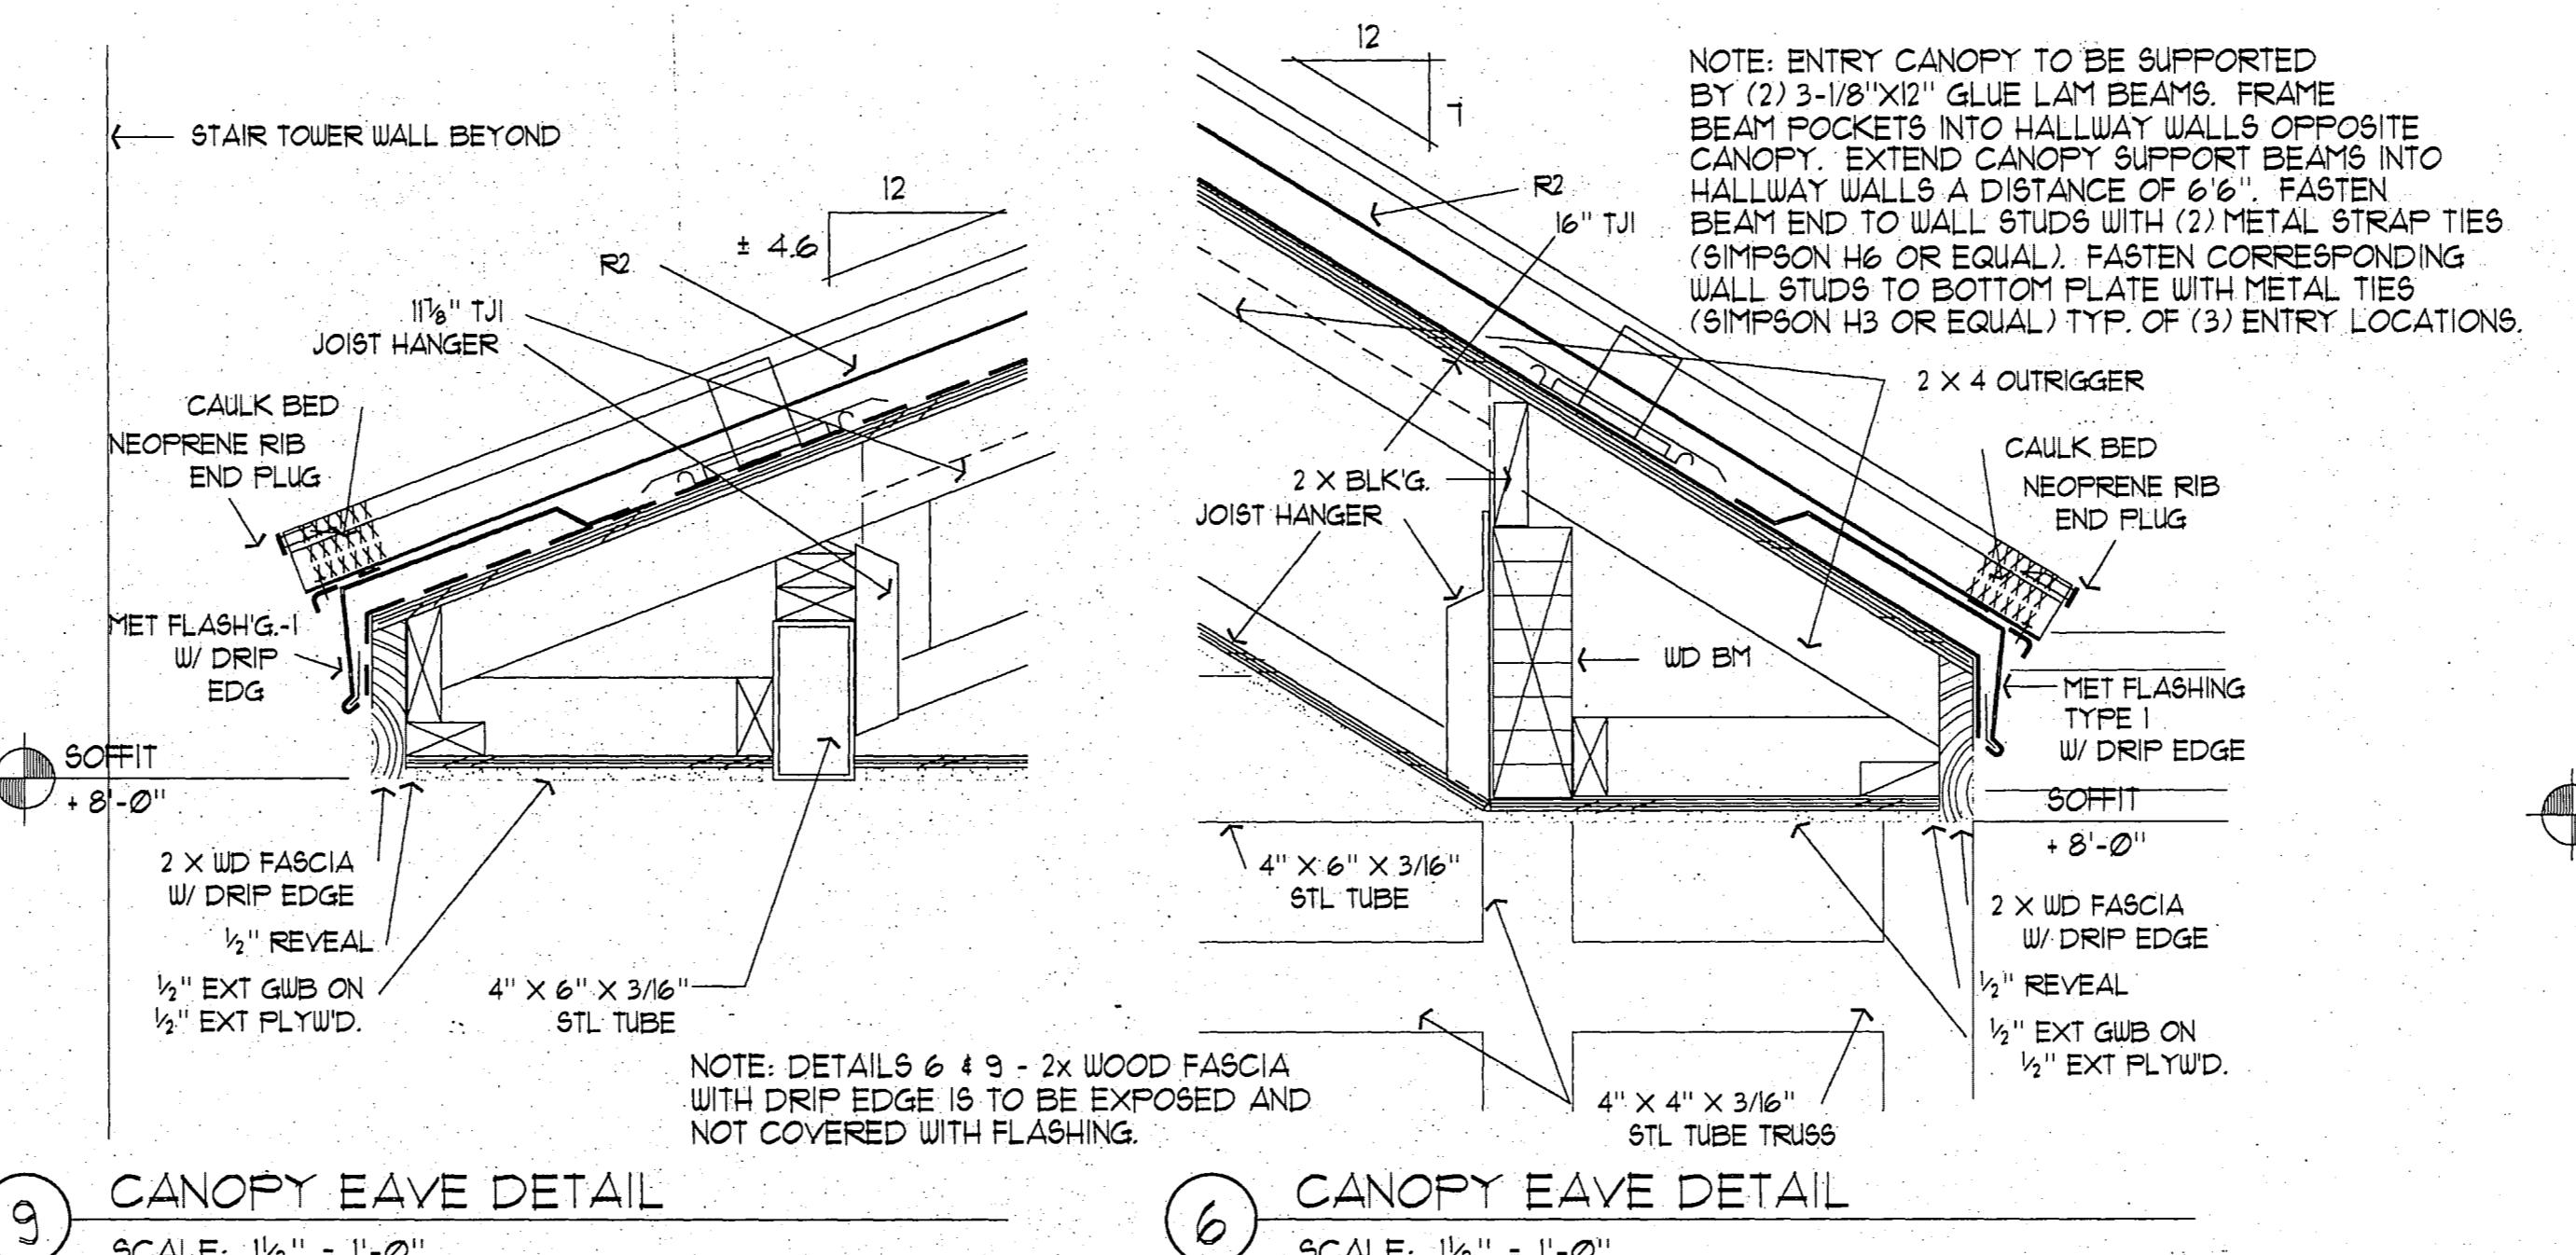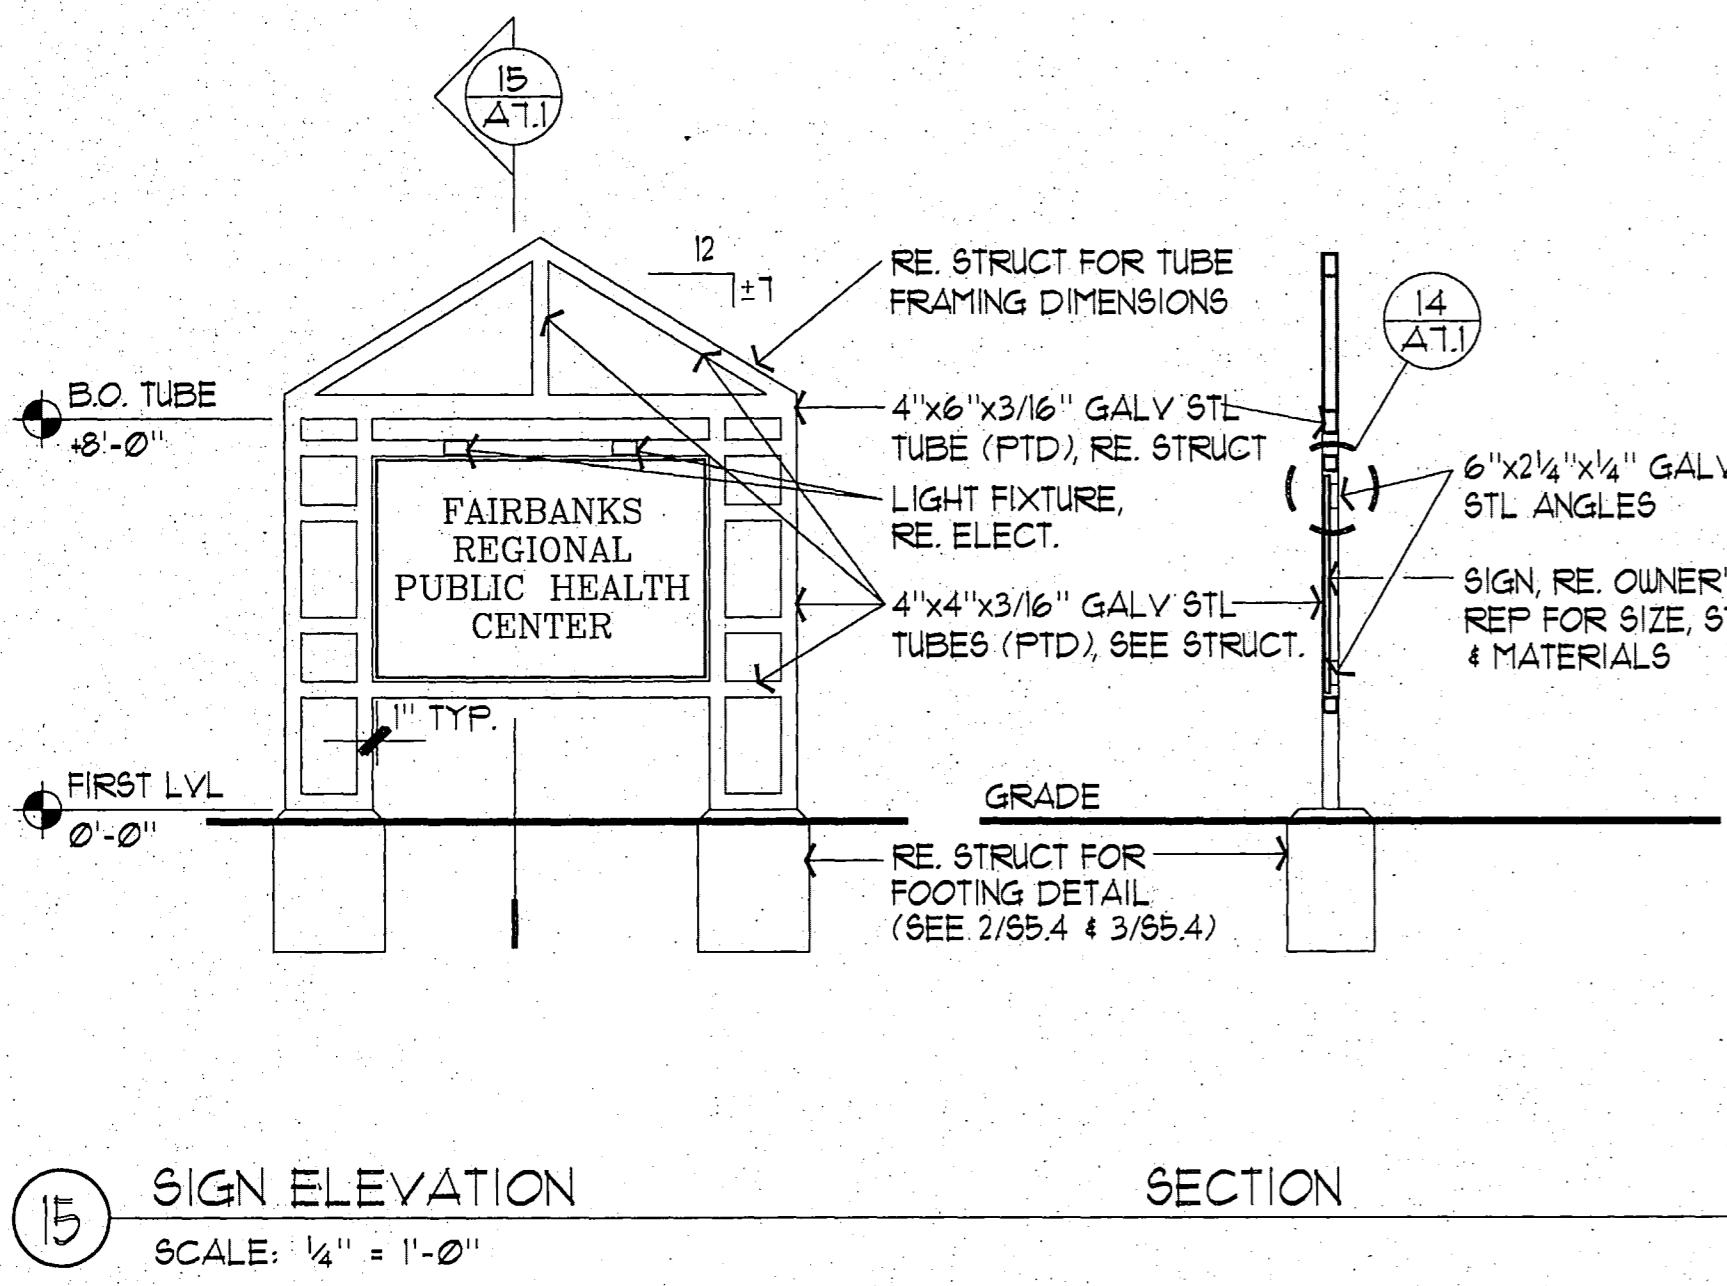Rufus B. Burch  
CITY ENGINEER, CITY OF FAIRBANKS  
1/8/96

FAIRBANKS HEALTH CENTER


CITY OF FAIRBANKS

FAIRBANKS, ALASKA

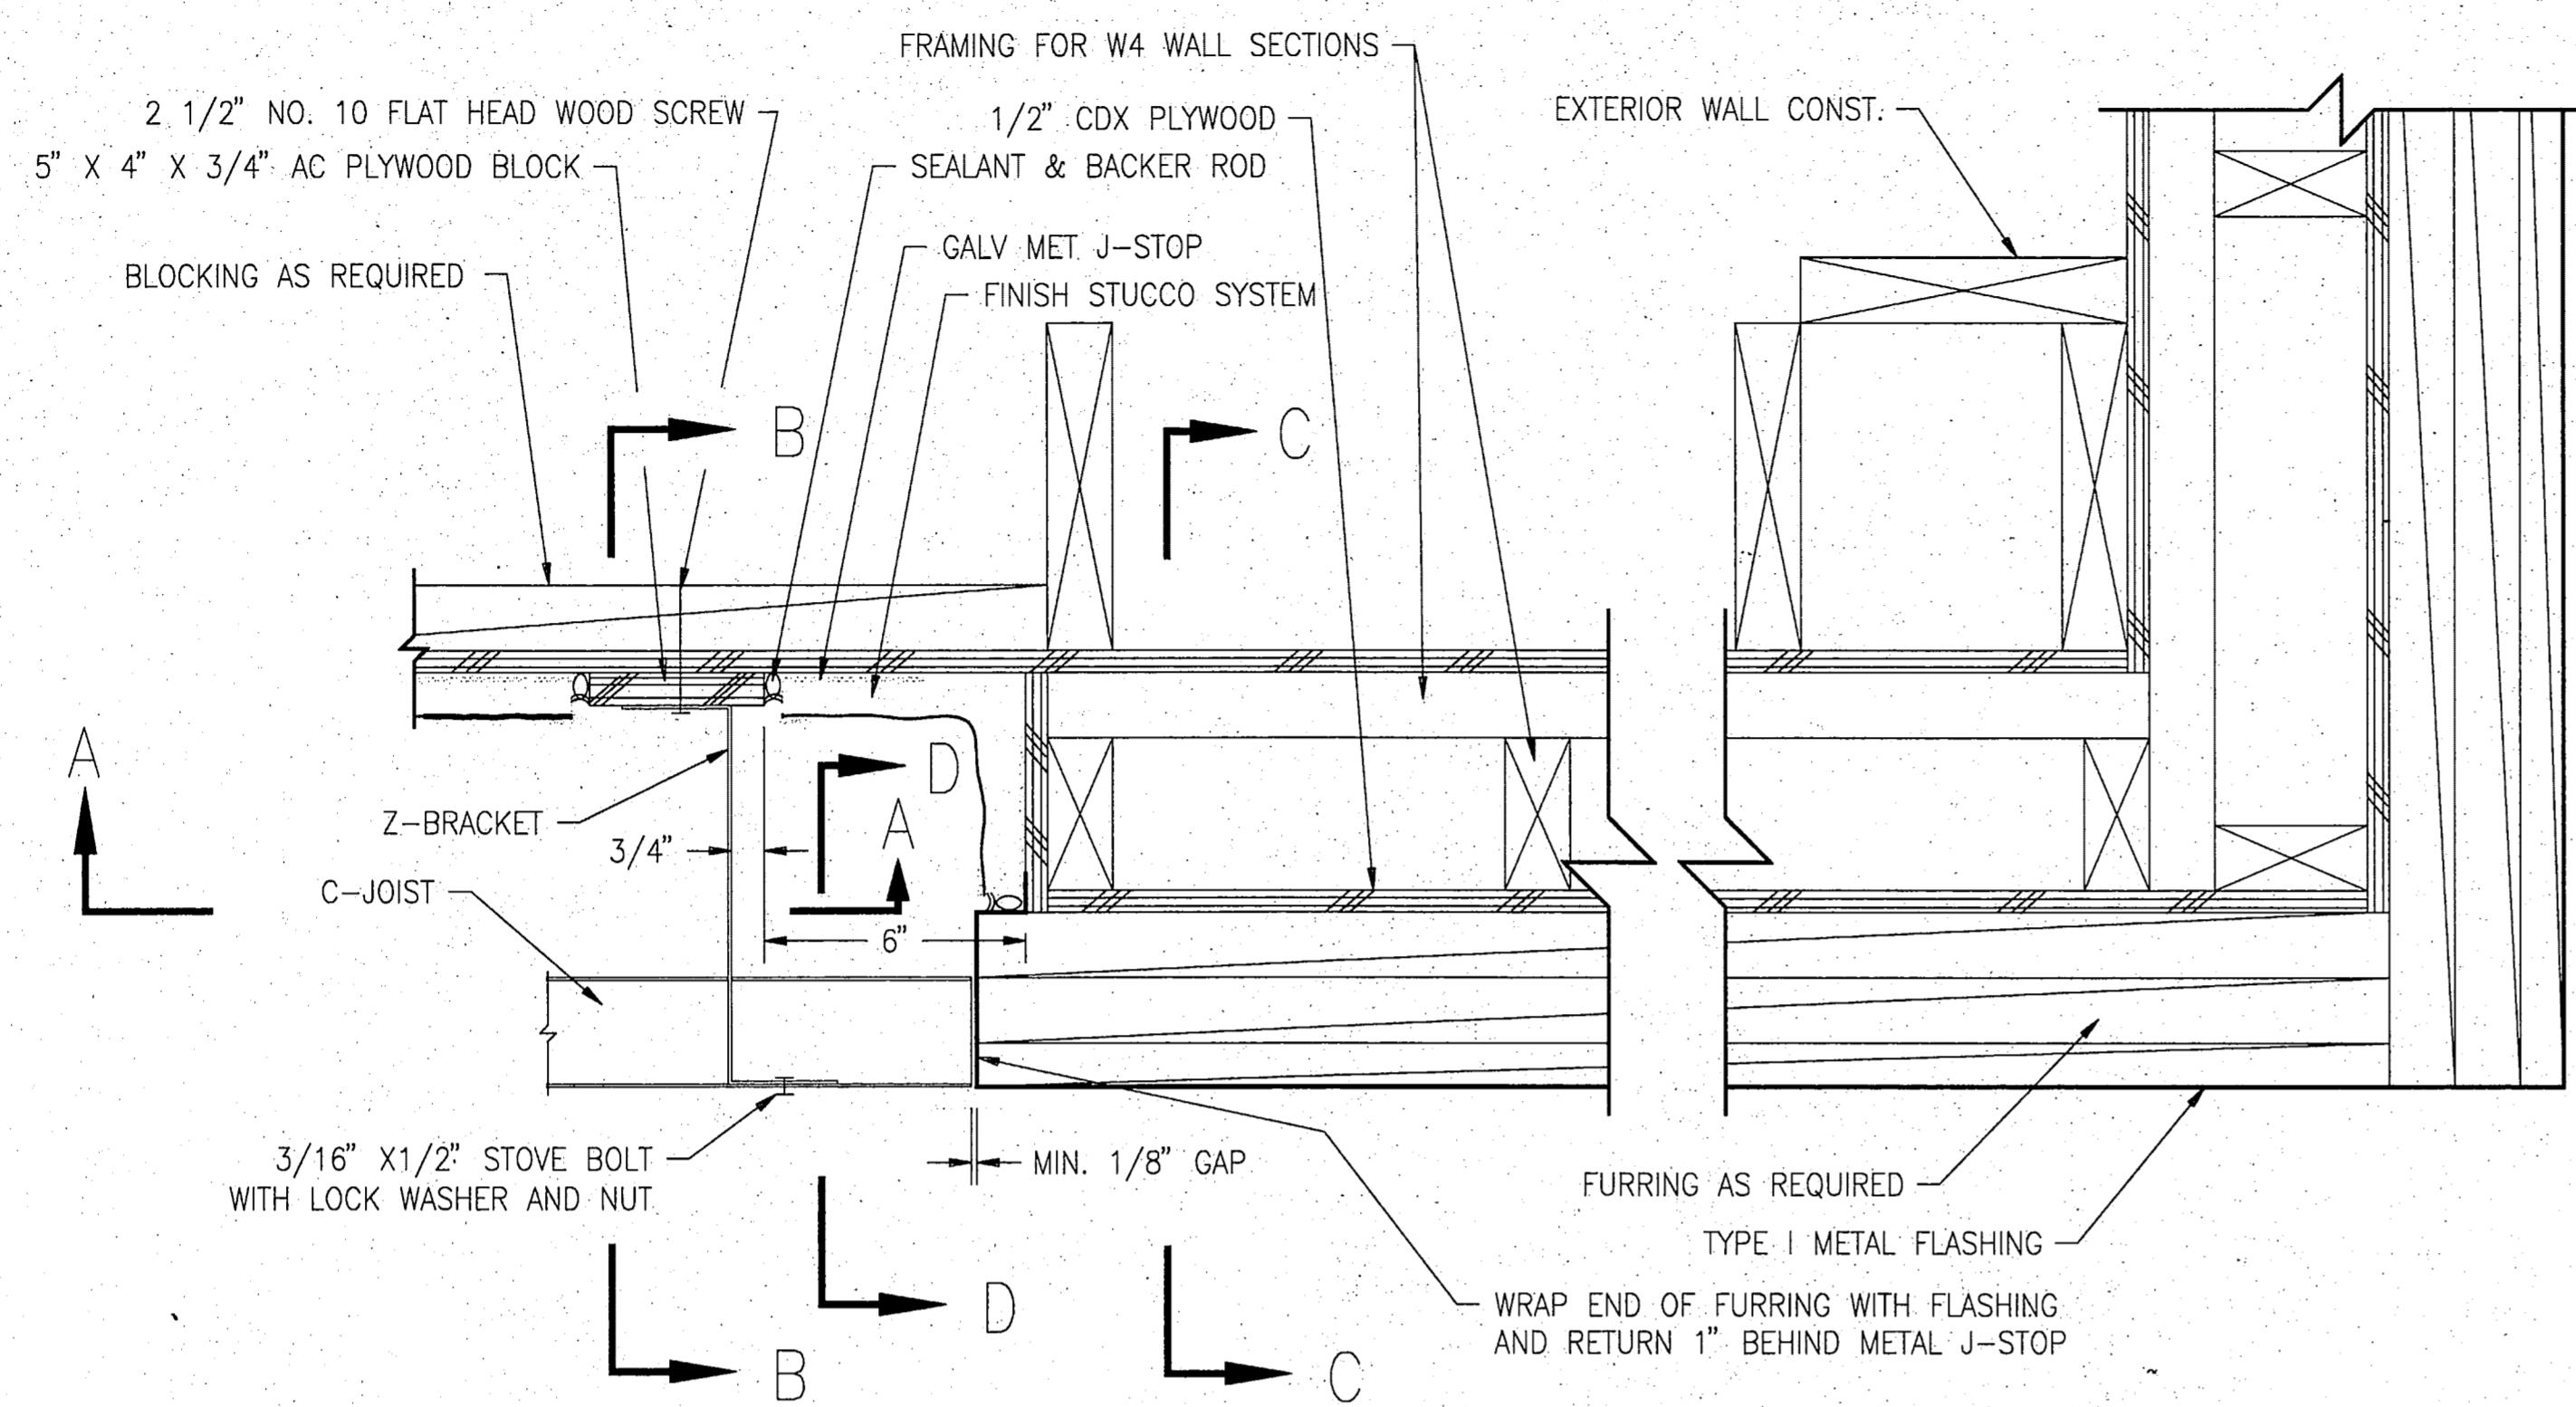


**SECTION E-E**

SCALE: 1 1/2" = 1'-0"

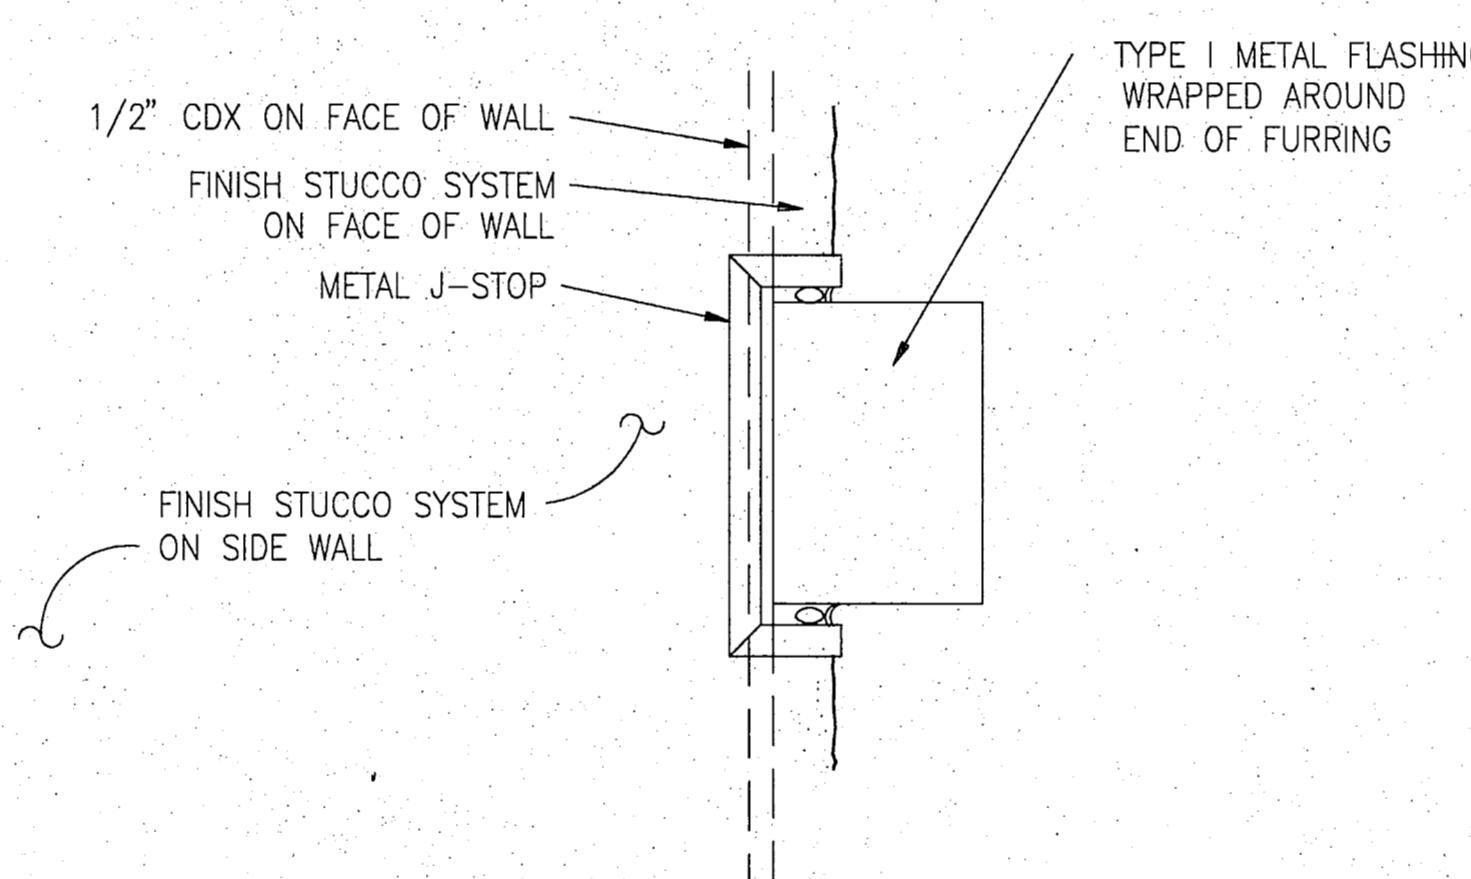

**SECTION D-D**

SCALE: 1 1/2" = 1'-0"

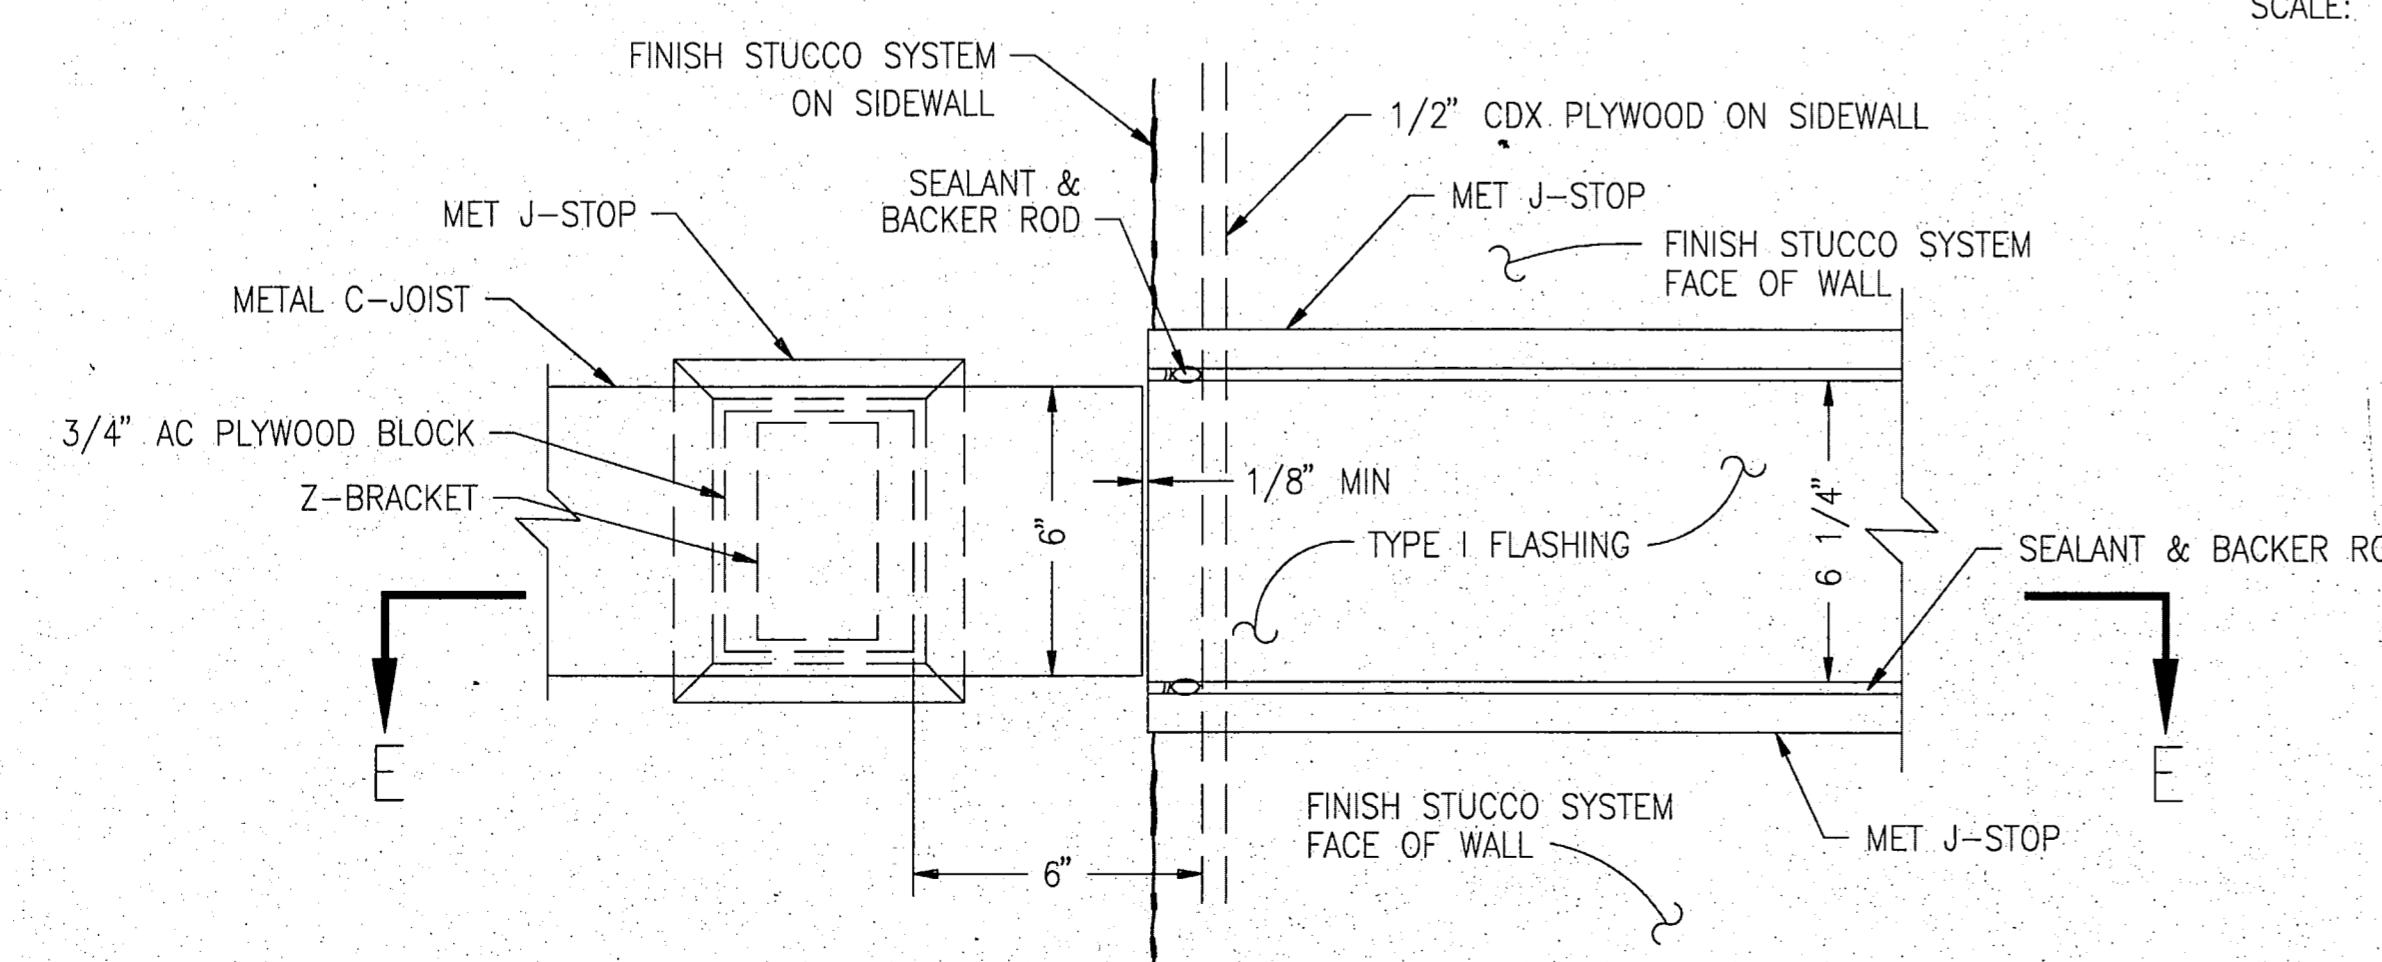


**FRONT VIEW**

SCALE: 1 1/2" = 1'-0"

**RECORD  
DRAWING**


*Roger P. Bond*  
CITY ENGINEER, CITY OF FAIRBANKS

4/18/96  
DATE

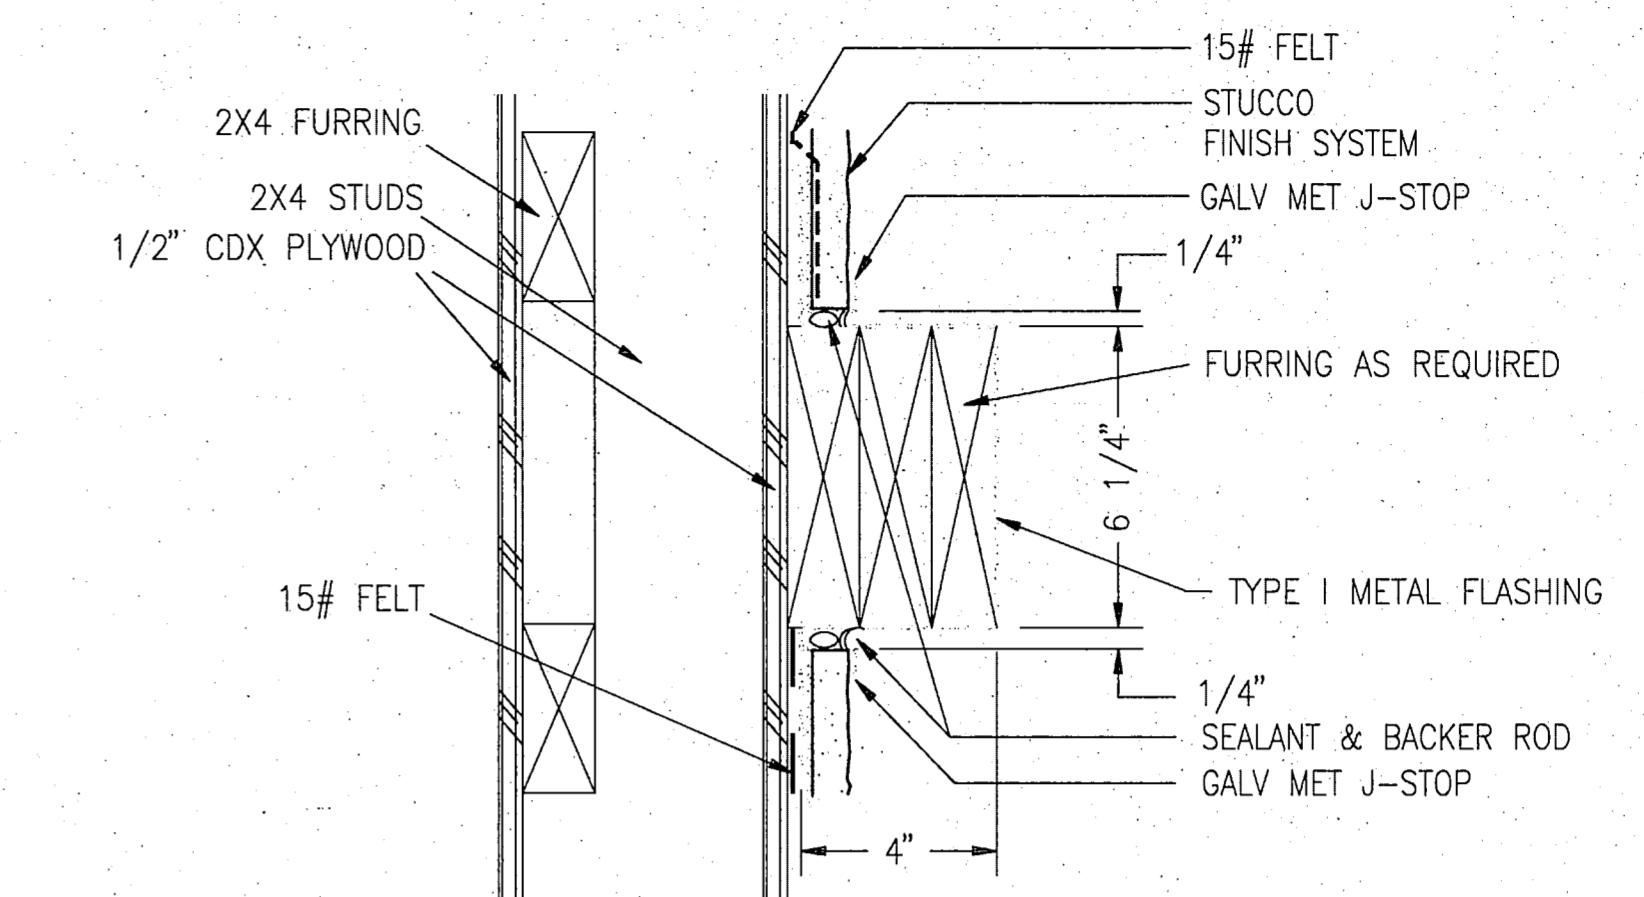


**SECTION C-C**

SCALE: 1 1/2" = 1'-0"

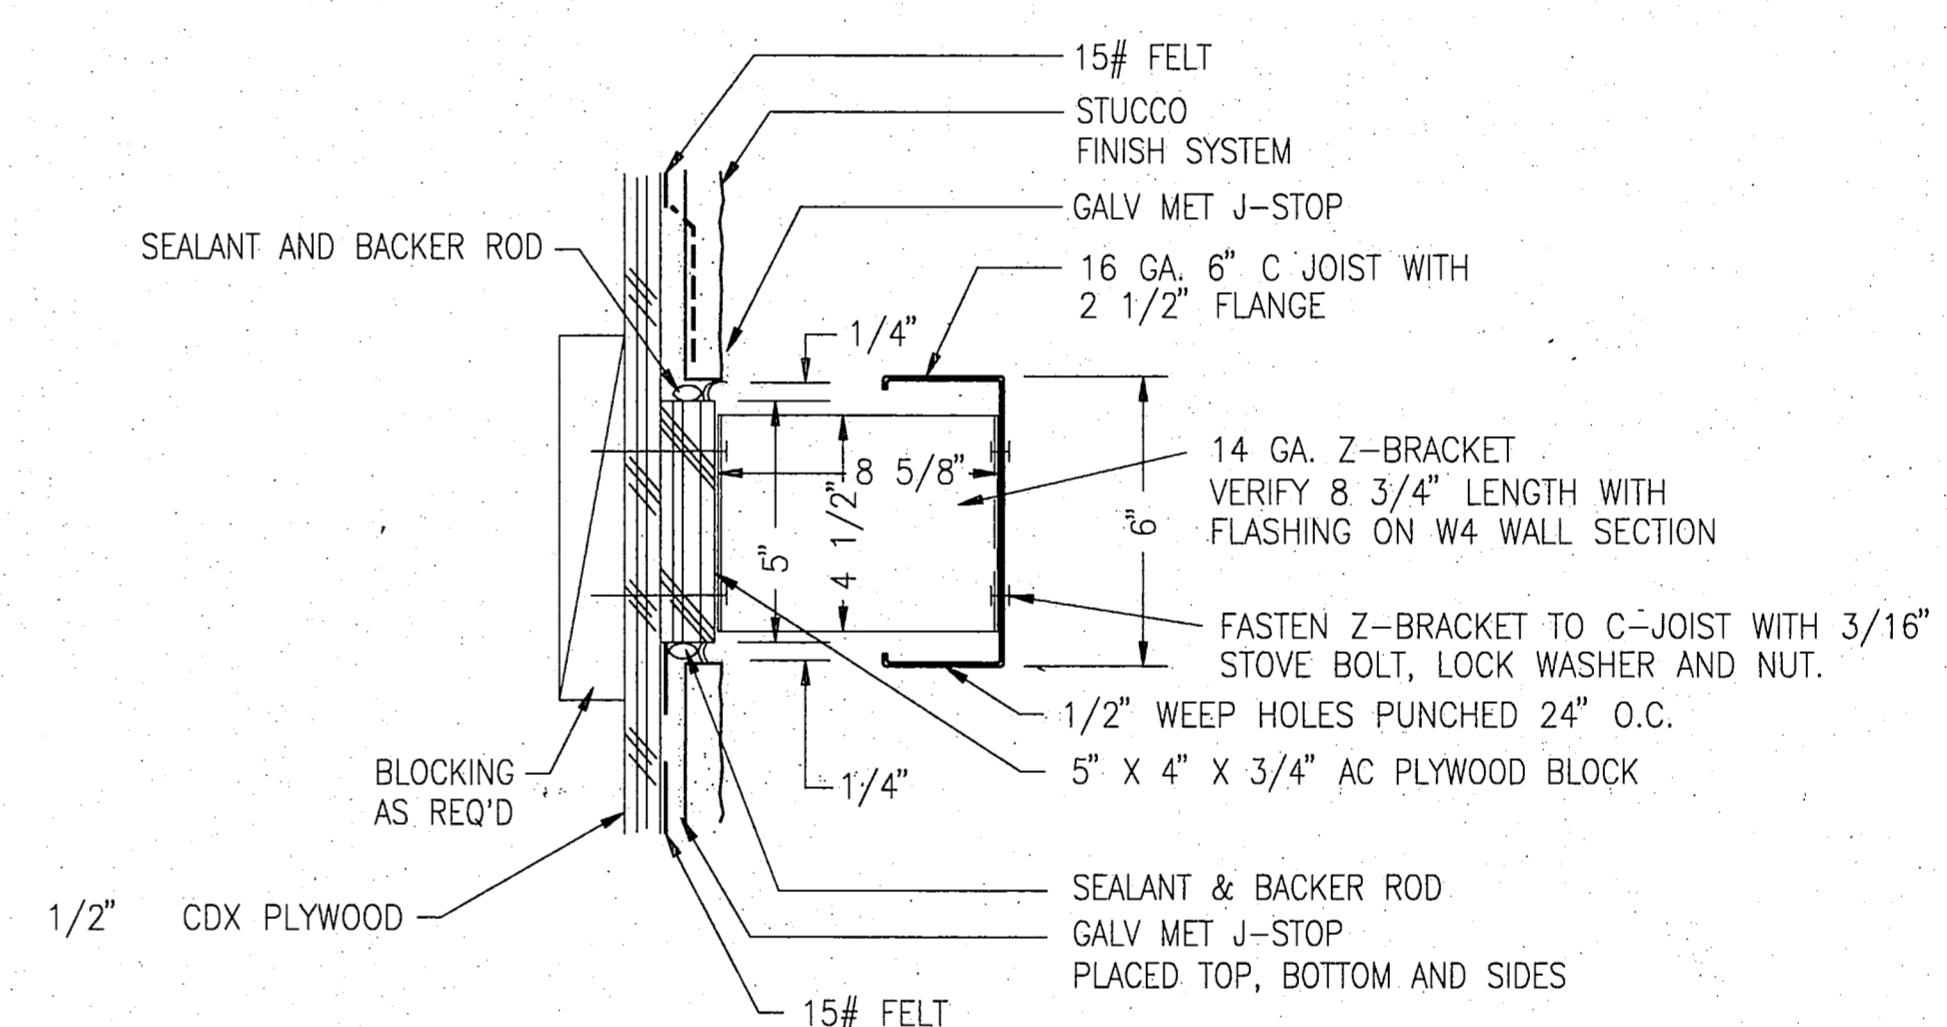

**SECTION B-B**

SCALE: 1 1/2" = 1'-0"

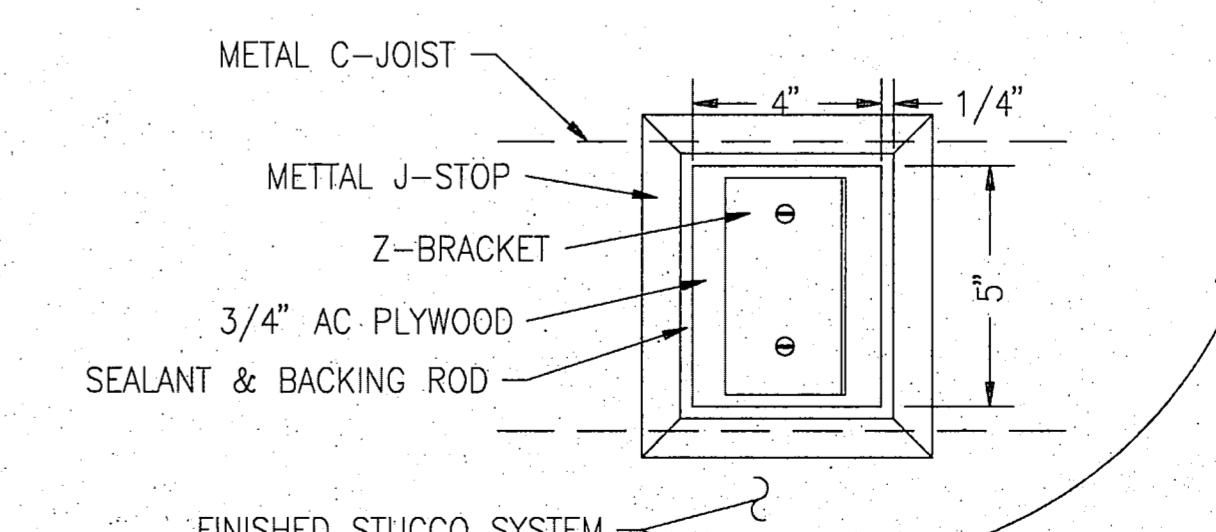

**SECTION A-A**

SCALE: 1 1/2" = 1'-0"

PROJECT NO. 115.00  
DRAWN BY RBB  
CHECKED BY RBB  
DATE MAR 1994  
REVISED

TITLE  
**EXTERIOR  
DETAILS**

SHEET NO.

**A 7.2**

## WINDOW SCHEDULE


WINDOW TYPE	CONSTR	EXTERIOR FINISH	INTERIOR FINISH	GLAZING	HEAD DETAIL	JAMB DETAIL	SILL DETAIL	HARDWARE	REMARKS
A	AL CLAD	COLOR I		GL 1	1/A80	2/A80	5/A80	-	
B	AL CLAD	COLOR I		GL 1	4/A80	2/A80	2/A80	-	
C	AL CLAD	COLOR I		GL 1	5/A80	1/A80	2/A80	-	
D	AL CLAD	COLOR I		GL 1	1/A80	2/A80	2/A80	-	
E	AL CLAD	COLOR I		GL 1	4/A80	2/A80	2/A80	-	
F	AL CLAD	COLOR I		GL 1	1/A80	2/A80	2/A80	-	
G	AL CLAD	COLOR I		GL 4	1/A80	2/A80	2/A80	-	
H	AL CLAD	COLOR I		GL 1	4/A80	2/A80	2/A80	-	
I	AL CLAD	COLOR I		GL 2	1/A80	2/A80	2/A80	-	
J	AL CLAD	COLOR I		GL 1	1/A80	2/A80	3/A80	3/A80	
K	AL CLAD	COLOR I		GL 1	13/A81	14/A81	15/A81	15/A81	
L	NOT USED								
M	AL CLAD	COLOR I		GL 1	5/A81	10/A81	2/A80 sim	-	
N	AL CLAD	COLOR I		GL 1	1/A80 sim	2/A80 sim	5/A81	-	
O	HM	COLOR I		GL 2	-	-	-	-	3
RA	METAL			GL 3	2/A81	2/A81	2/A81	-	1, 2
RB	METAL			GL 3	2/A81	2/A81	2/A81	-	1, 2

## NOTES:

- REFER TO DIVISION 8 FOR FURTHER WINDOW AND GLAZING INFORMATION.
- ALL DIMENSIONS SHOWN ON WINDOW SCHEDULE AND WINDOW ELEVATIONS REFER TO THE WINDOW FRAME SIZE UNLESS OTHERWISE NOTED.
- ALL WINDOWS ARE FIXED, U.O.N.
- GLAZING SHALL BE TEMPERED WHEN LOCATED WITHIN 12" OF A DOOR THAT IS IN THE SAME PLANE AS THE WINDOW. RE: 1988 UBC, SEE 5406(d).
- WINDOWS LOCATED IN ONE HOUR WALLS TO HAVE  $\frac{1}{4}$ " WIRE GLASS.
- GL-1 - RE. SPECIFICATIONS SEC 08800, 202, B
- GL-2 - RE. SPECIFICATIONS SEC 08800, 202, C
- GL-3 - RE. SPECIFICATIONS SEC 08800, 203, D
- COLOR 1 - RE. SPECIFICATIONS SEC 08615
- GL-4 - RE. SPECIFICATIONS SEC 08800, 202, D.

## REMARKS:

- GL-2 WHEN WITHIN 12" OF DOOR IN SAME PLANE.
- GL-3 WHEN LOCATED WITHIN A 1 HOUR RATED WALL.
- PART OF HM DOOR FRAME.
- WINDOW TYPE F/A80 - METAL TRIM BAND THAT IS BETWEEN THE UPPER AND LOWER HALVES OF THE WINDOW IS DETAILED SIMILAR TO 4/A80
- HEADERS - REFER TO STRUCTURAL DRAWINGS FOR HEADER SIZES. LOCATE ONE HEADER MEMBER ON THE EXTERIOR SIDE AND ONE MEMBER ON THE INTERIOR SIDE. FILL THE CAVITY BETWEEN THE HEADERS WITH BATT INSULATION.
- UPPER WINDOWS OF TYPE F DO NOT RECEIVE LOUVERED BLINDS.


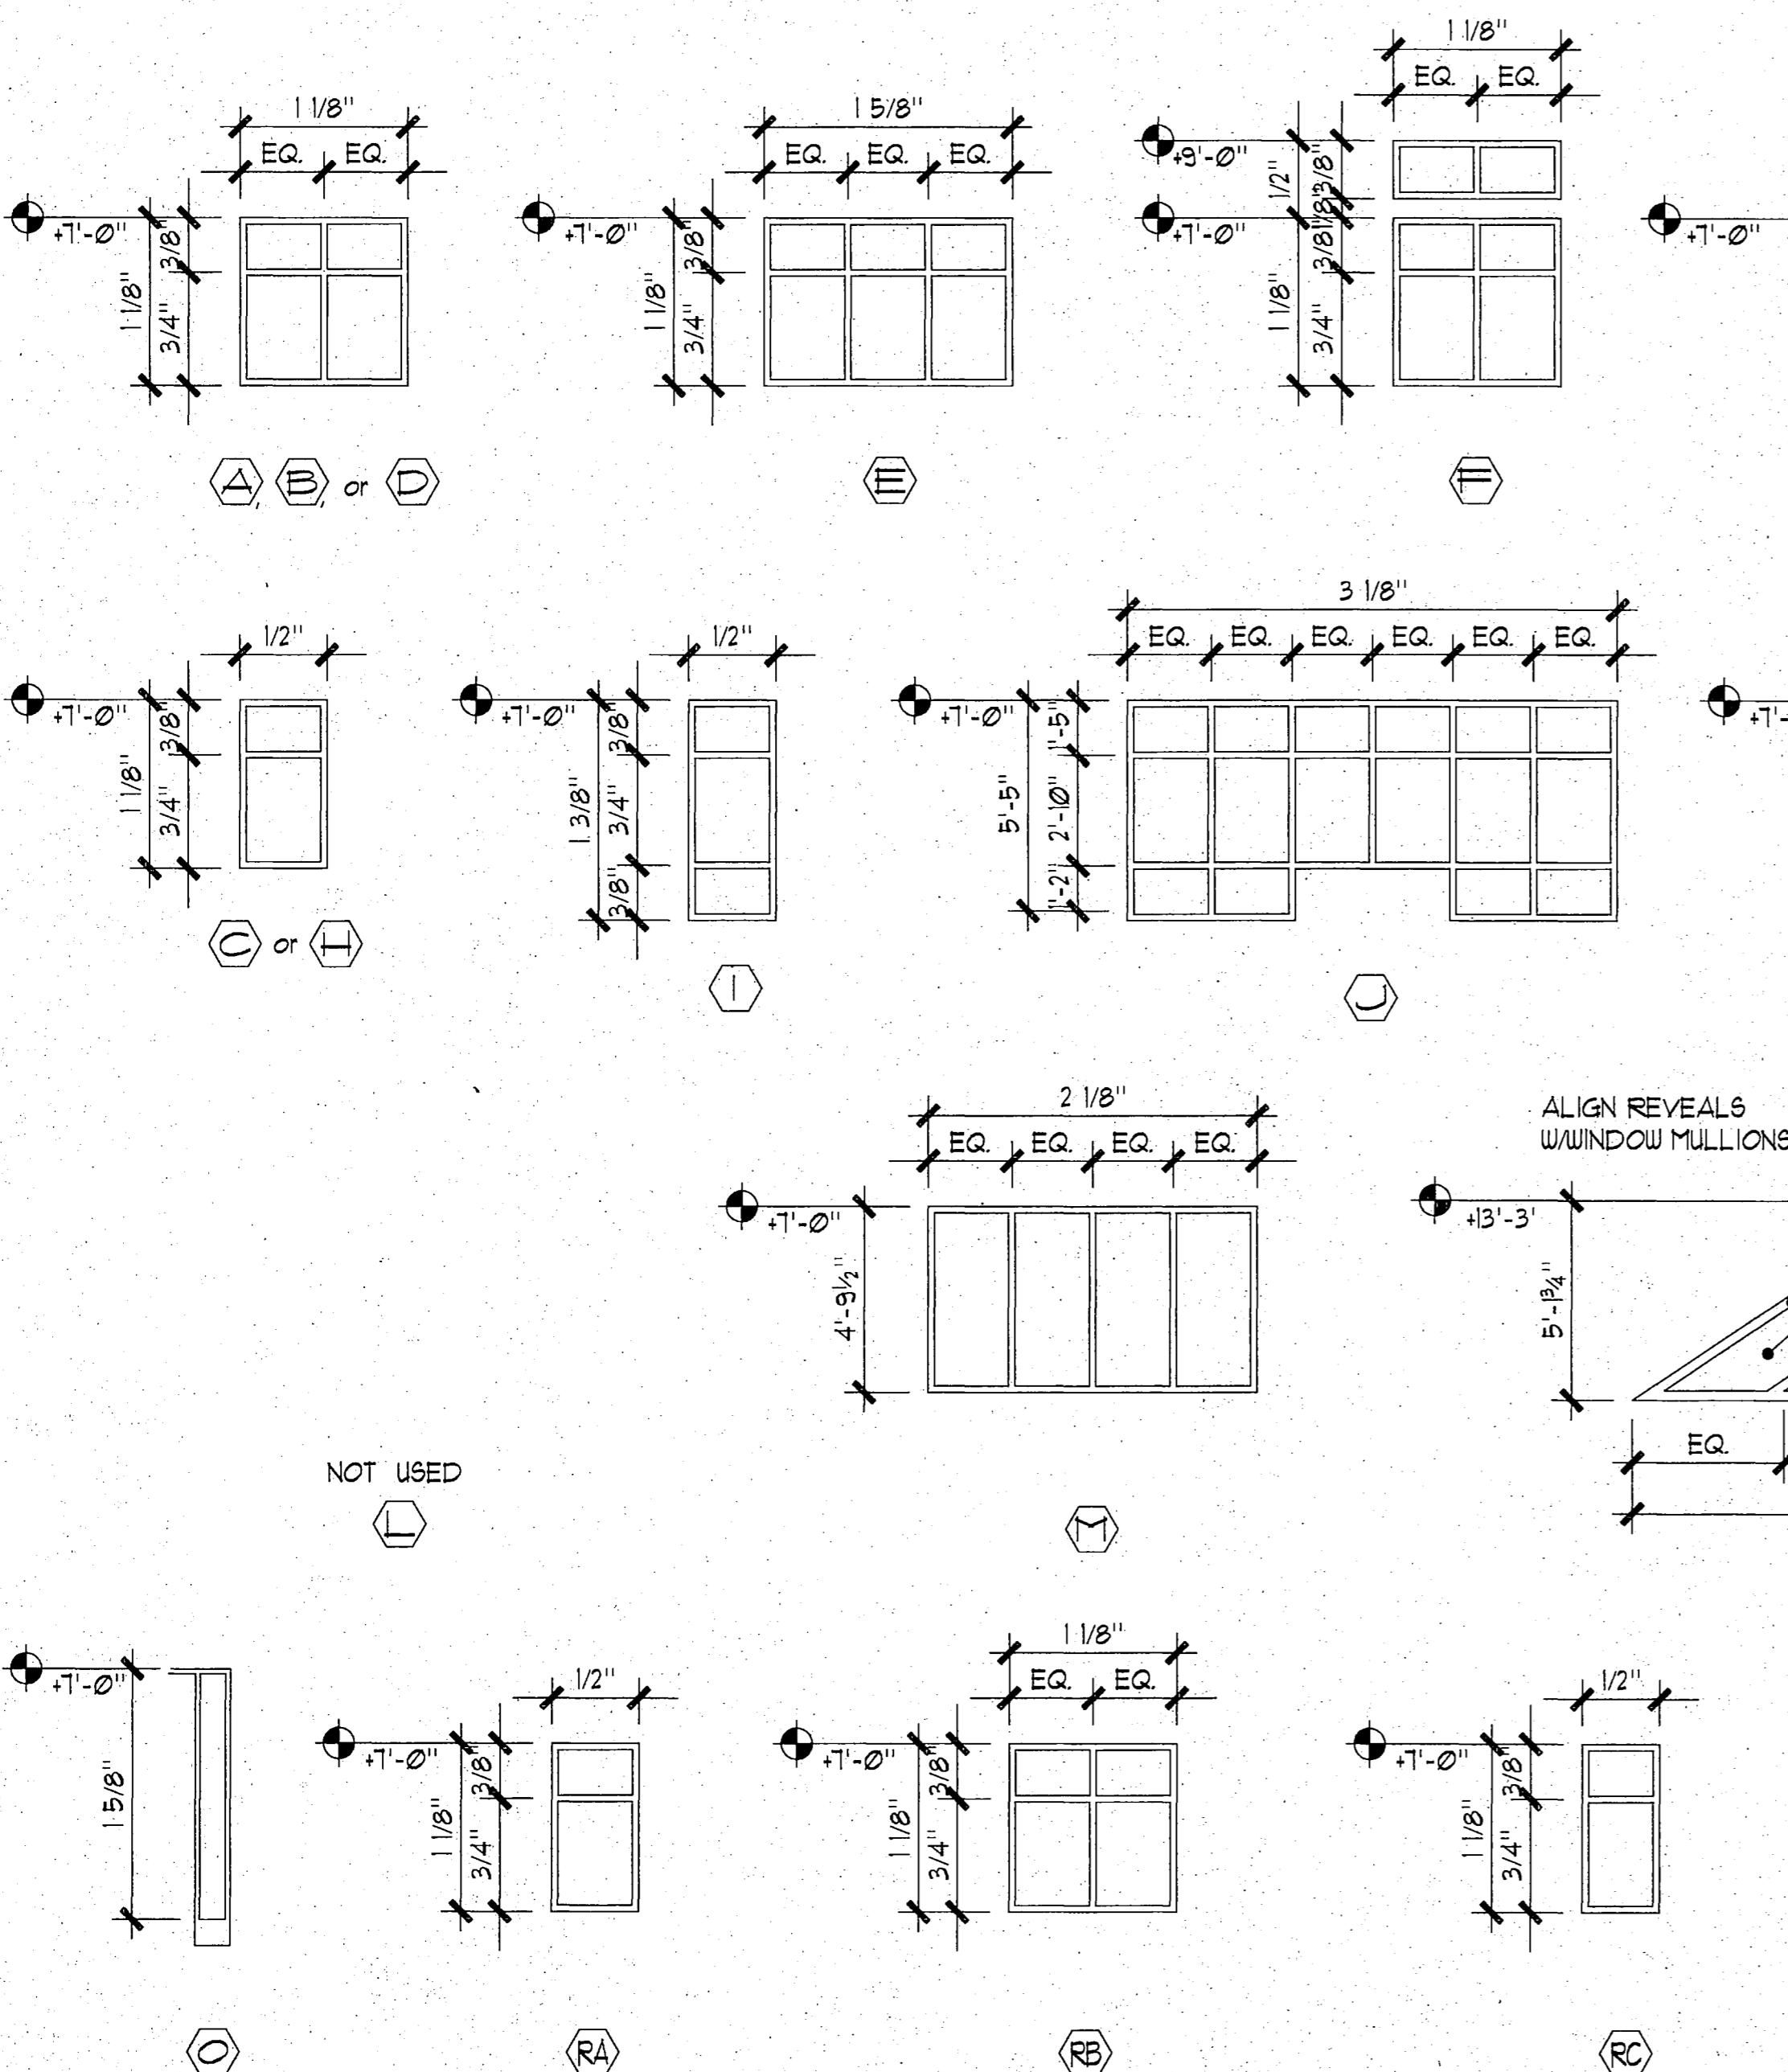


## RECORD DRAWING

*[Signature]*  
CITY ENGINEER, CITY OF FAIRBANKS


4/8/96  
DATE

13 WINDOW TYPES  
SCALE: 1/4" = 1'-0"

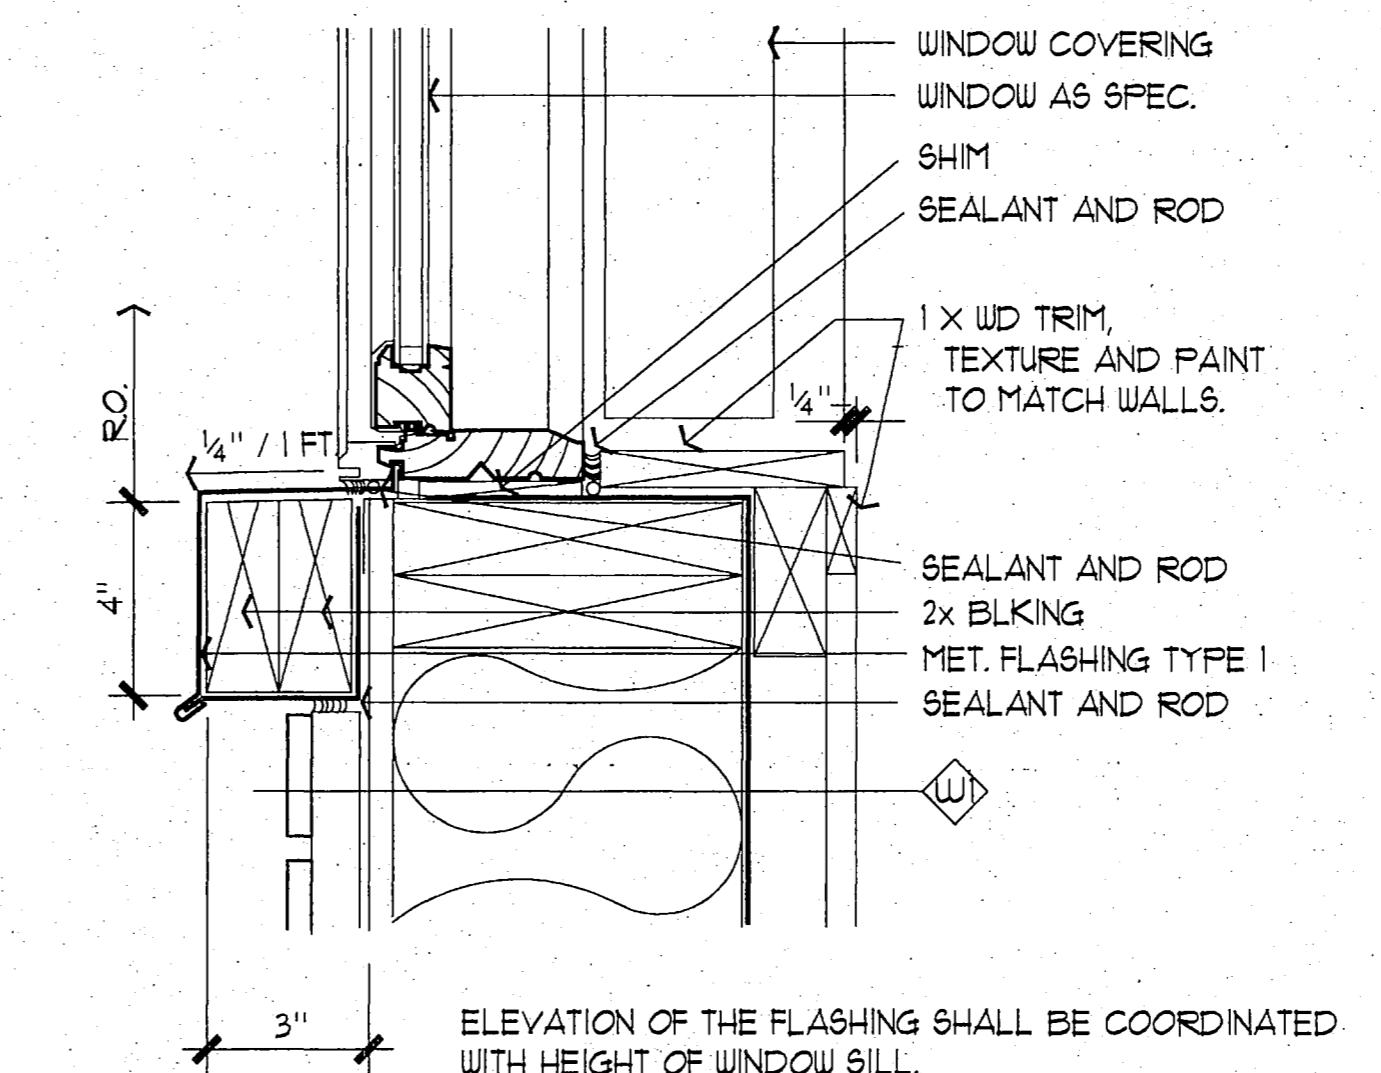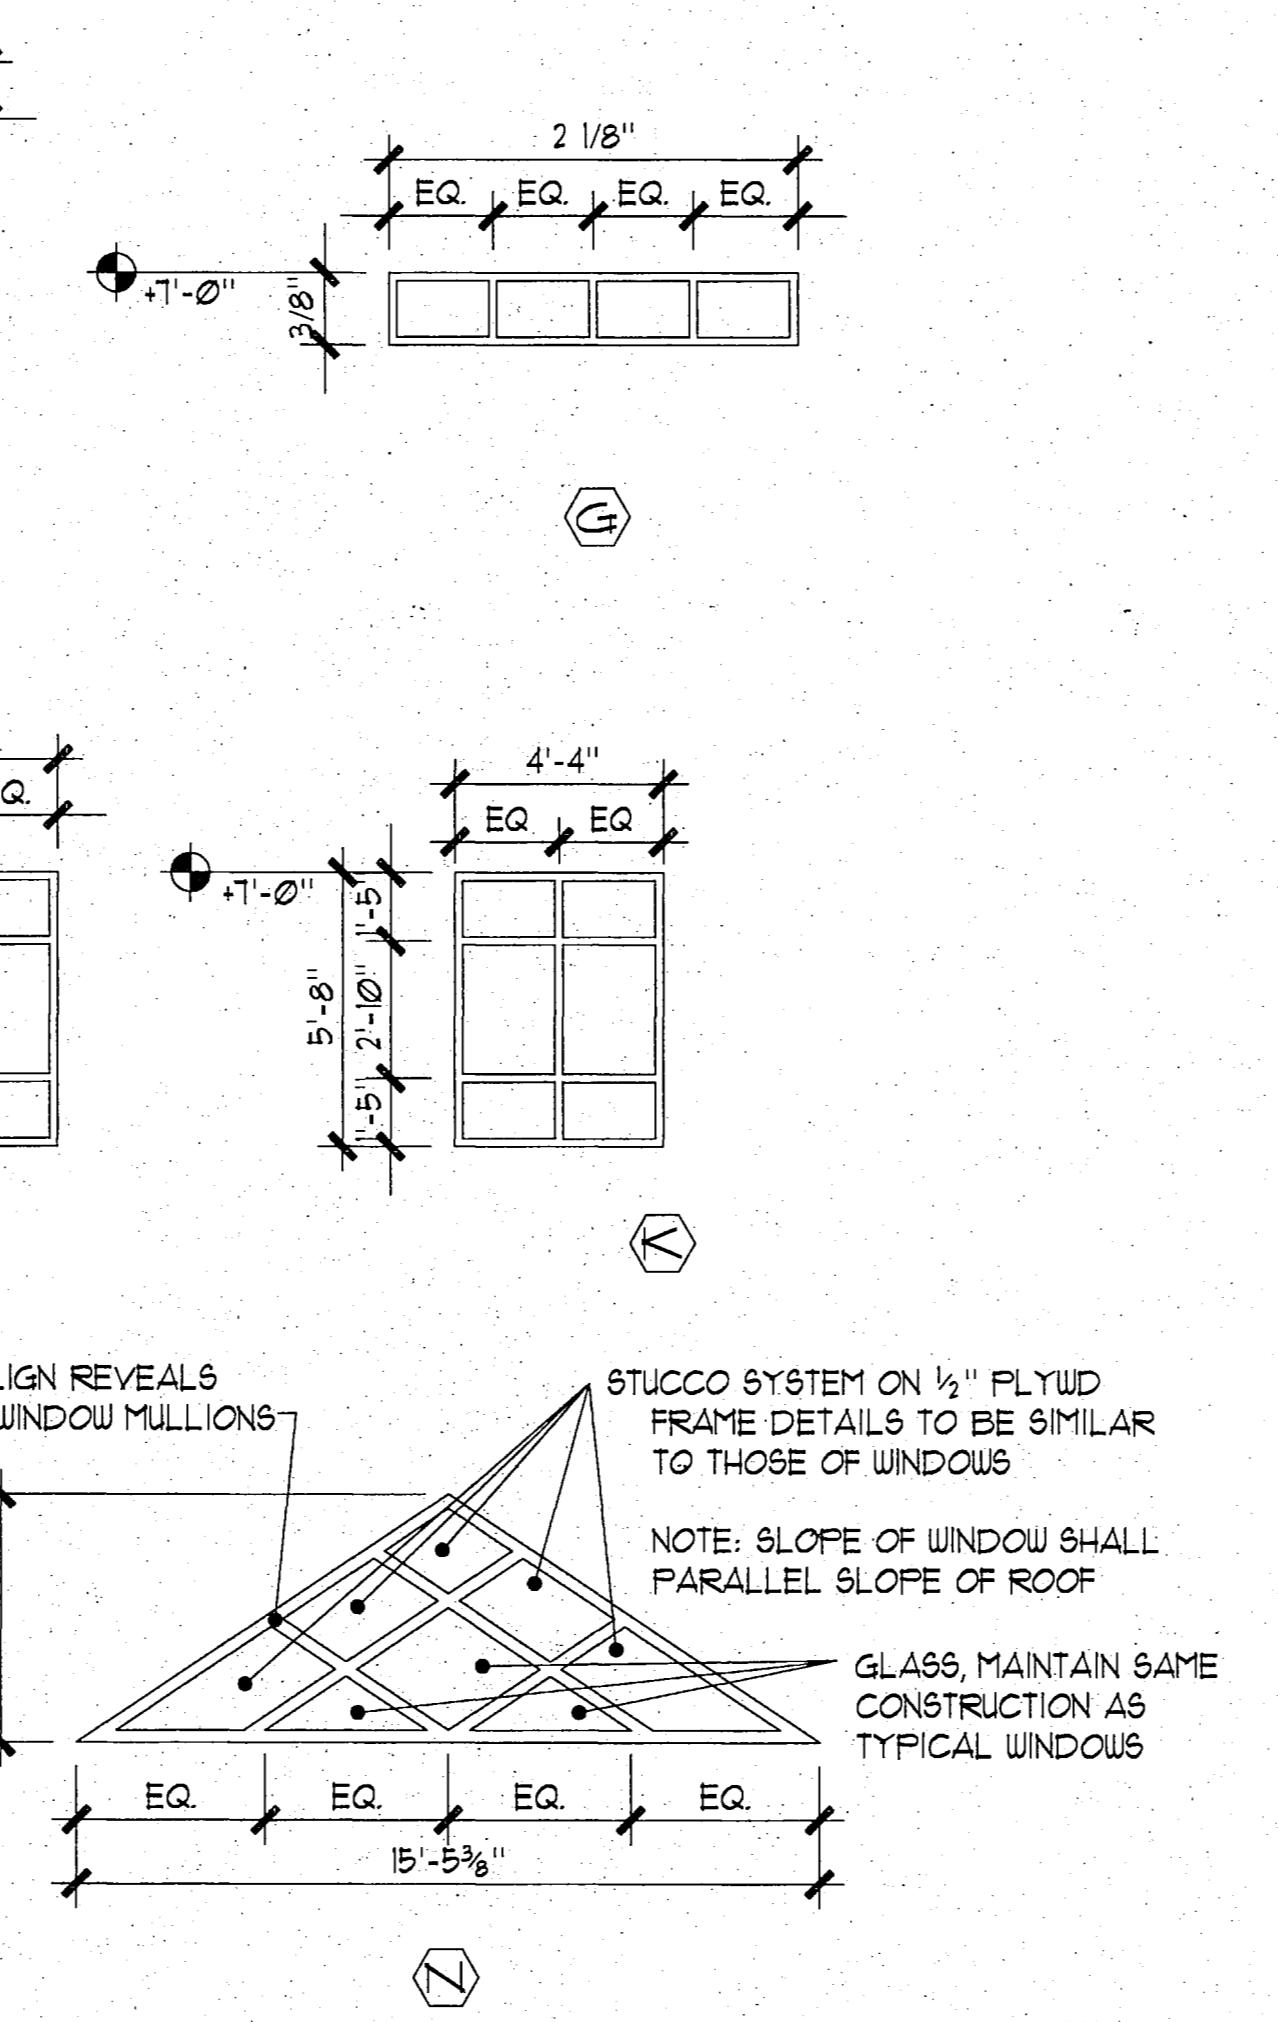


## WINDOW SILL

SCALE: 3" = 1'-0"

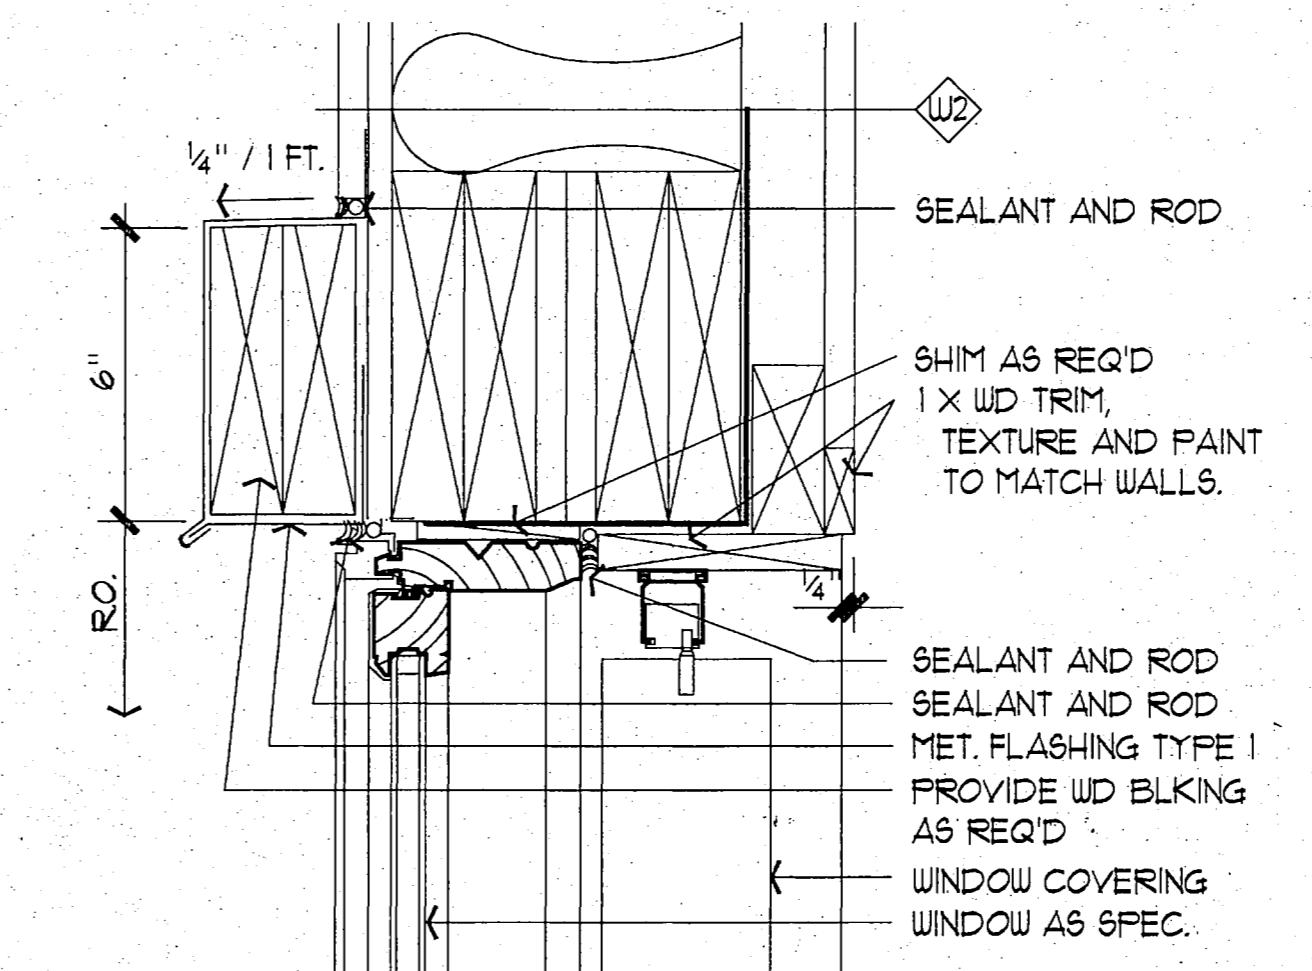


## WINDOW HEADER

SCALE: 3" = 1'-0"

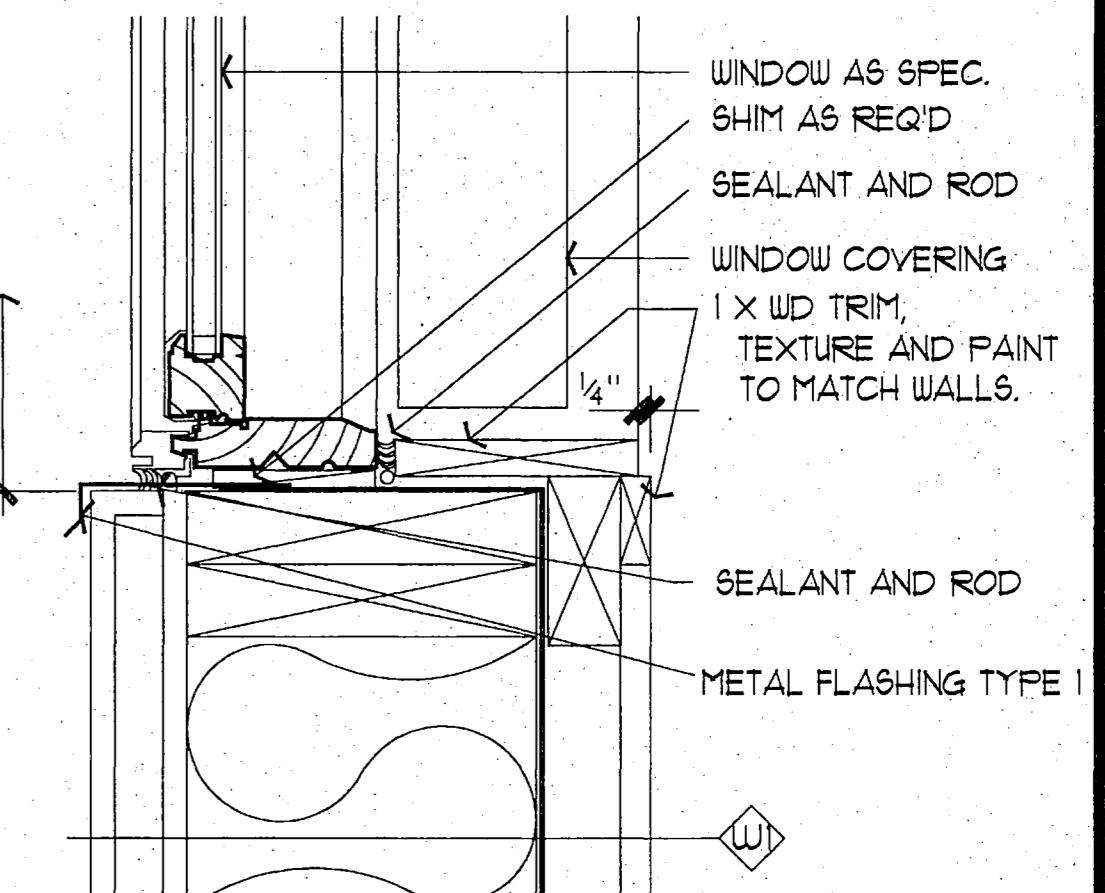


## WINDOW SILL (JAMB SIM.)

SCALE: 3" = 1'-0"

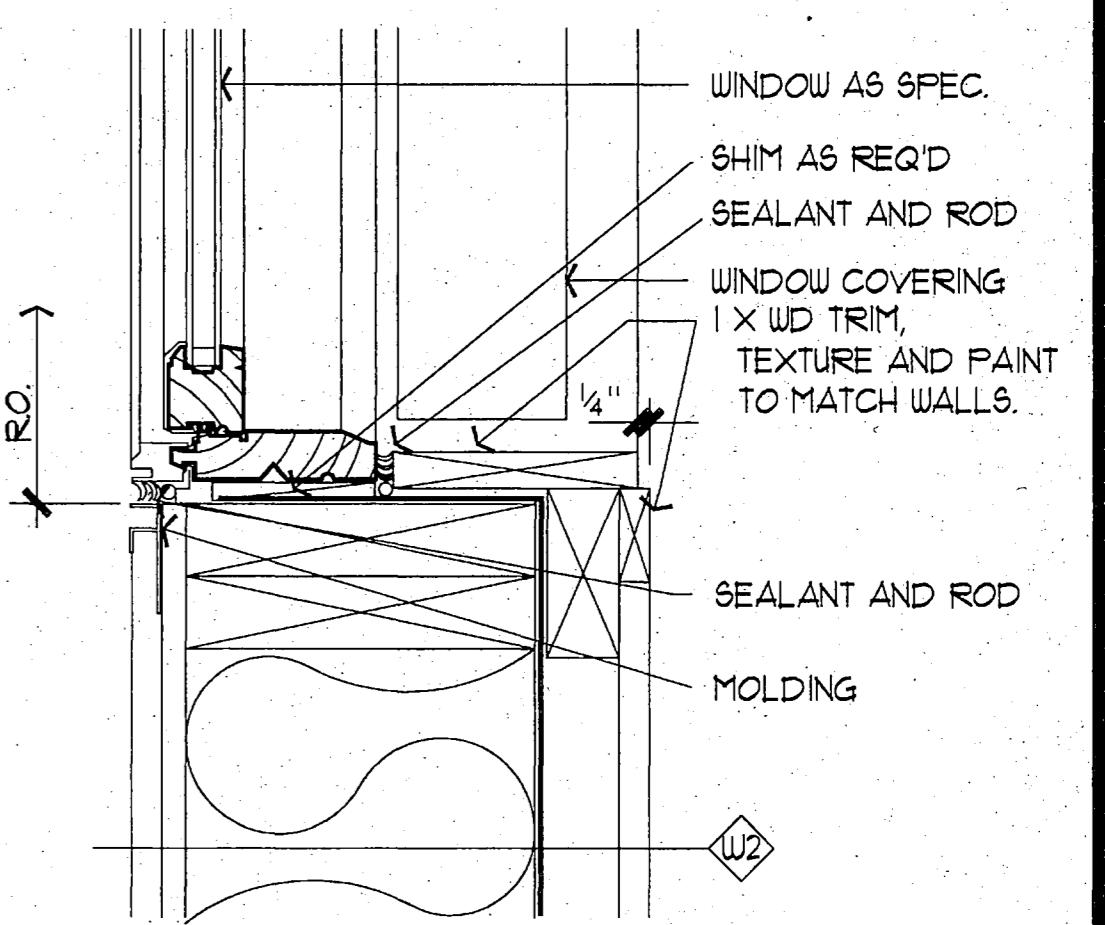


## WINDOW SILL (JAMB SIM.)

SCALE: 3" = 1'-0"

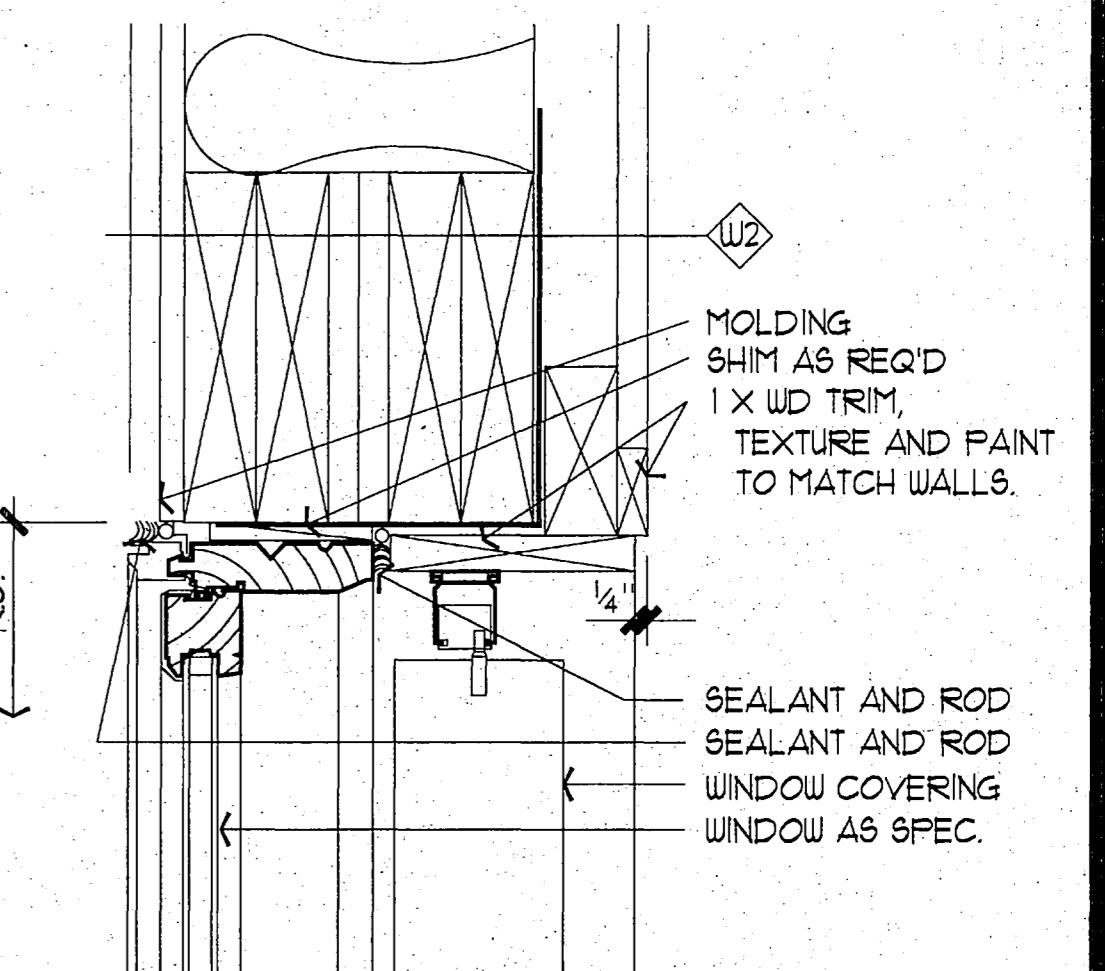

## WINDOW HEADER

SCALE: 3" = 1'-0"

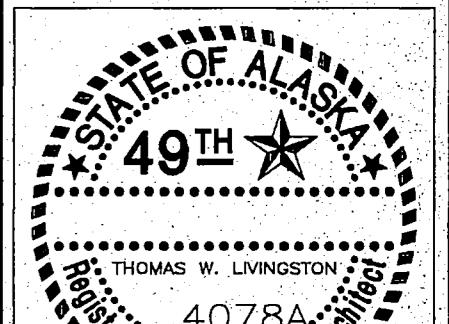

PROJECT NO. 115.00  
DRAWN BY JB,AS  
CHECKED BY JB,JA  
DATE DEC 9, 1992  
REVISED

TITLE  
WINDOW SCHEDULE & DETAILS  
SHEET NO.





A8.0

F 3.0.074





City of Fairbanks  
Fairbanks, Alaska  
FAIRBANKS HEALTH CENTER

STATE OF ALASKA  
49TH  
4078A  
Professional Engineer  
Thomas W. Livingston  
Anchorage, Alaska 99503-5790  
(907) 563-2055





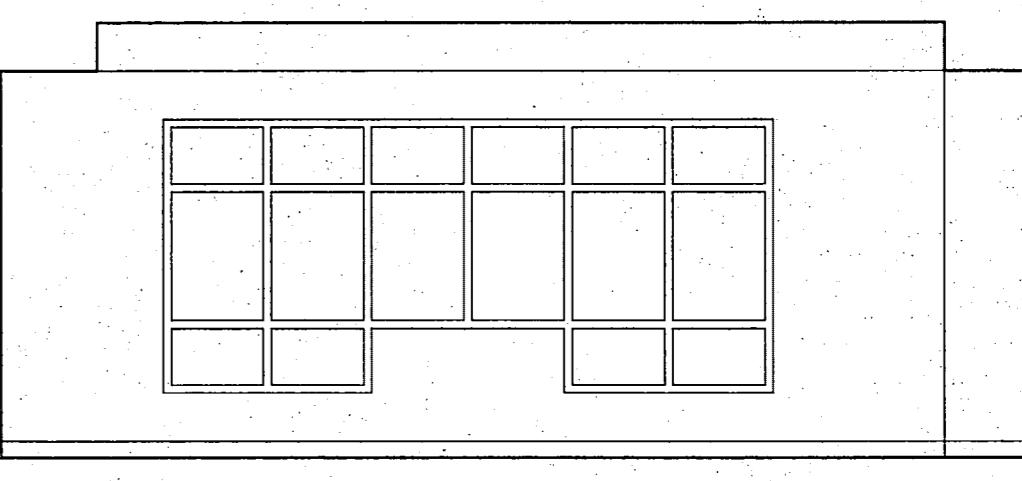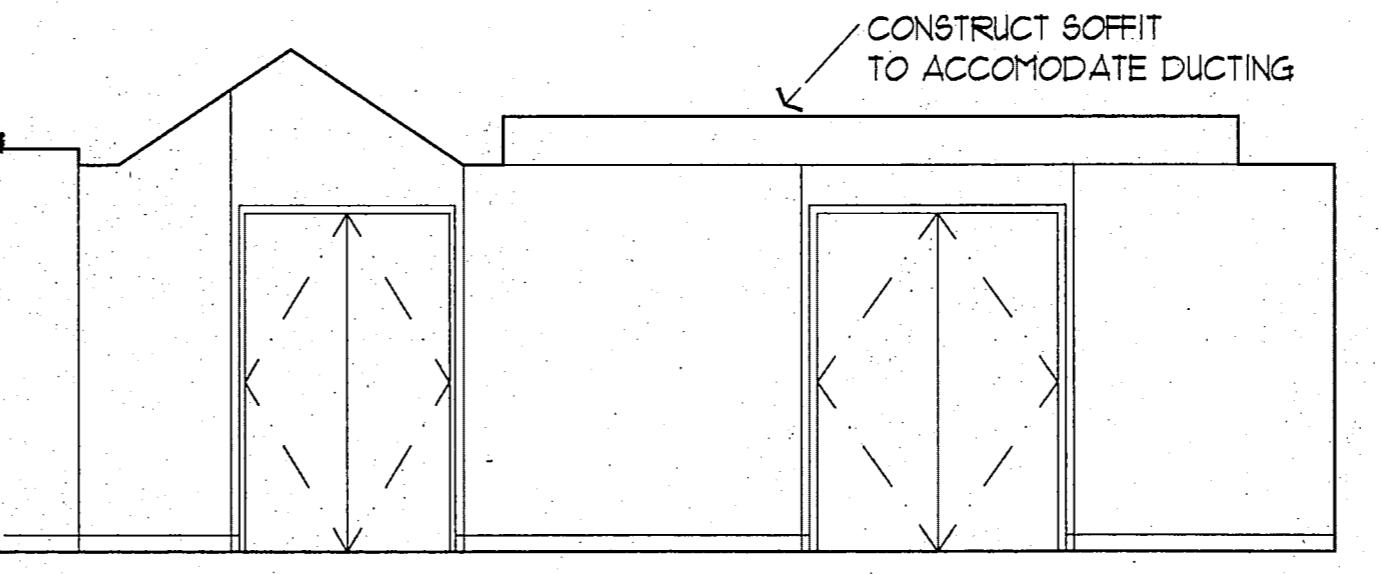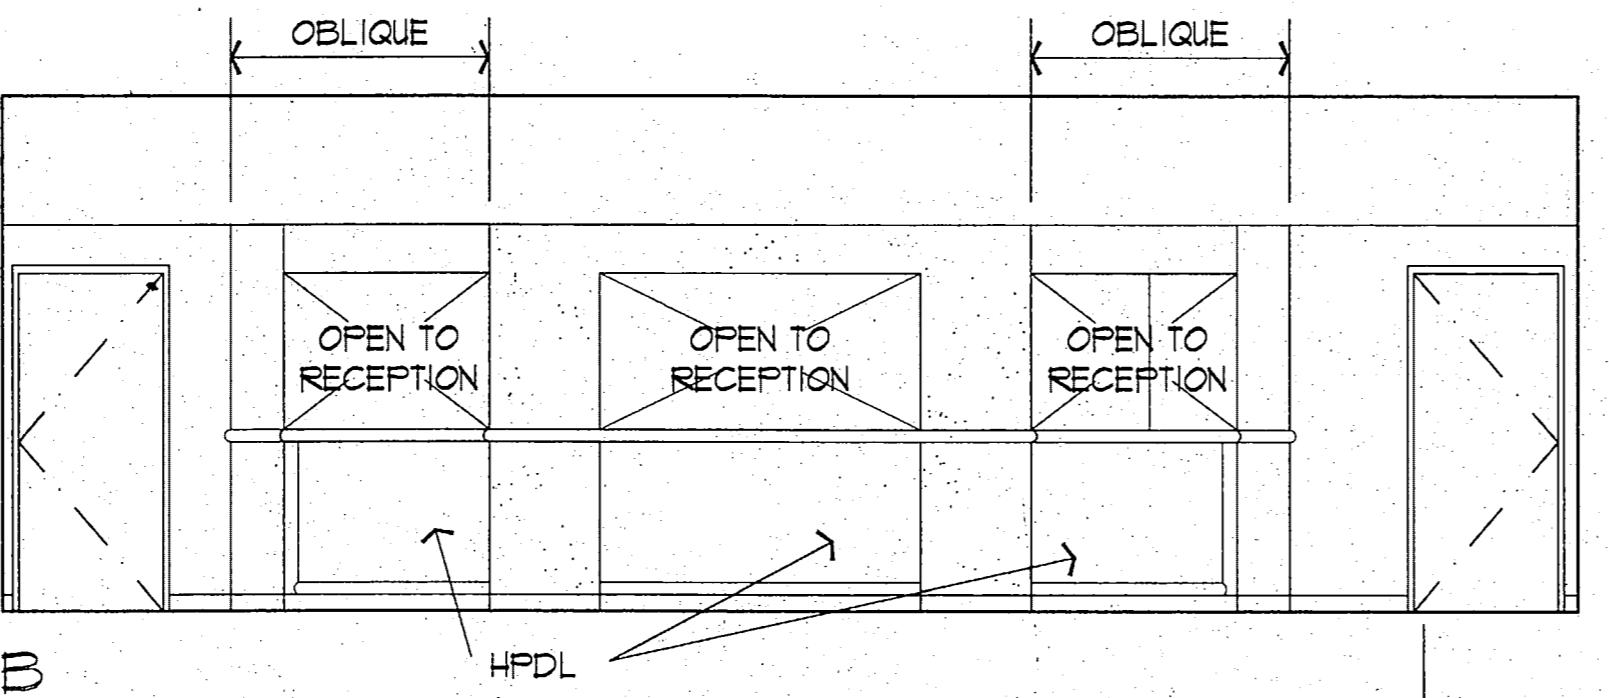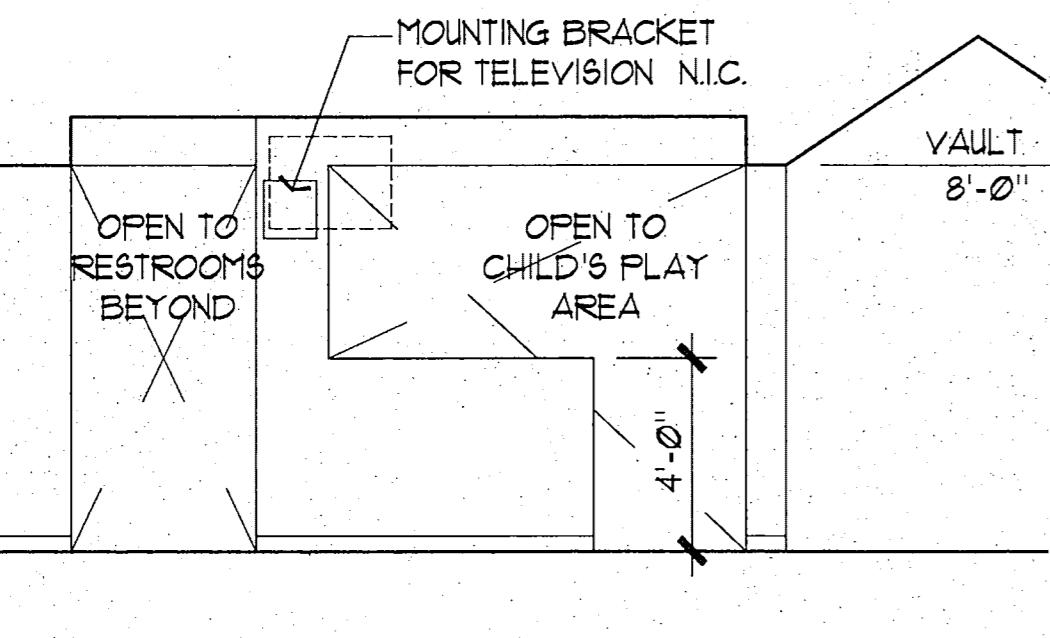


15 WAITING AREA 105  
SCALE: 1/4" = 1'-0"

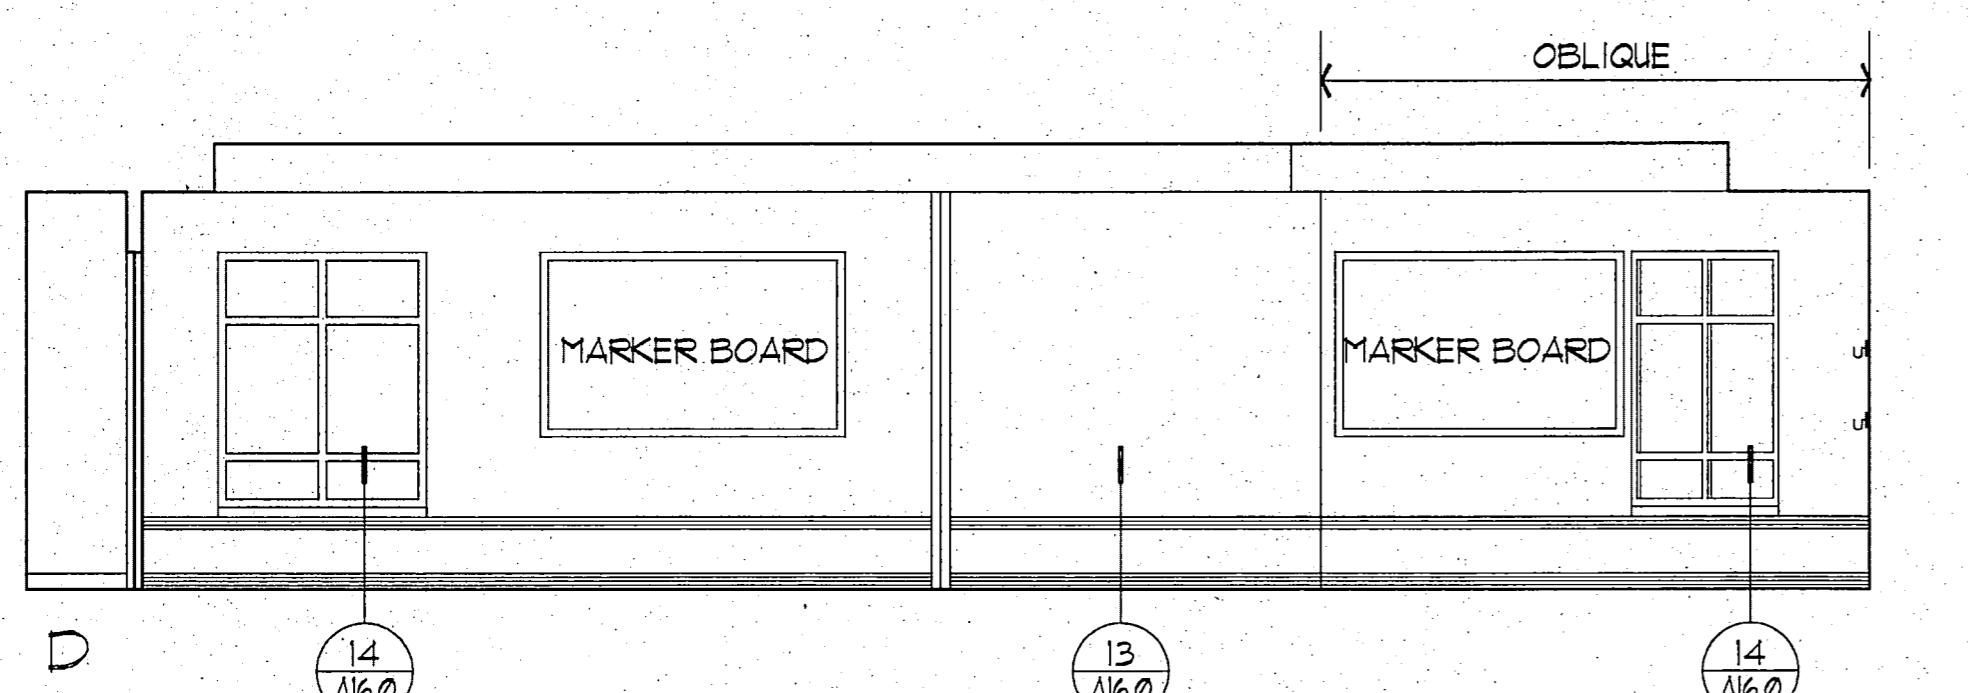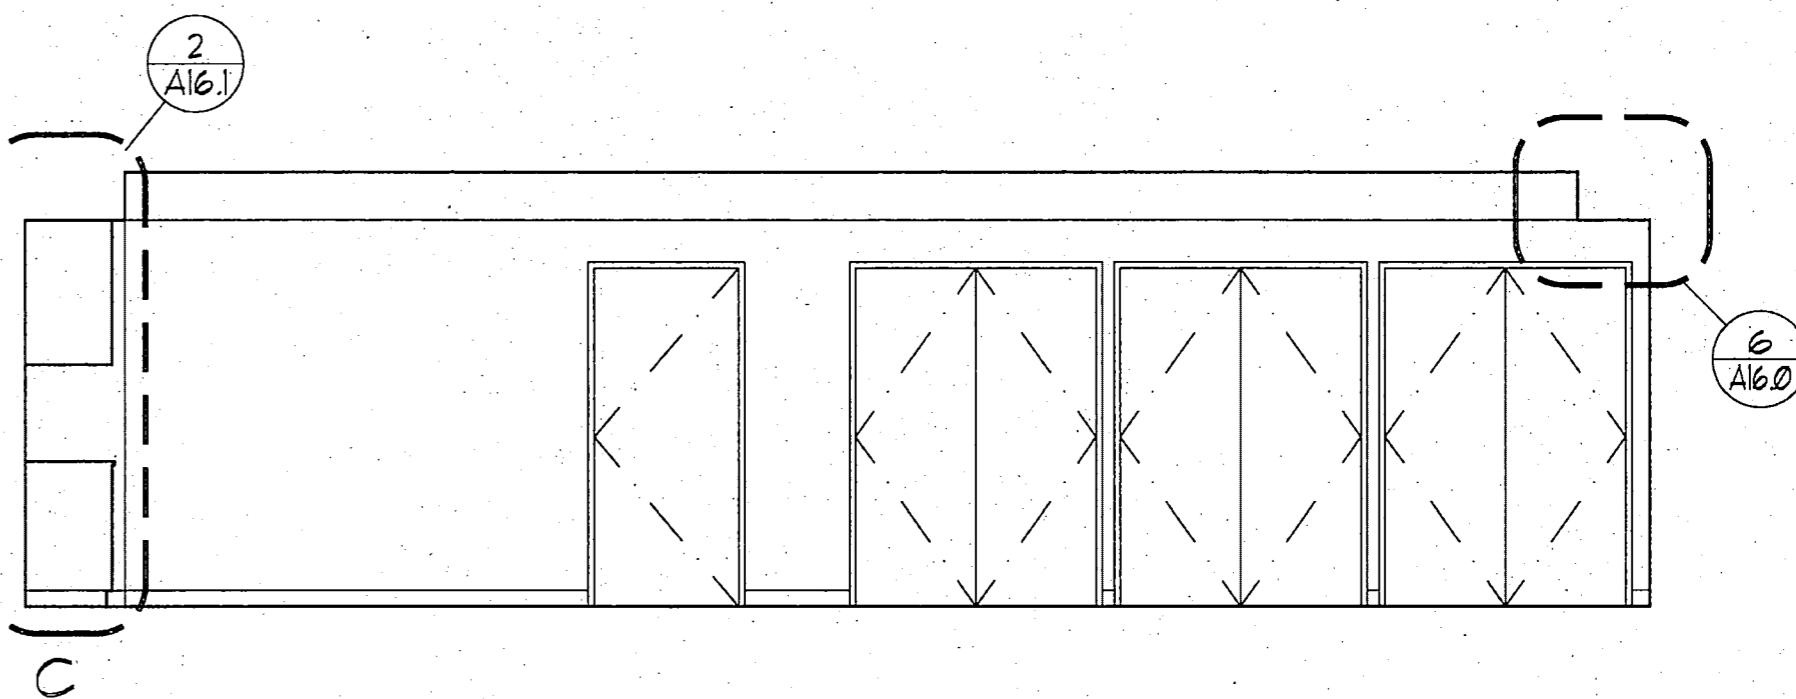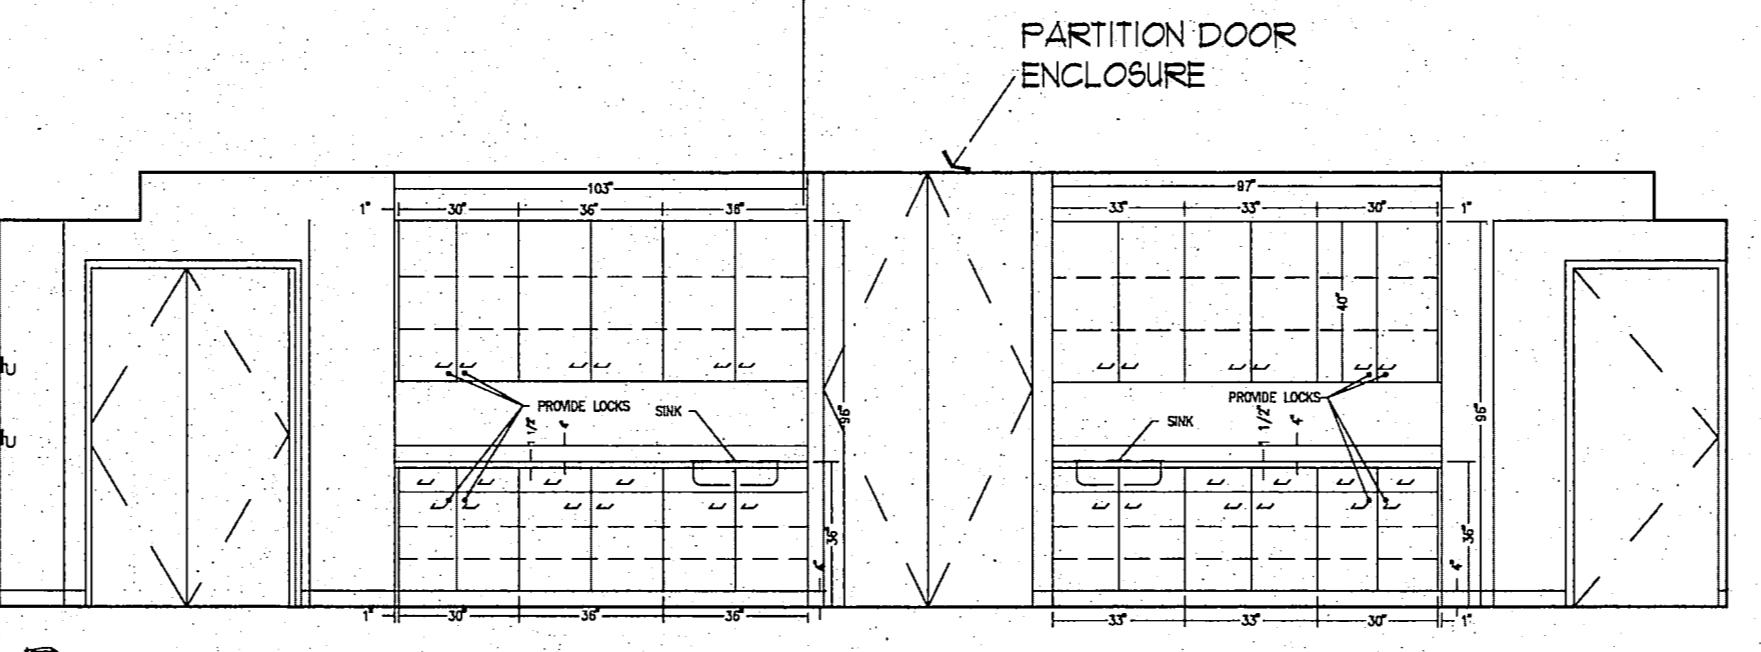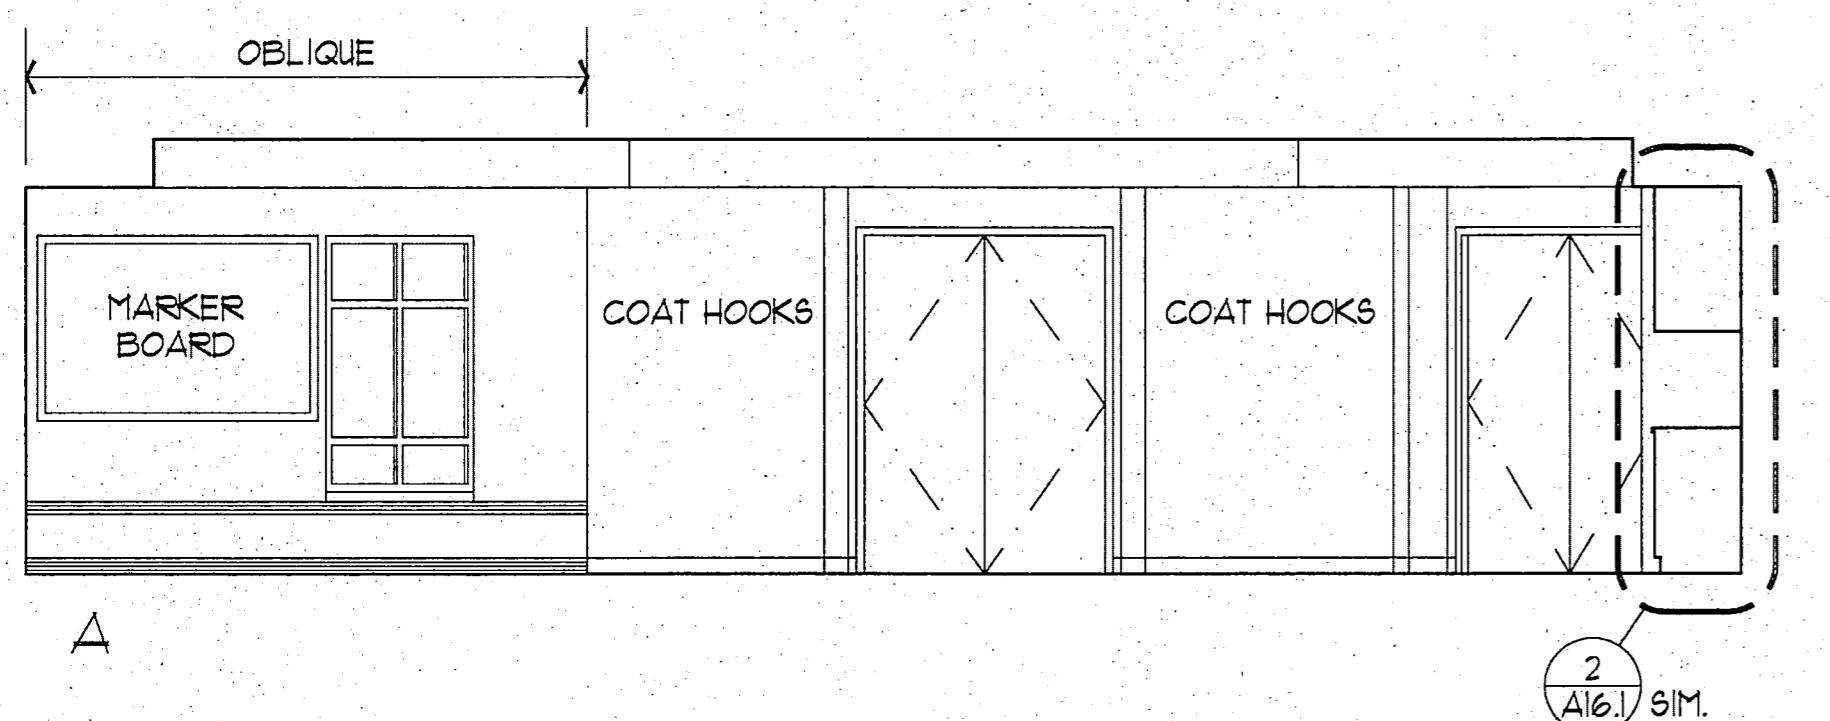

14 CONFERENCE ROOM 107  
SCALE: 1/4" = 1'-0"

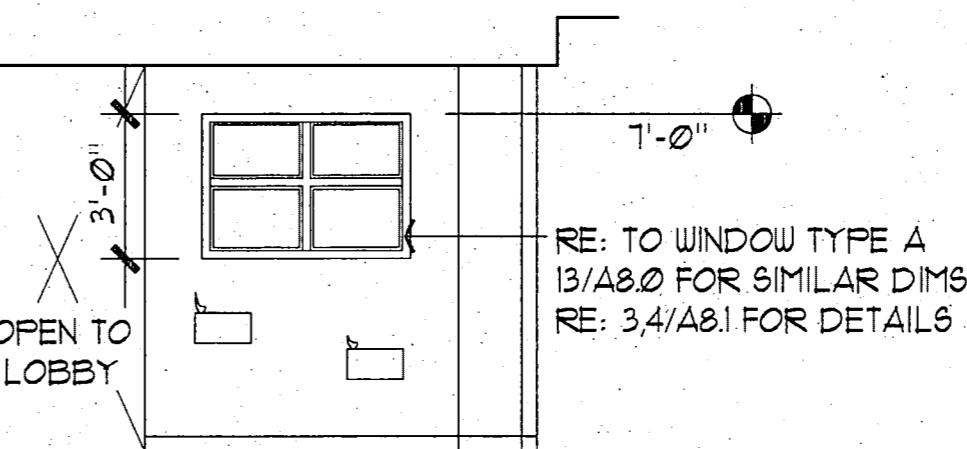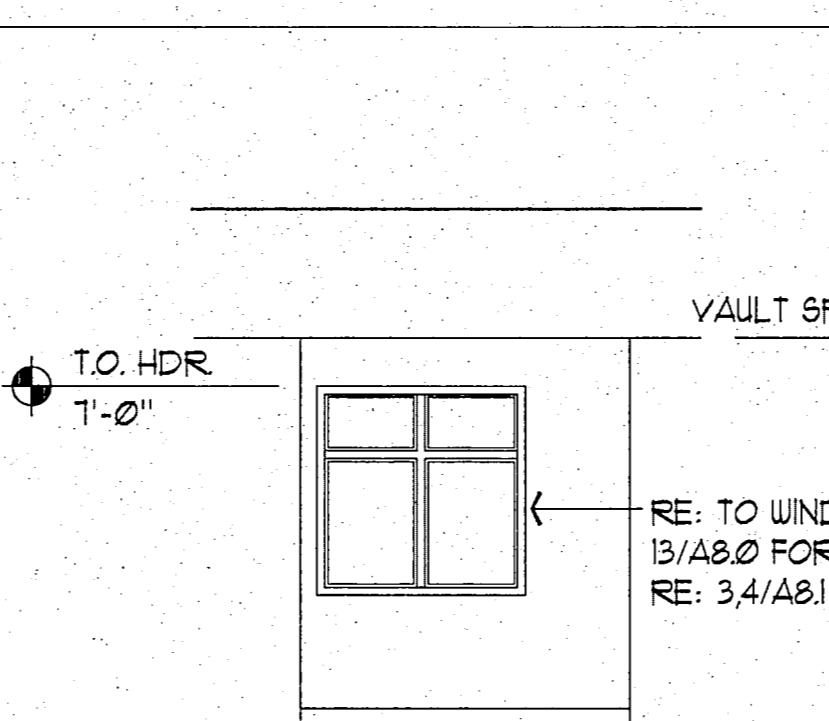

7 LOBBY 101  
SCALE: 1/4" = 1'-0"

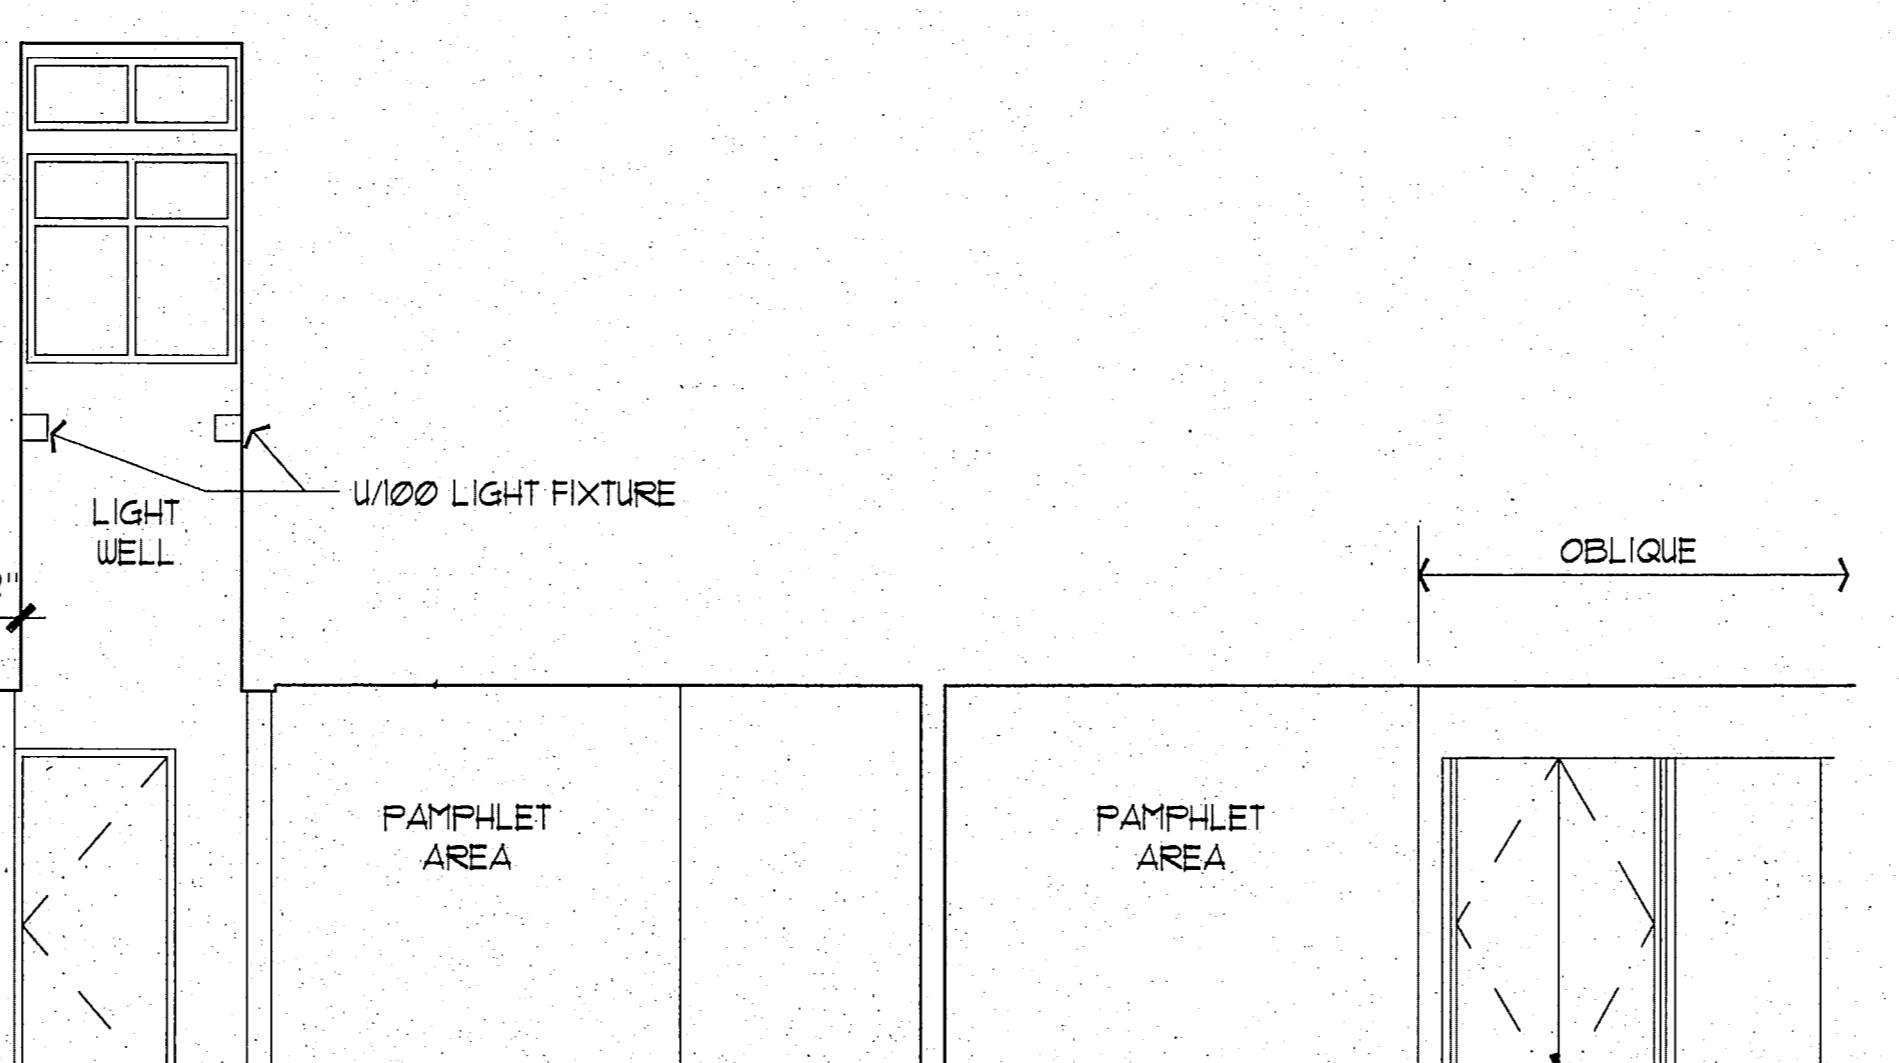

13 CORRIDOR 110  
SCALE: 1/4" = 1'-0"


NOTE:  
1. RE. 15/A9.2 FOR KEY AND MOUNTING HEIGHTS OF ACCESSORIES AND  
MOUNTING HEIGHTS OF FIXTURES.

## RECORD DRAWING

*Rufus B. Bond*  
CITY ENGINEER, CITY OF FAIRBANKS

4/8/96

DATE

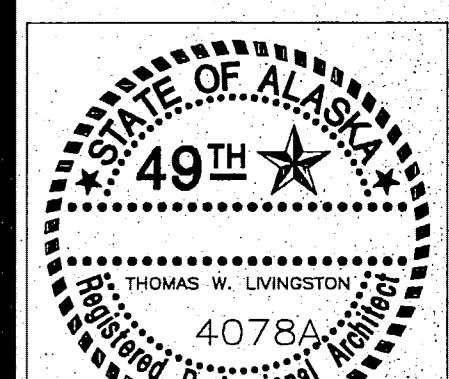

PROJECT NO. 115.00  
DRAWN BY OM,ALS  
CHECKED BY JB,JA  
DATE DEC 9, 1992  
REVISED

TITLE  
INTERIOR ELEVATIONS  
SHEET NO.


A9.0

# RECORD DRAWING

*John B. Beach*  
CITY ENGINEER, CITY OF FAIRBANKS

4/18/96


DATE

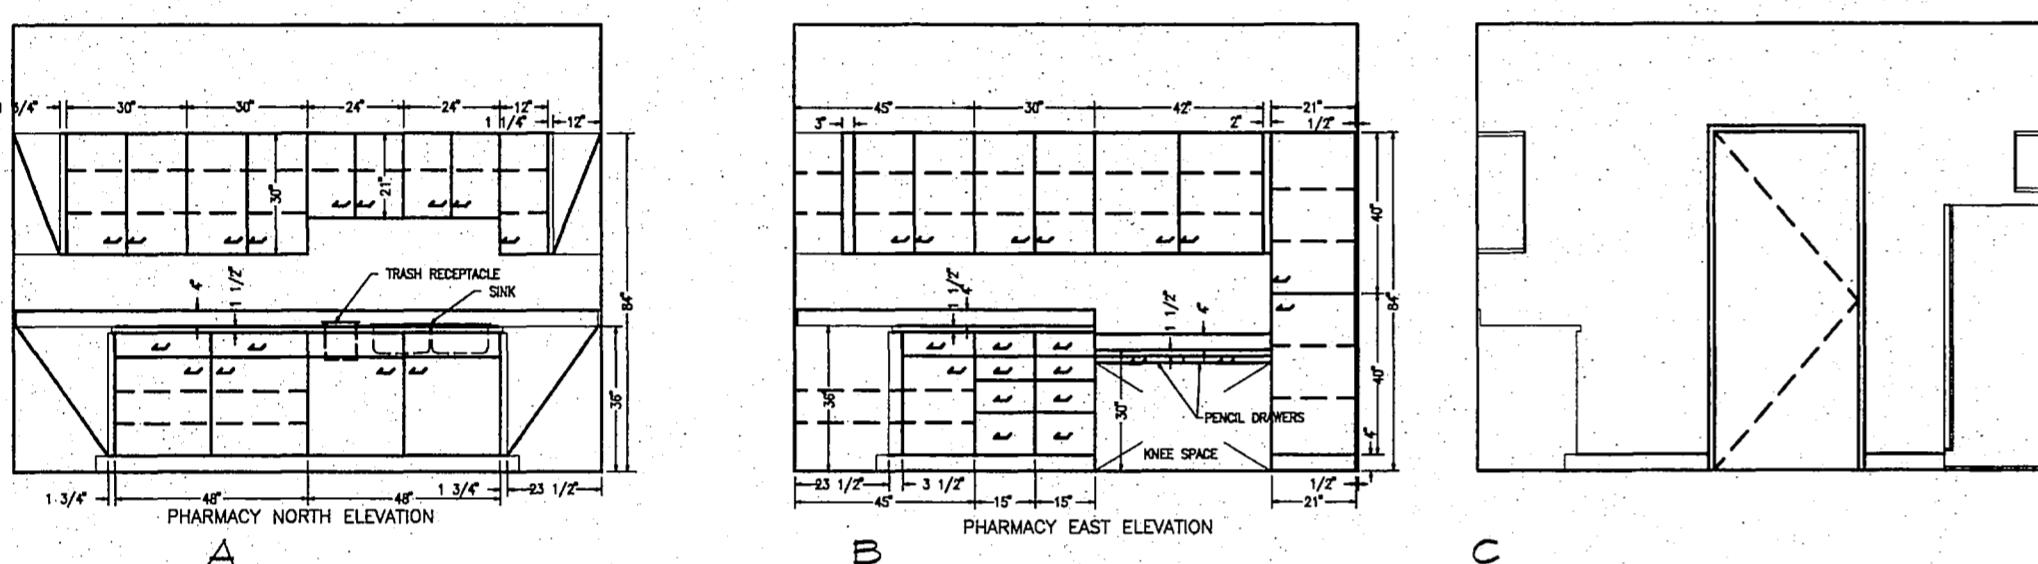

## ⑭ PHARMACY 129




SCALE: 1/4" = 1'-0"

- NOTE:  
1. RE. 15/A92 FOR KEY AND MOUNTING HEIGHTS OF ACCESSORIES  
AND MOUNTING HEIGHTS OF FIXTURES.  
2. RE. 2/16.1 FOR TYP. CASEWORK DETAILS.

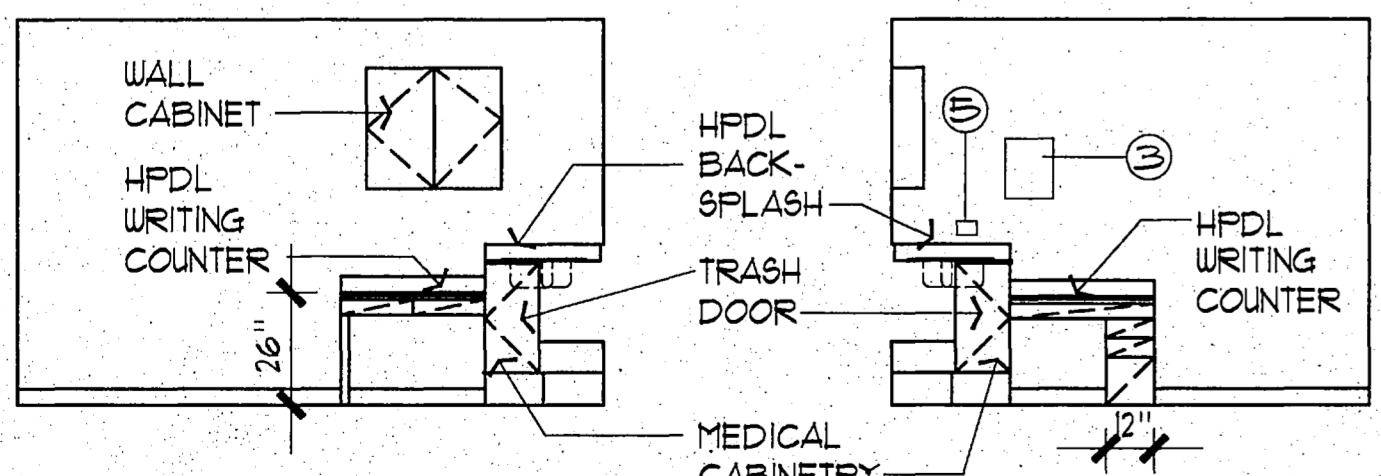





## ⑬ TYPICAL EXAM ROOM

SCALE: 1/4" = 1'-0"

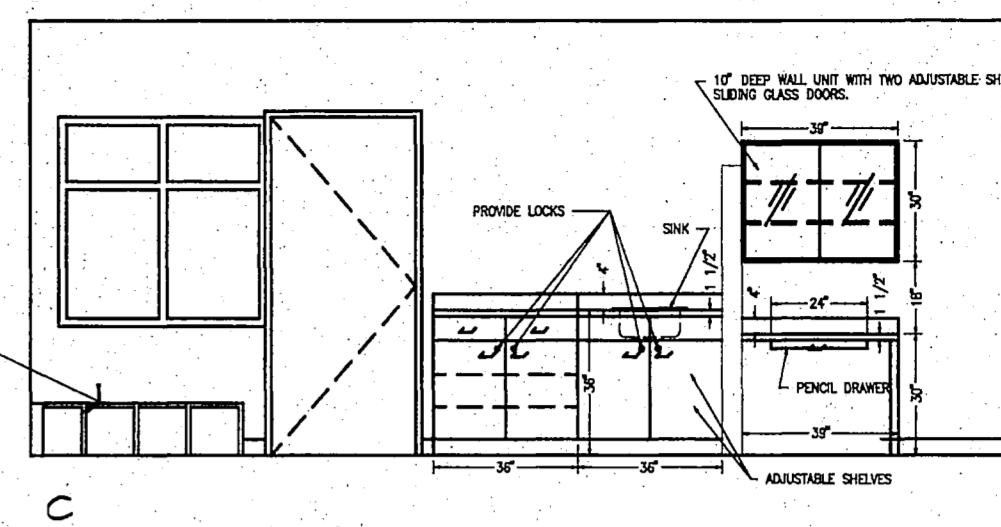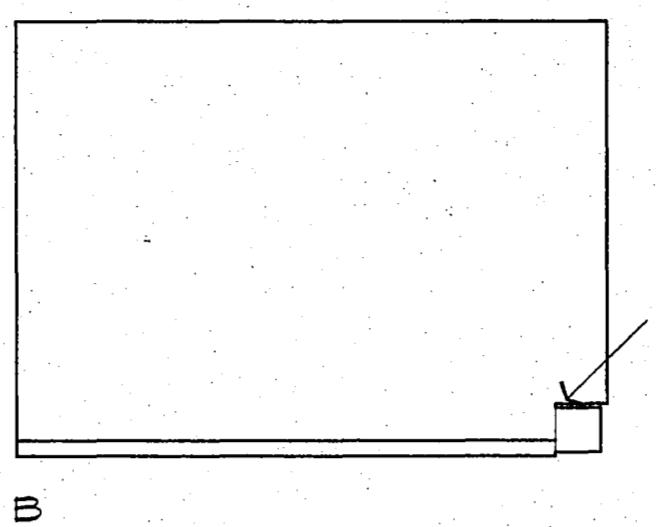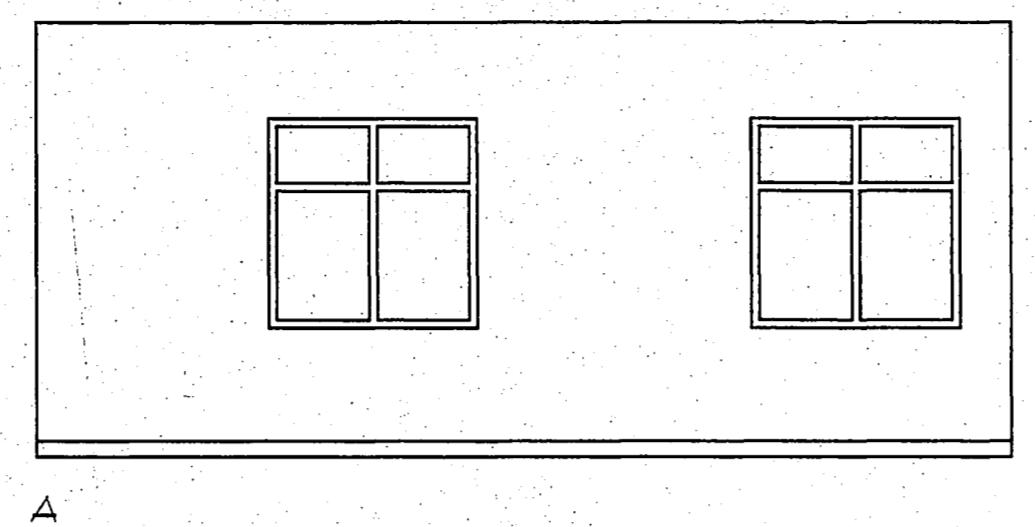





## ⑨ CHILD HEALTH SCREENING 139

SCALE: 1/4" = 1'-0"

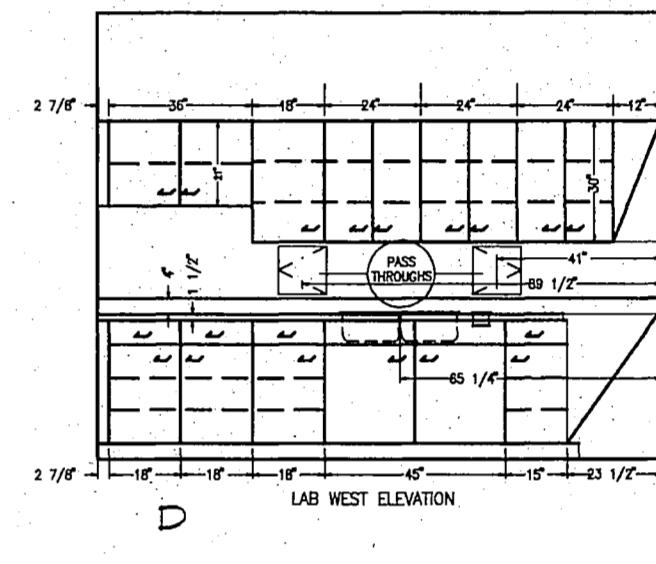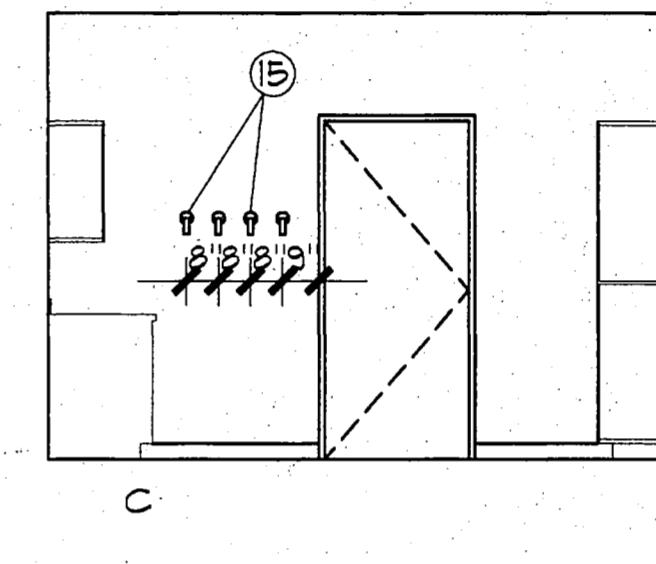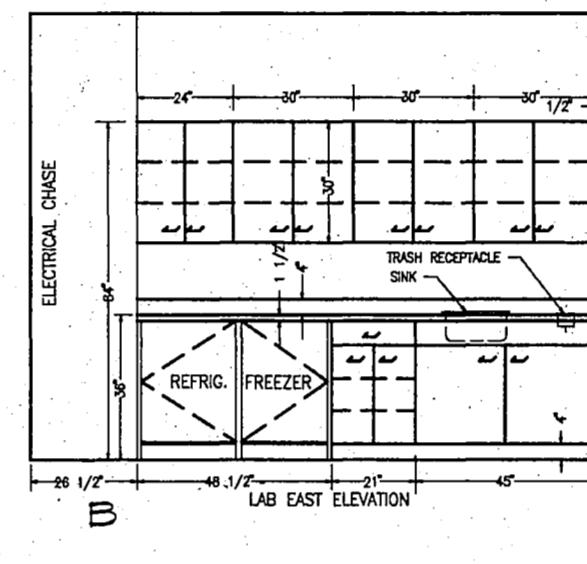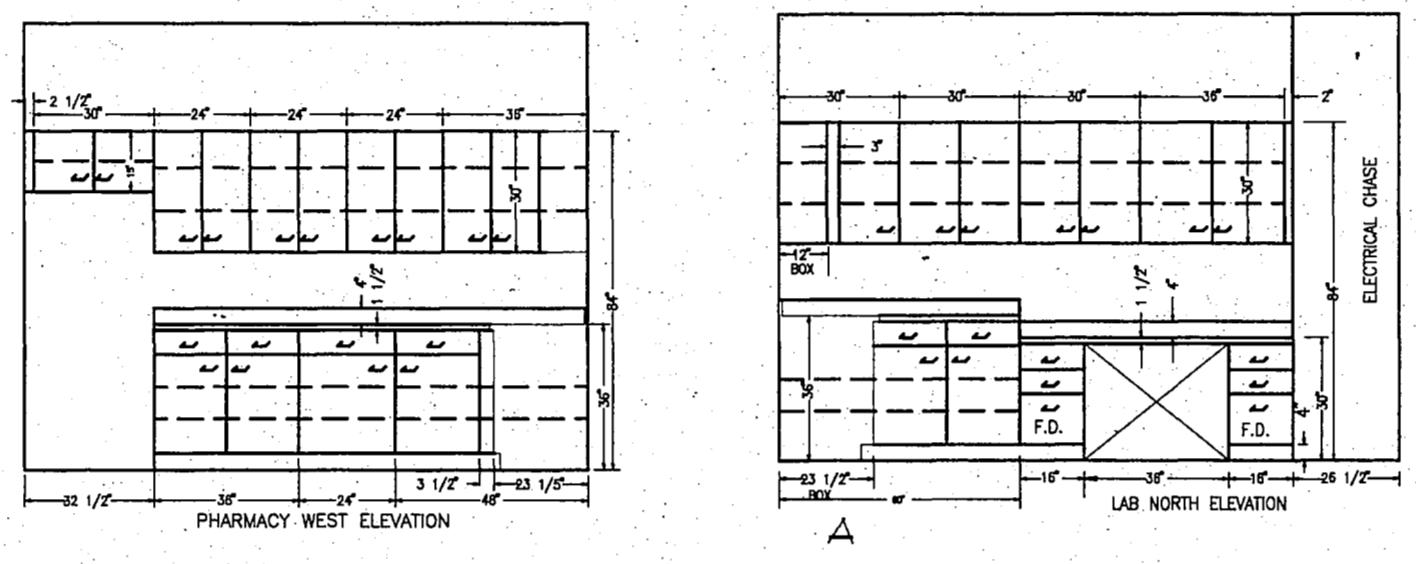






## ⑥ LABORATORY 128

SCALE: 1/4" = 1'-0"

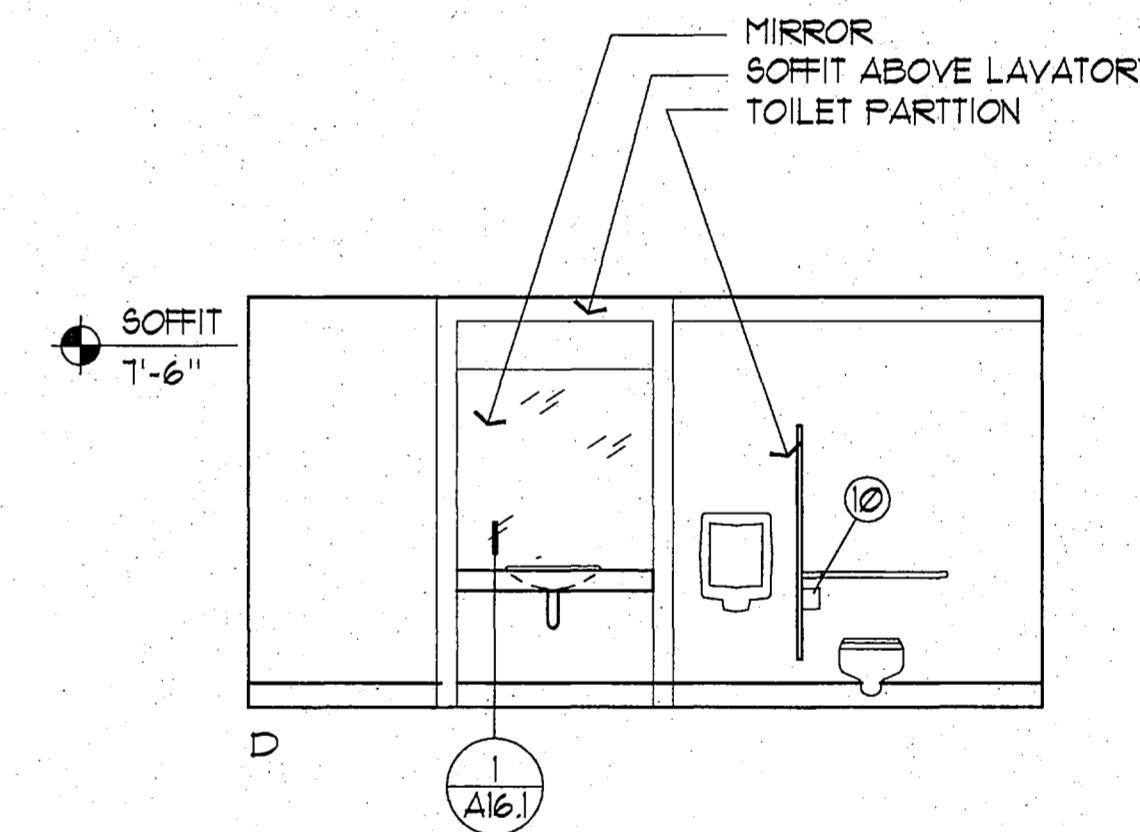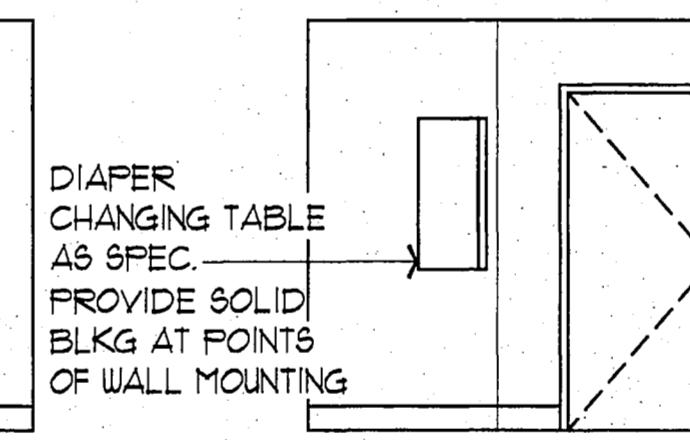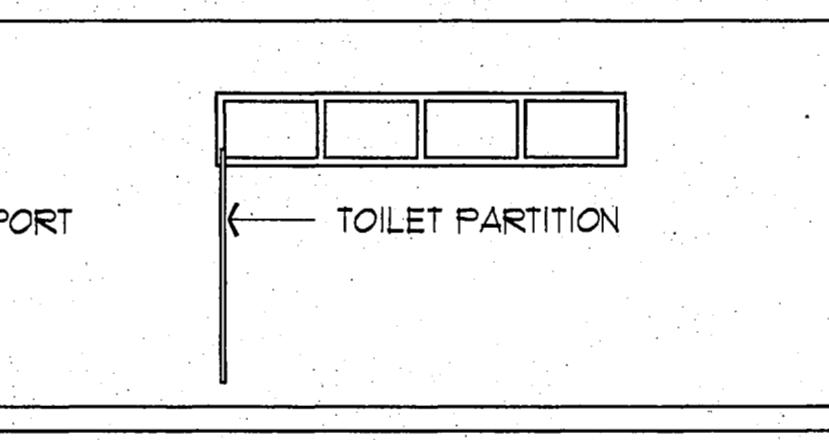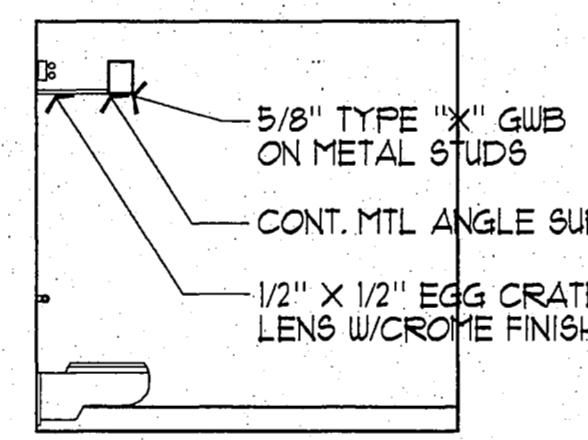

## ⑪ MEN'S RESTROOM 103 (WOMEN'S 104 SIM.)

SCALE: 1/4" = 1'-0"

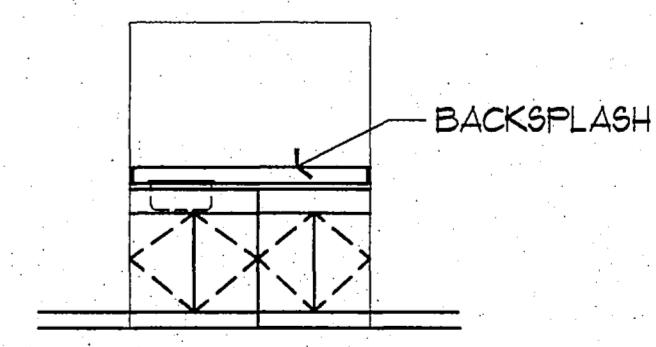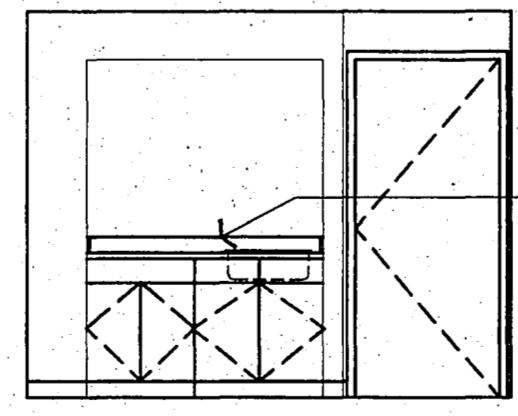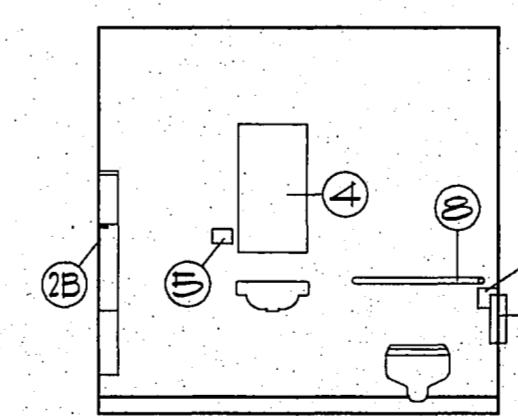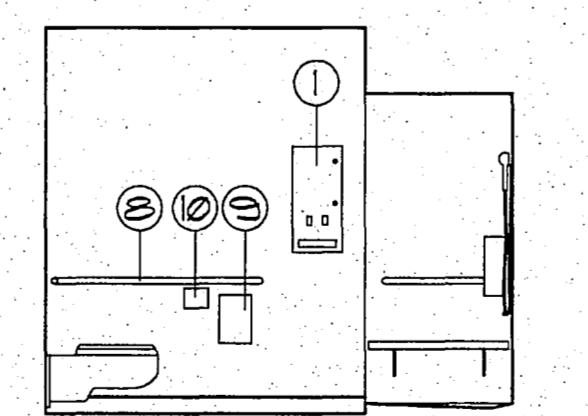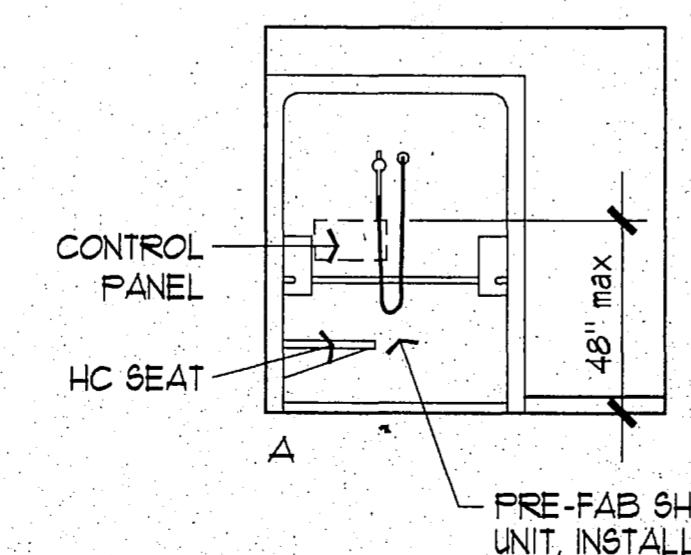

- NOTE:  
1. RE. 2/16.1 FOR CASEWORK DETAILS.

- NOTE:  
1. RE. 2/16.1 FOR CASEWORK DETAILS.

## ⑦ TOILET 6/SHOWER 207

SCALE: 1/4" = 1'-0"


## ④ COFFEE COUNTER AT CORR. 144

SCALE: 1/4" = 1'-0"

## ① COFFEE COUNTER AT CORR. 113

SCALE: 1/4" = 1'-0"

A9.1

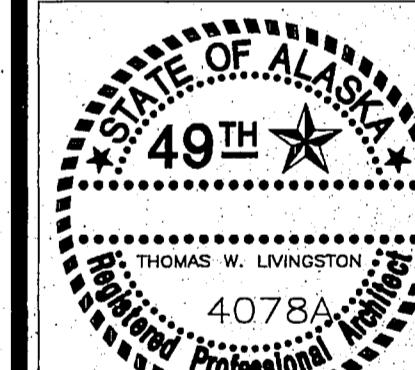

PROJECT NO. 115.00  
DRAWN BY ALS,JB  
CHECKED BY JB,JA  
DATE DEC 9, 1992  
REVISED

TITLE  
INTERIOR  
ELEVATIONS  
SHEET NO.

F3.071

CITY OF FAIRBANKS  
FAIRBANKS HEALTH CENTER


Fairbanks, Alaska

3900 Arctic Blvd. Suite 301  
Anchorage, Alaska 99503-5790  
(907) 562-2658


# RECORD DRAWING

*Rufus B. Branch*  
CITY ENGINEER, CITY OF FAIRBANKS

DATE 4/8/96

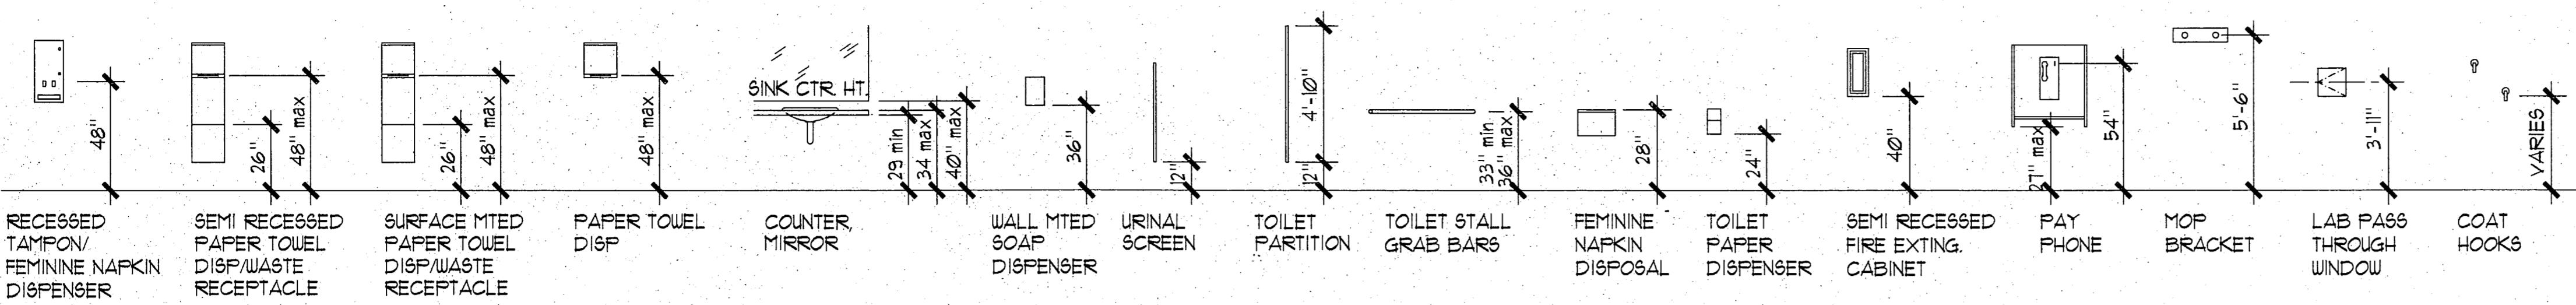


ACCESSORIES

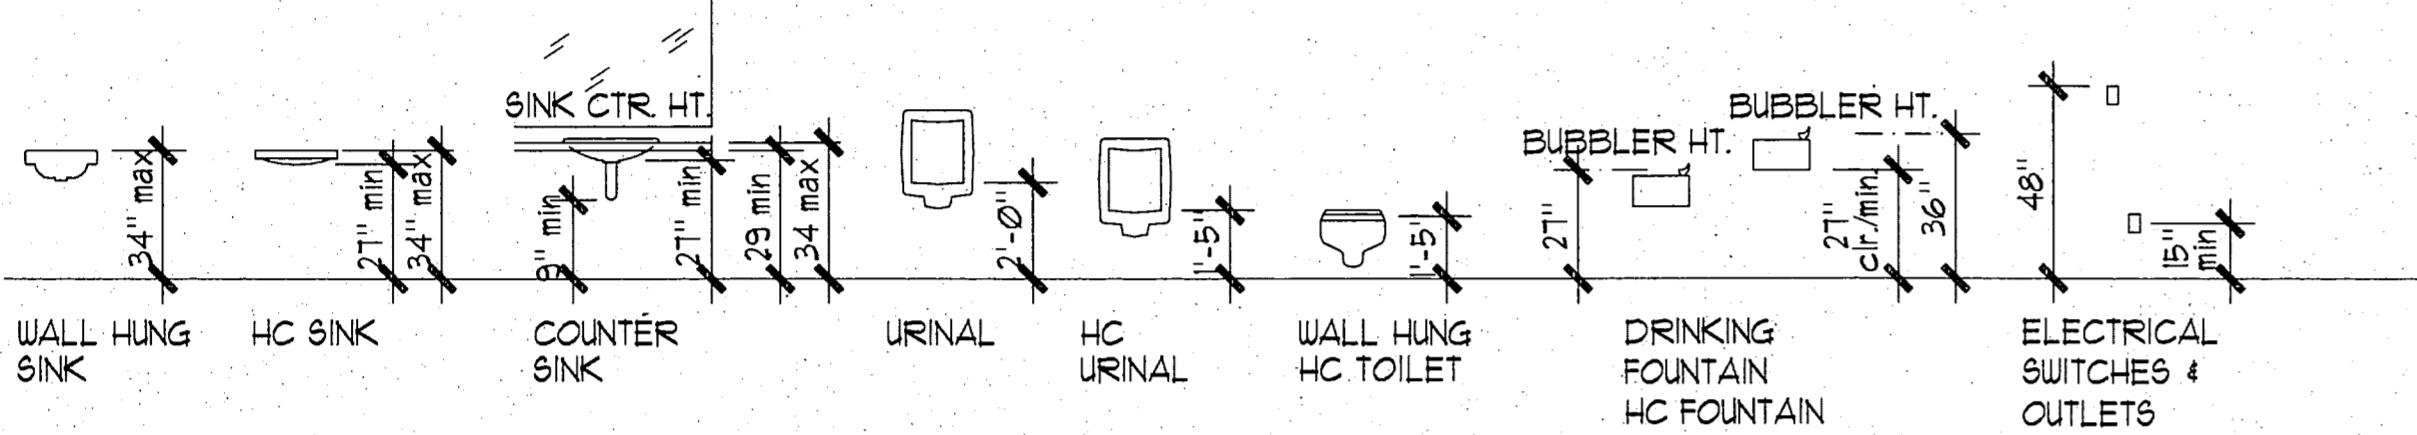

FIXTURES

MOUNTING HEIGHTS

SCALE: 1/4" = 1'-0"

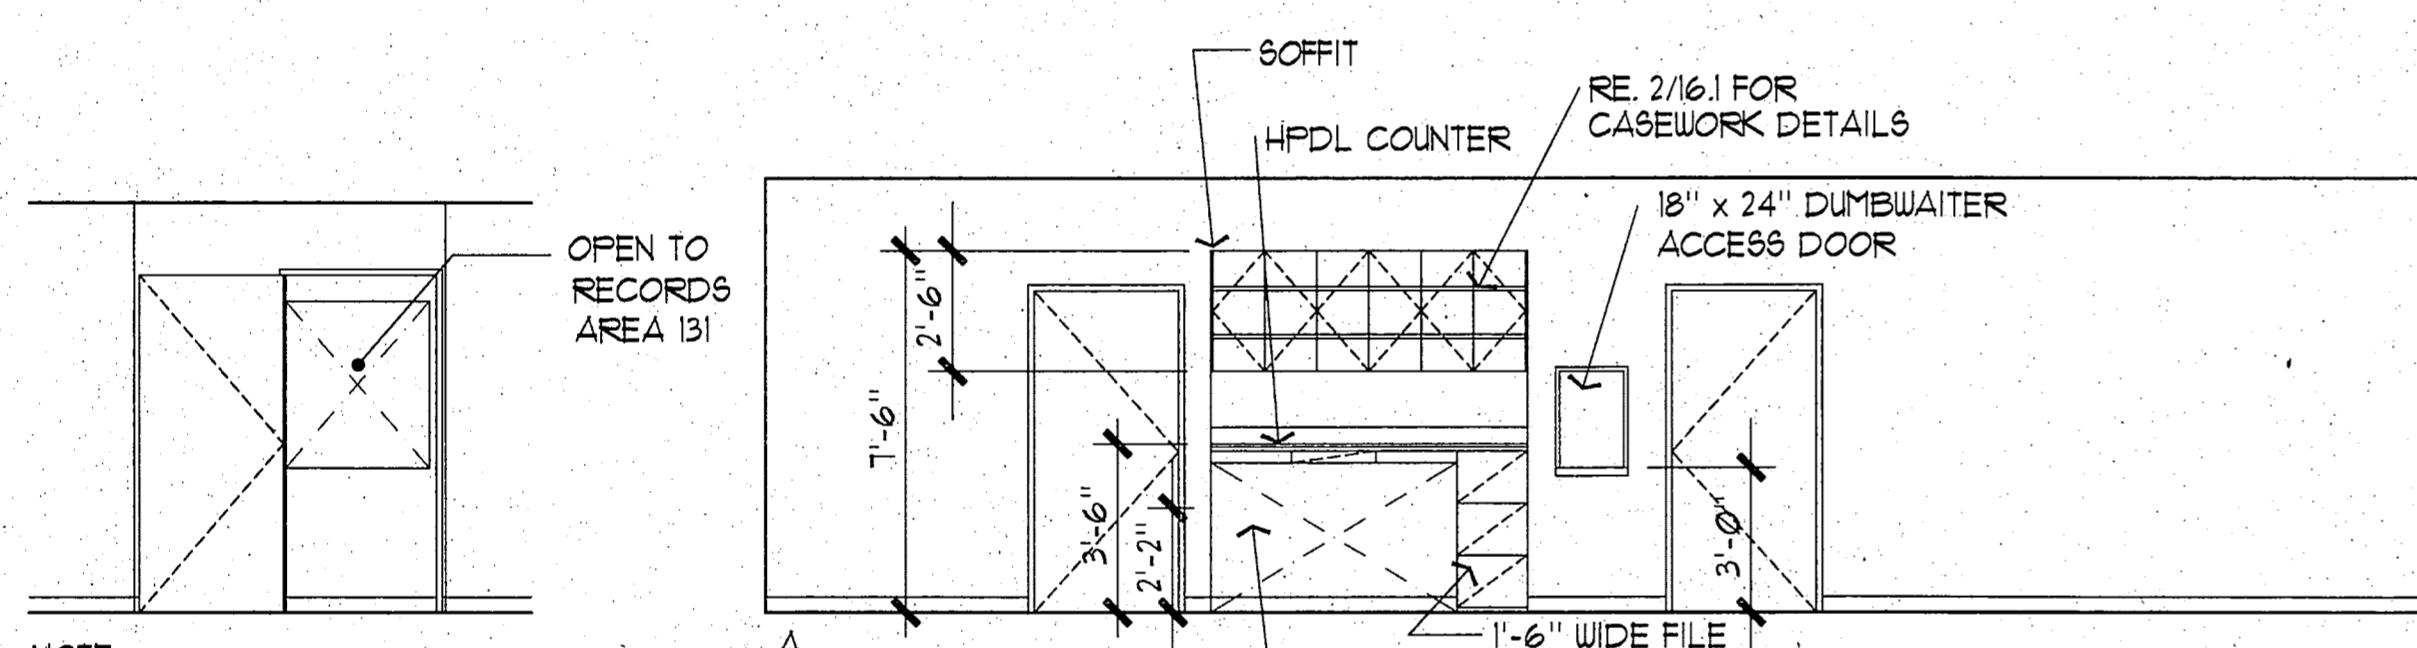


NOTE:  
1. SIMILAR ELEVATION IN CORRIDOR 110  
2. TEXTURE AND PAINT DOOR TO MATCH ADJACENT WALLS.

14 CORRIDOR 140

SCALE: 1/4" = 1'-0"


11 RECORDS AREA 131

SCALE: 1/4" = 1'-0"

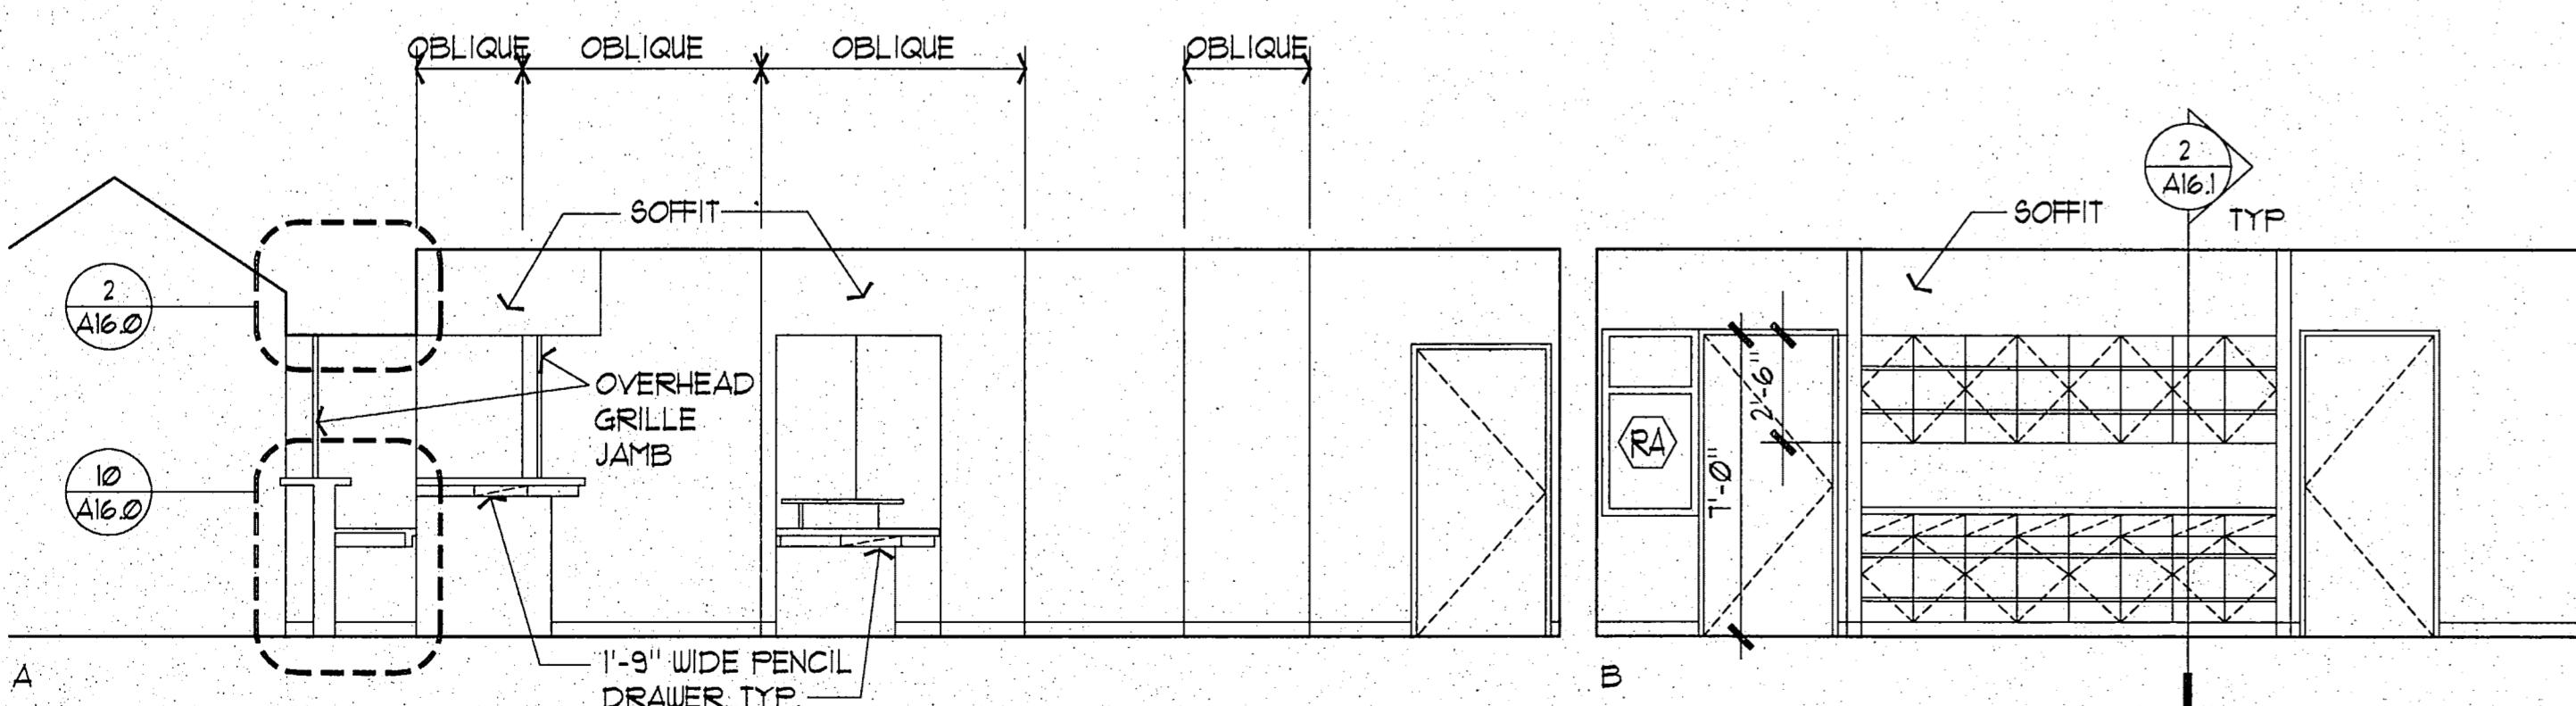


13 RECEPTION AREA 132

SCALE: 1/4" = 1'-0"

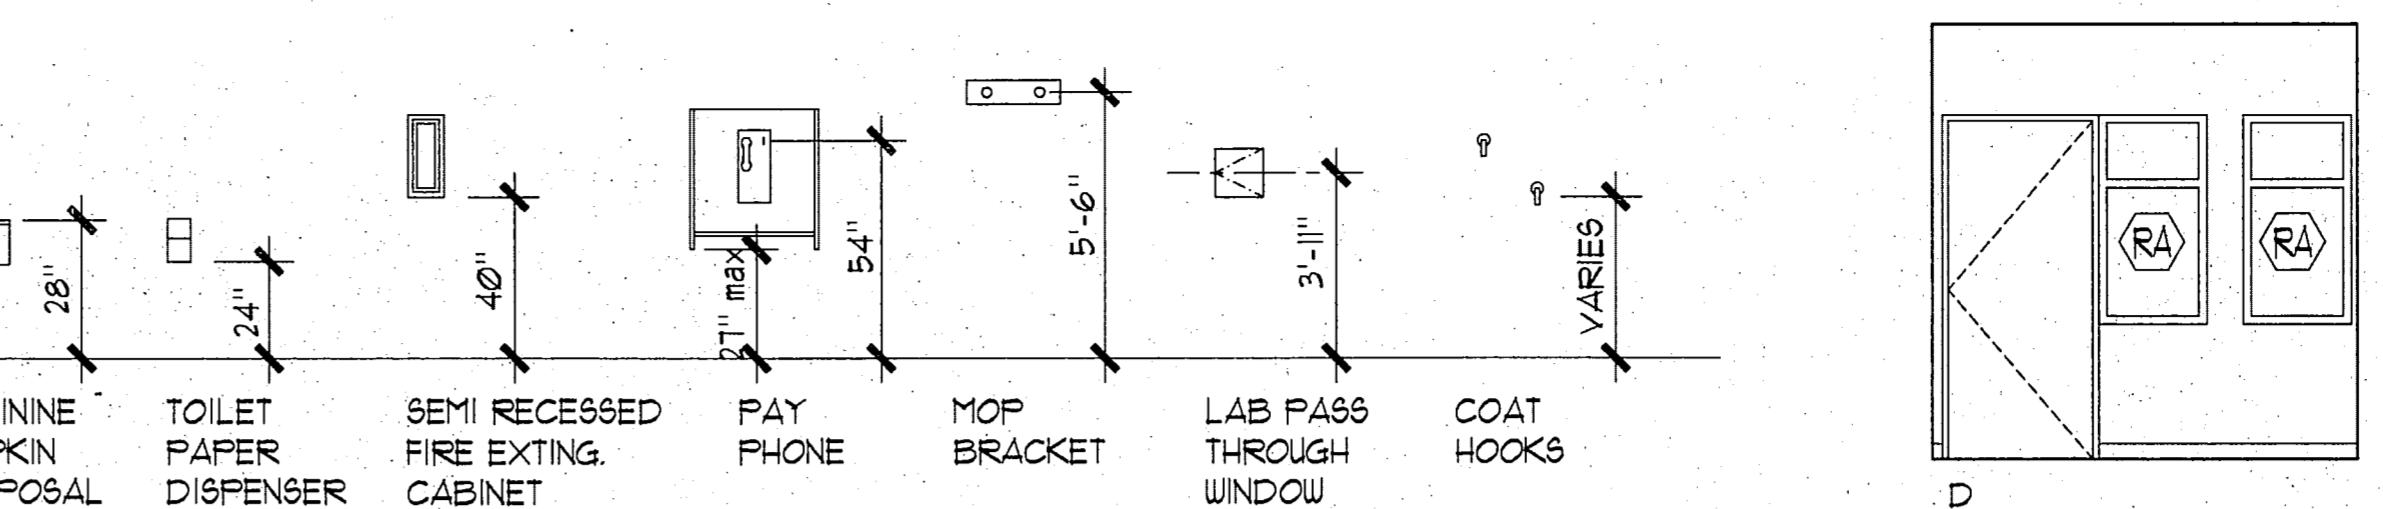

3 OFFICE 134



SCALE: 1/4" = 1'-0"

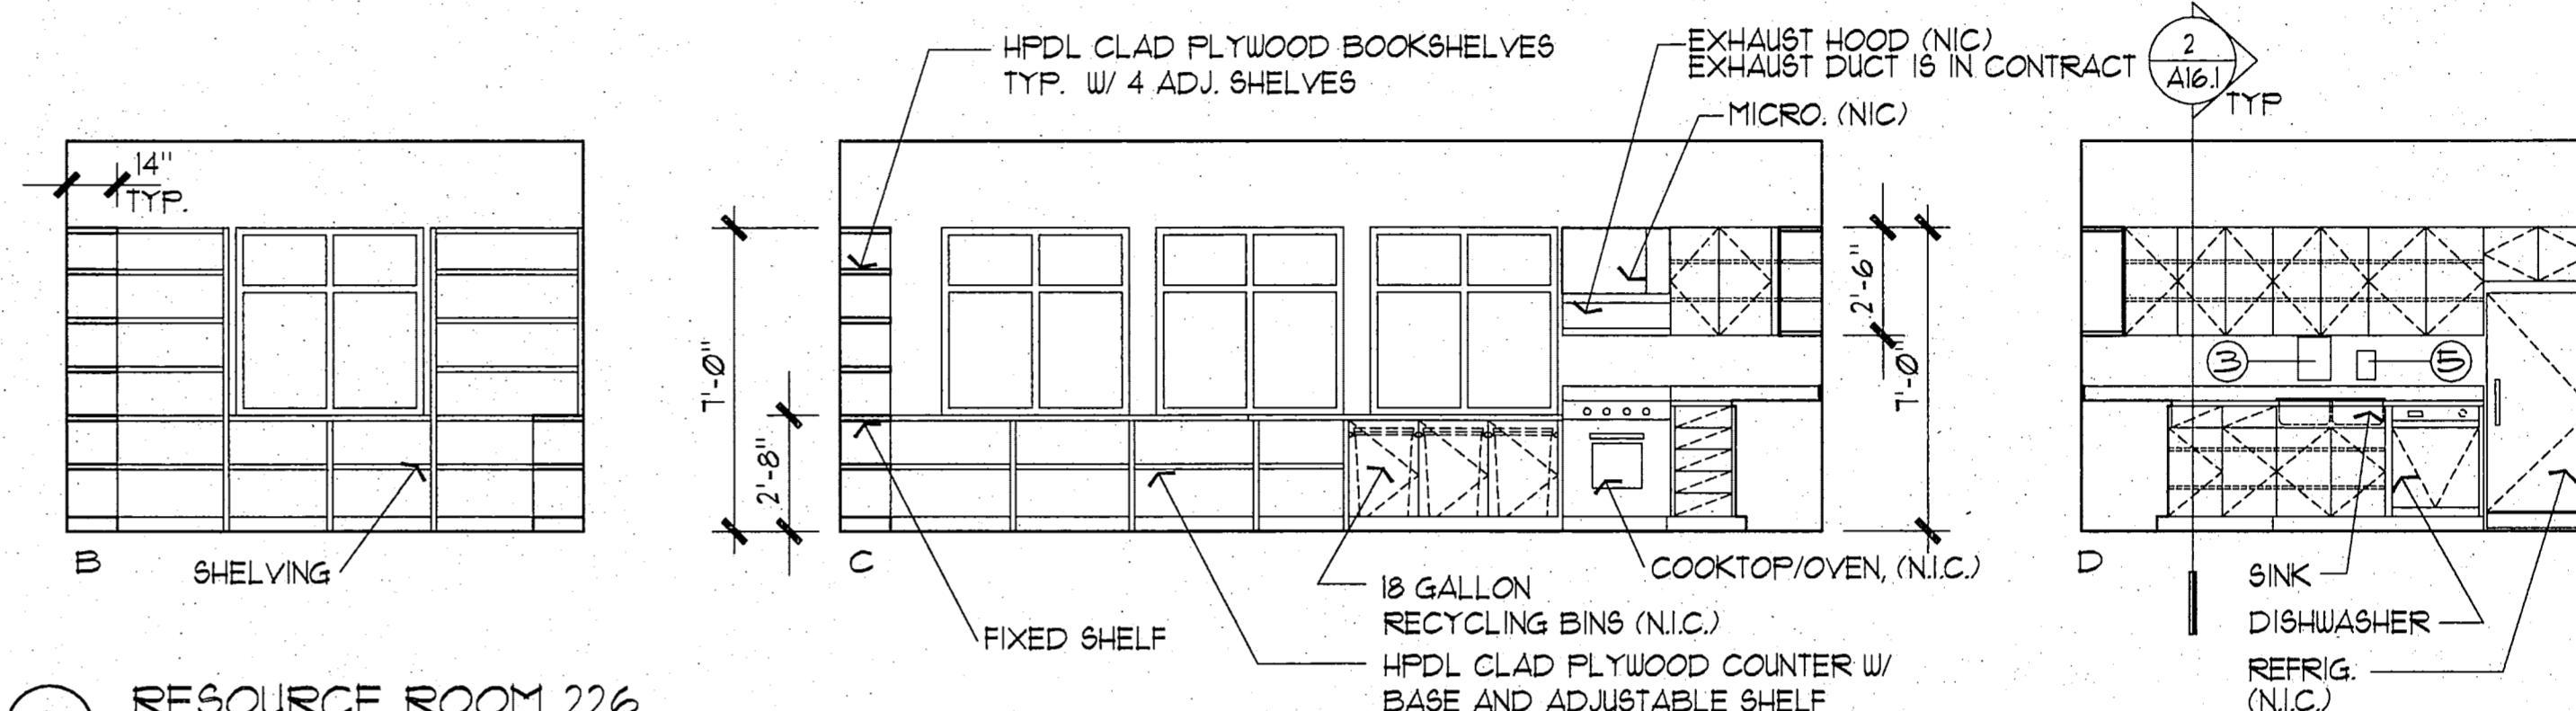

9 RESOURCE ROOM 226



SCALE: 1/4" = 1'-0"

NOTE:  
1. RE. 2/A16.1 FOR SIM. CASework DETAILS

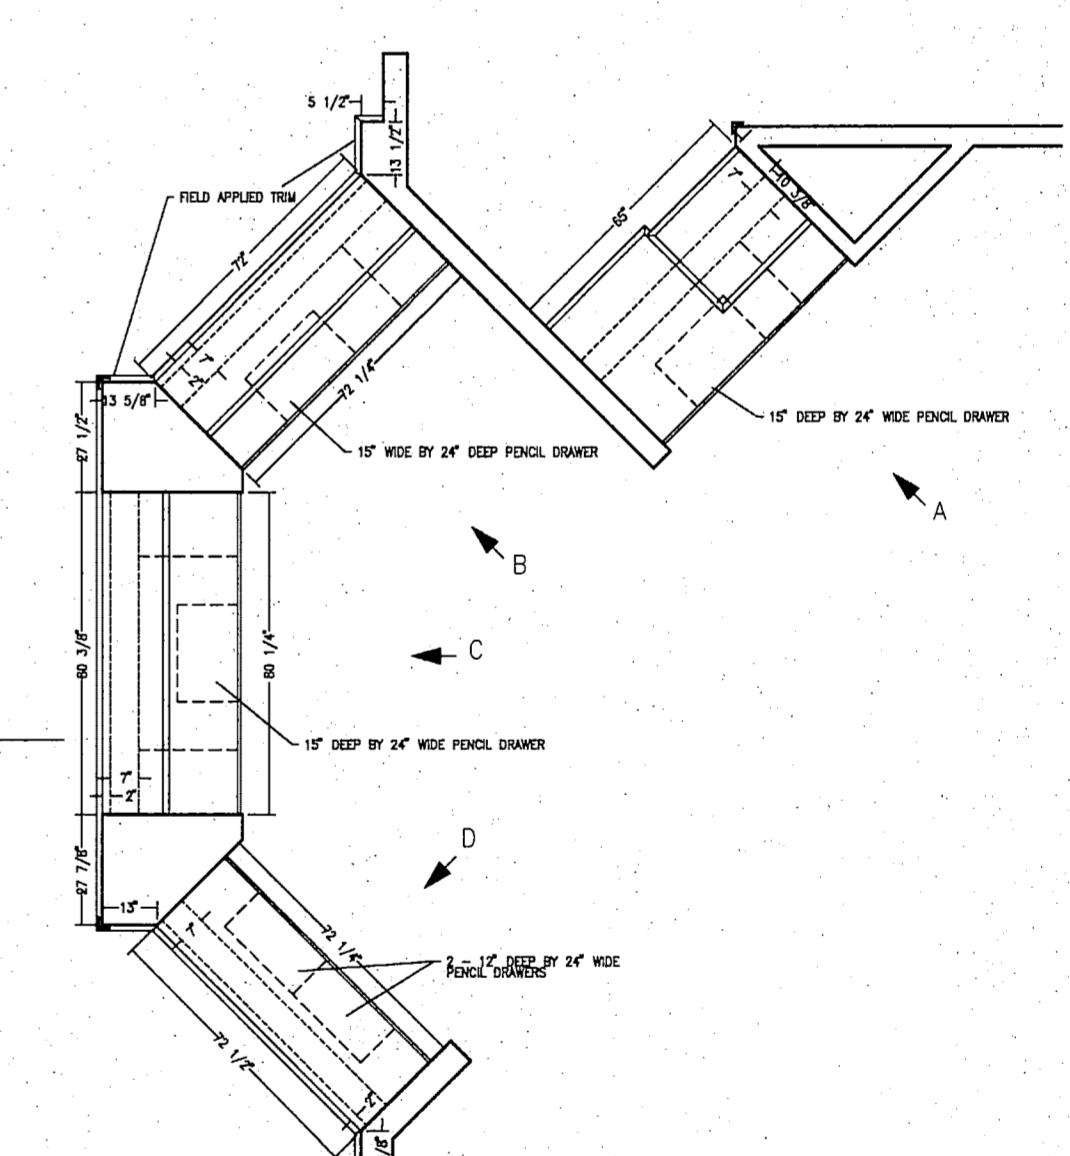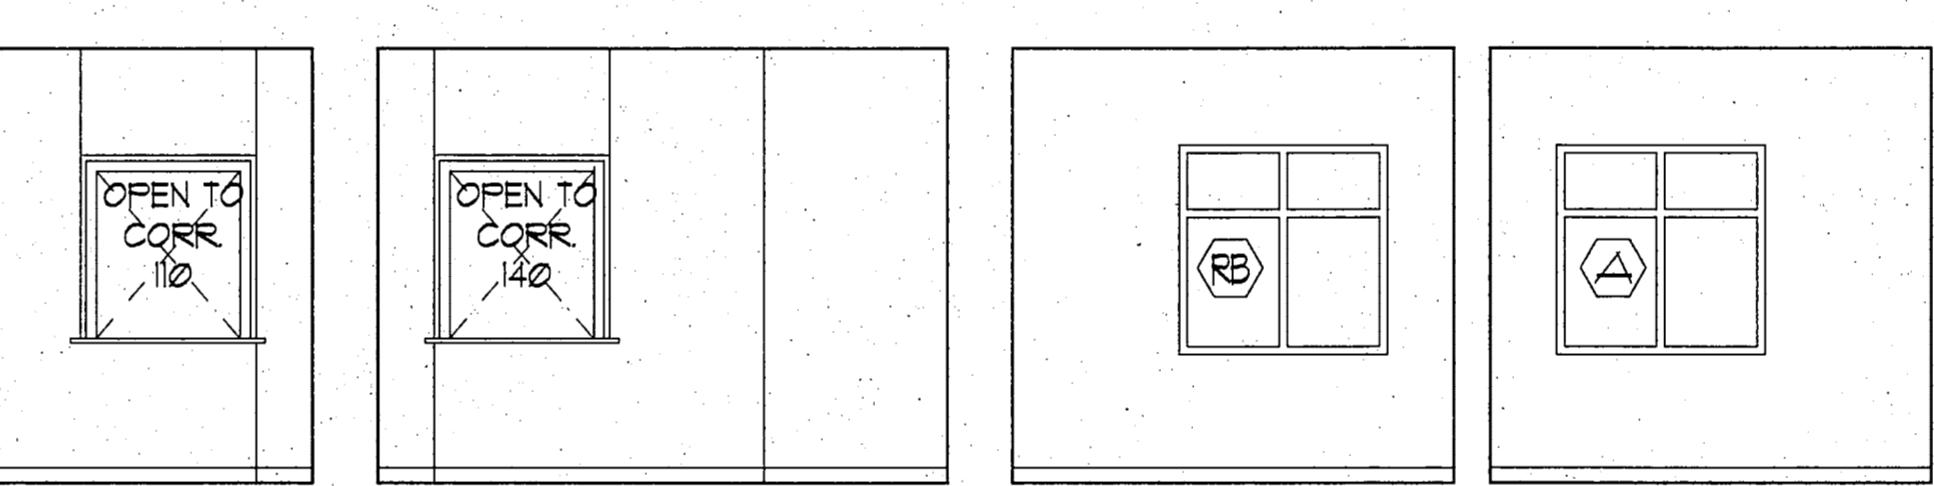

5 VESTIBULE 164


SCALE: 1/4" = 1'-0"

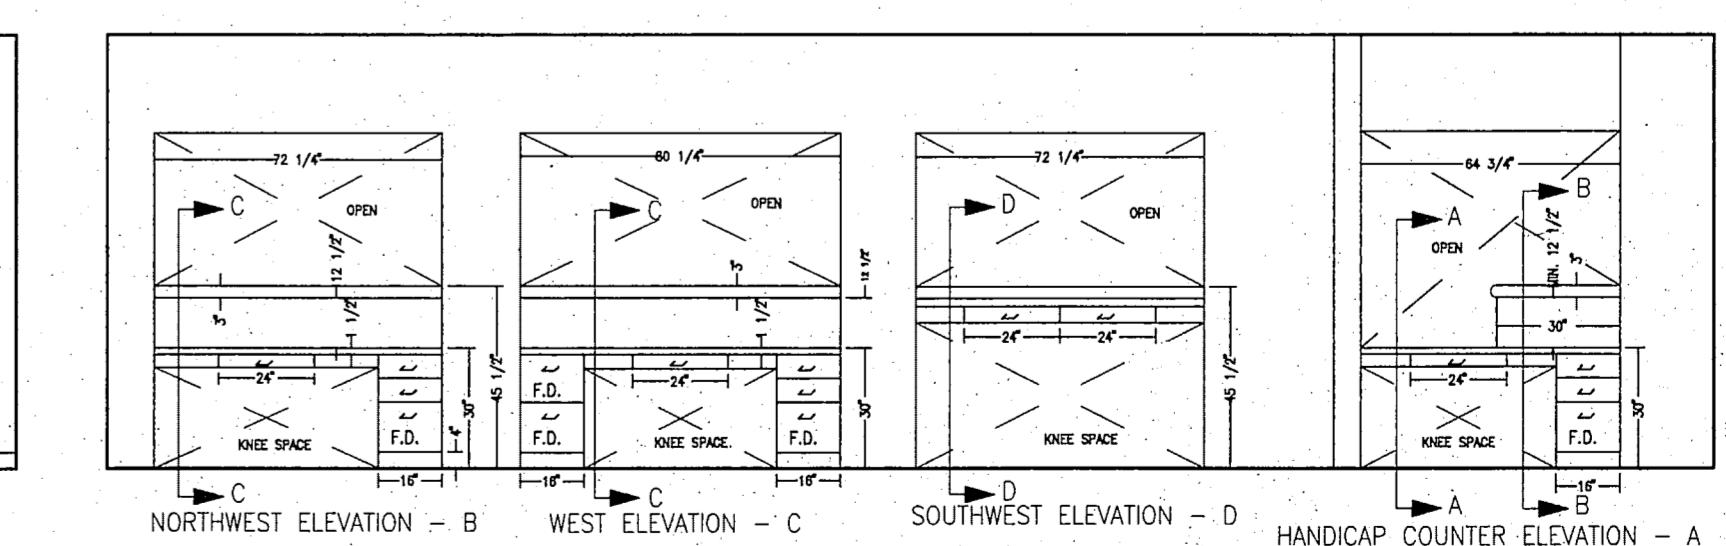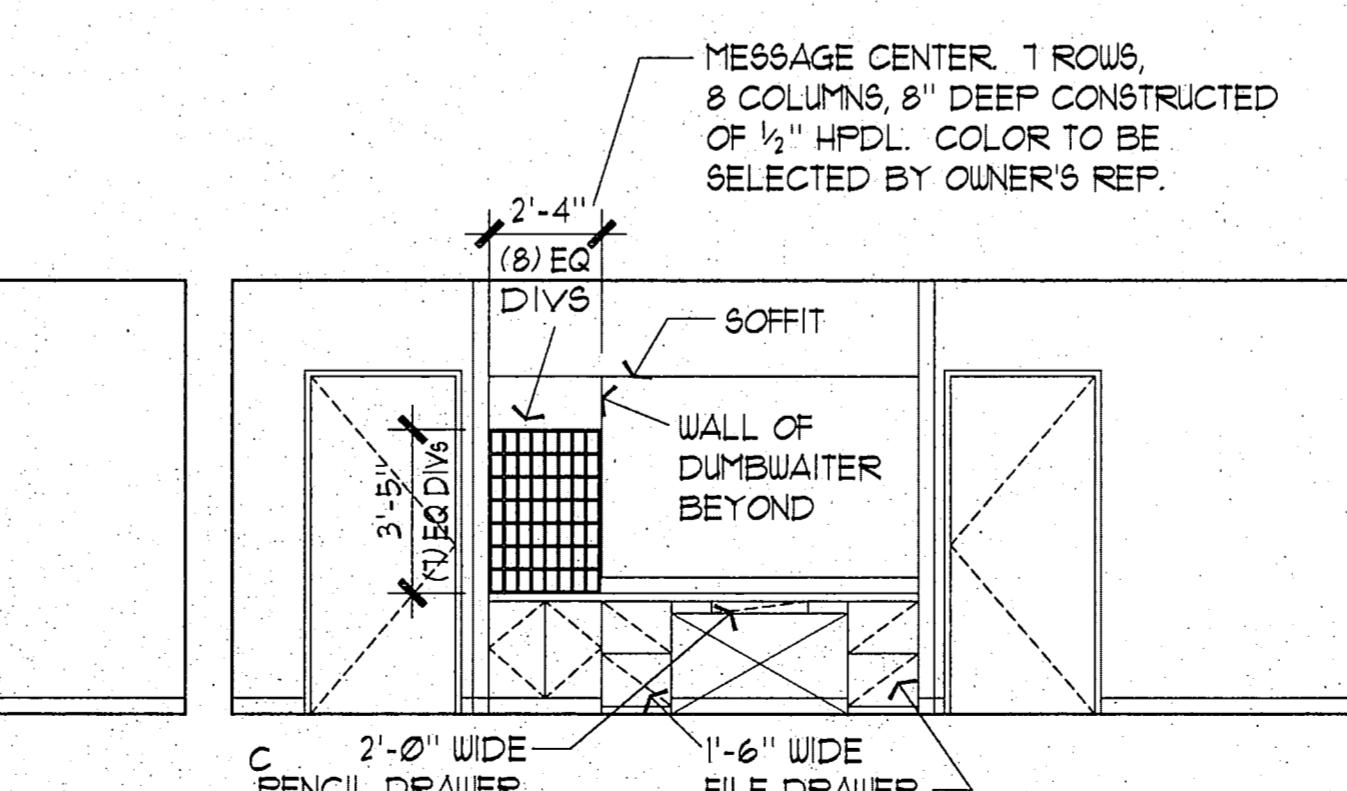

NOTE:  
1. RE. 2/A16.1 FOR SIM. CASework DETAILS

LIVINGSTON STONE Architecture Engineering Interior Design Planning Incorporated

3900 Arctic Blvd. Suite 301  
Anchorage, Alaska 99503-5790  
(907) 563-2056

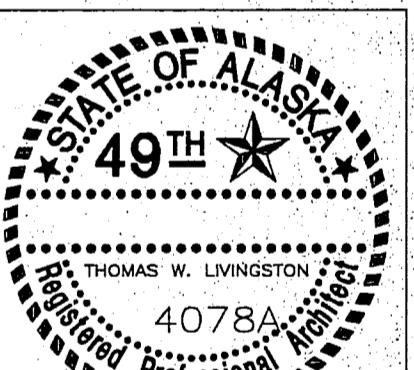

PROJECT NO. 115.00

DRAWN BY ALSJB

CHECKED BY JBJA

DATE DEC 9, 1992

REVISED

TITLE  
INTERIOR ELEVATIONS

SHEET NO.

A9.2

CITY OF FAIRBANKS  
FAIRBANKS HEALTH CENTER

Fairbanks, Alaska

LIVINGSTON STONE

Architecture Engineering

Interior Design Planning

Incorporated

3900 Arctic Blvd. Suite 301

Anchorage, Alaska 99503-5790

(907) 562-2055



PROJECT NO. 115.00

DRAWN BY AS, OM.

CHECKED BY JB, JA

DATE DEC 9, 1992

REVISED

TITLE

FIRST  
LEVEL  
RCP

SHEET NO.

A10.0


F3.0.069

NOTES:

- RE. ROOM FINISH SCHEDULE A15.3 FOR FURTHER CEILING HEIGHT INFORMATION.
- CORRIDOR CEILING HEIGHT = 8'-4" U.O.N.
- RE. ELECTRICAL AND MECHANICAL FOR MORE COORDINATION INFORMATION.

KEY:

- DOWNLIGHT
  - DIFFUSER (LARGE)
  - DIFFUSER (SMALL)
  - ||| RADIANT PANEL
  - 2'-0" x 4'-0" LIGHT FIXTURE
  - 2'-0" x 2'-0" LIGHT FIXTURE
  - EMERGENCY LIGHTING
- RE. MECHANICAL, ELECTRICAL AND PLUMBING DRAWINGS FOR FURTHER INFO.

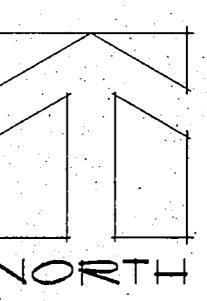


**RECORD  
DRAWING**

*Rufus B. Beach*  
CITY ENGINEER, CITY OF FAIRBANKS

4/8/96

1 FIRST LEVEL REFLECTED CEILING PLAN

SCALE: 1/8" = 1'-0"

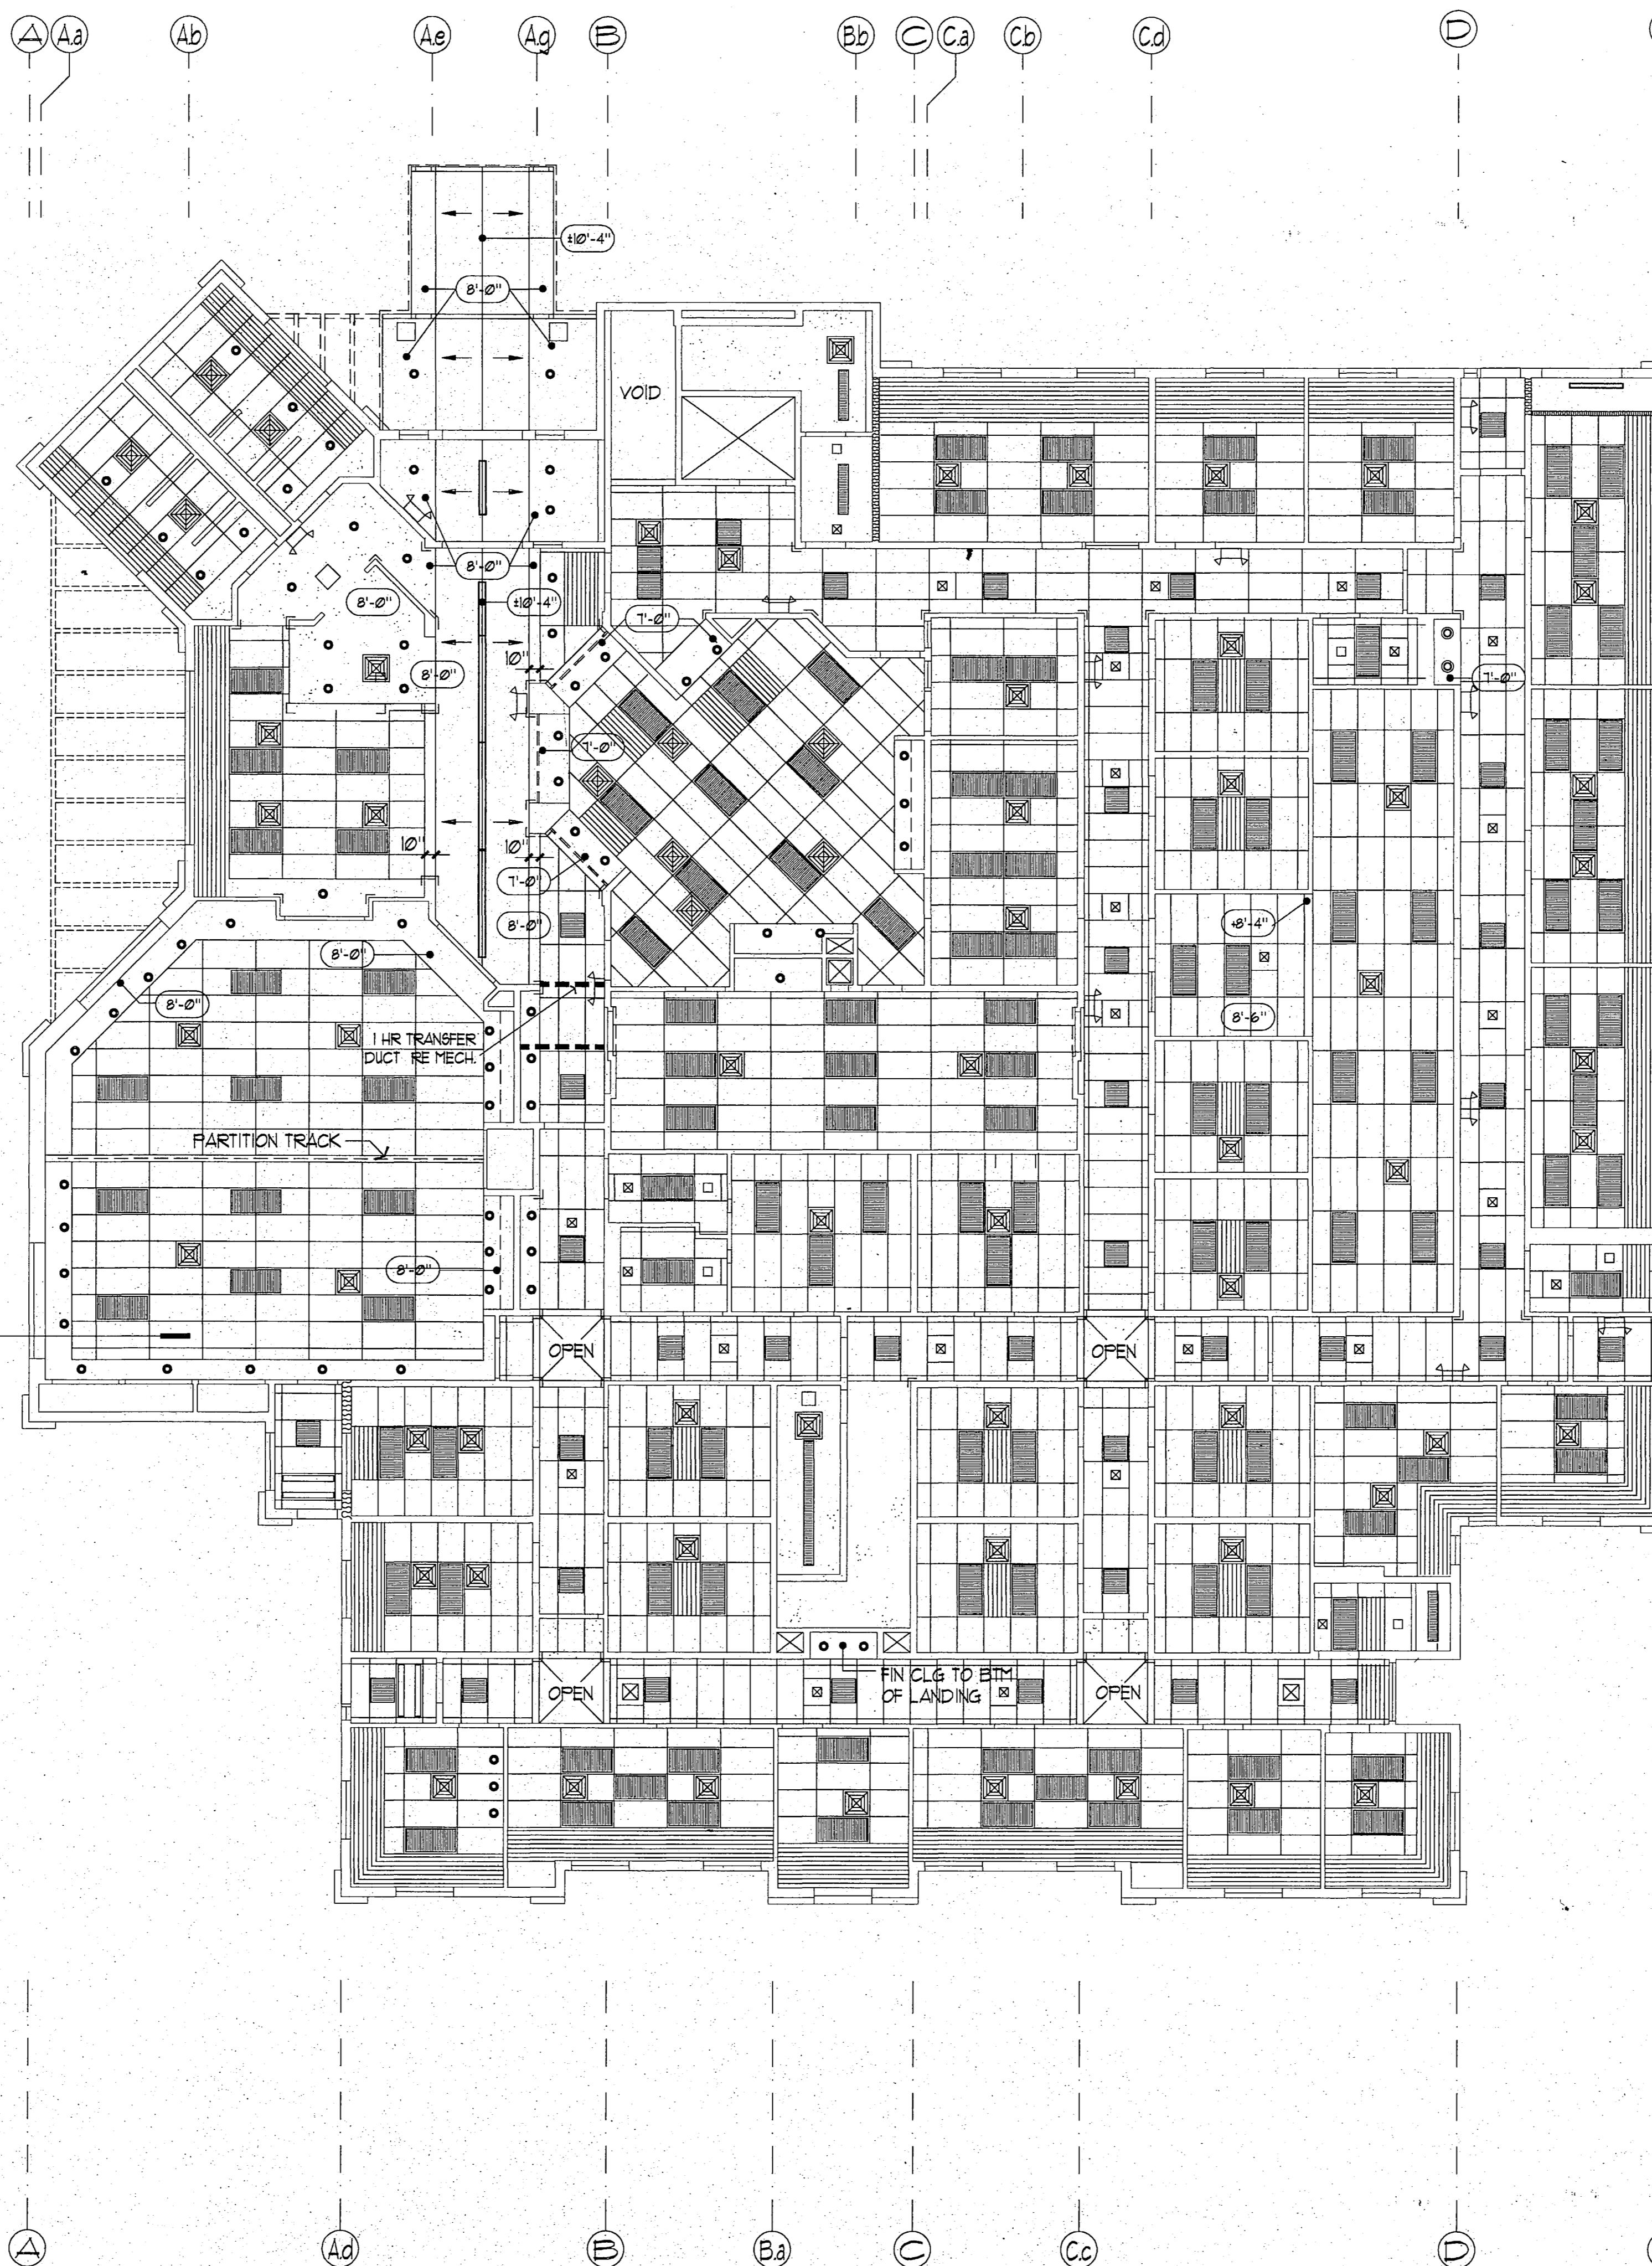

City of Fairbanks

# FAIRBANKS HEALTH CENTER

Fairbanks, Alaska

**LIVINGSTON**  
**STONE**

Incorporated  
Architecture Engineering  
Interior Design Planning

3900 Arctic Blvd, Suite 301  
Anchorage, Alaska 99503-5790

(907) 352-2058



PROJECT NO. 115.00  
DRAWN BY AS, OM  
CHECKED BY JB, JA  
DATE DEC 9, 1992  
REVISED

TITLE  
**SECOND  
LEVEL  
RCP**  
SHEET NO.

**A10.1**




# RECORD DRAWING

*Rufus B. Bush*  
CITY ENGINEER, CITY OF FAIRBANKS

9/8/96

DATE

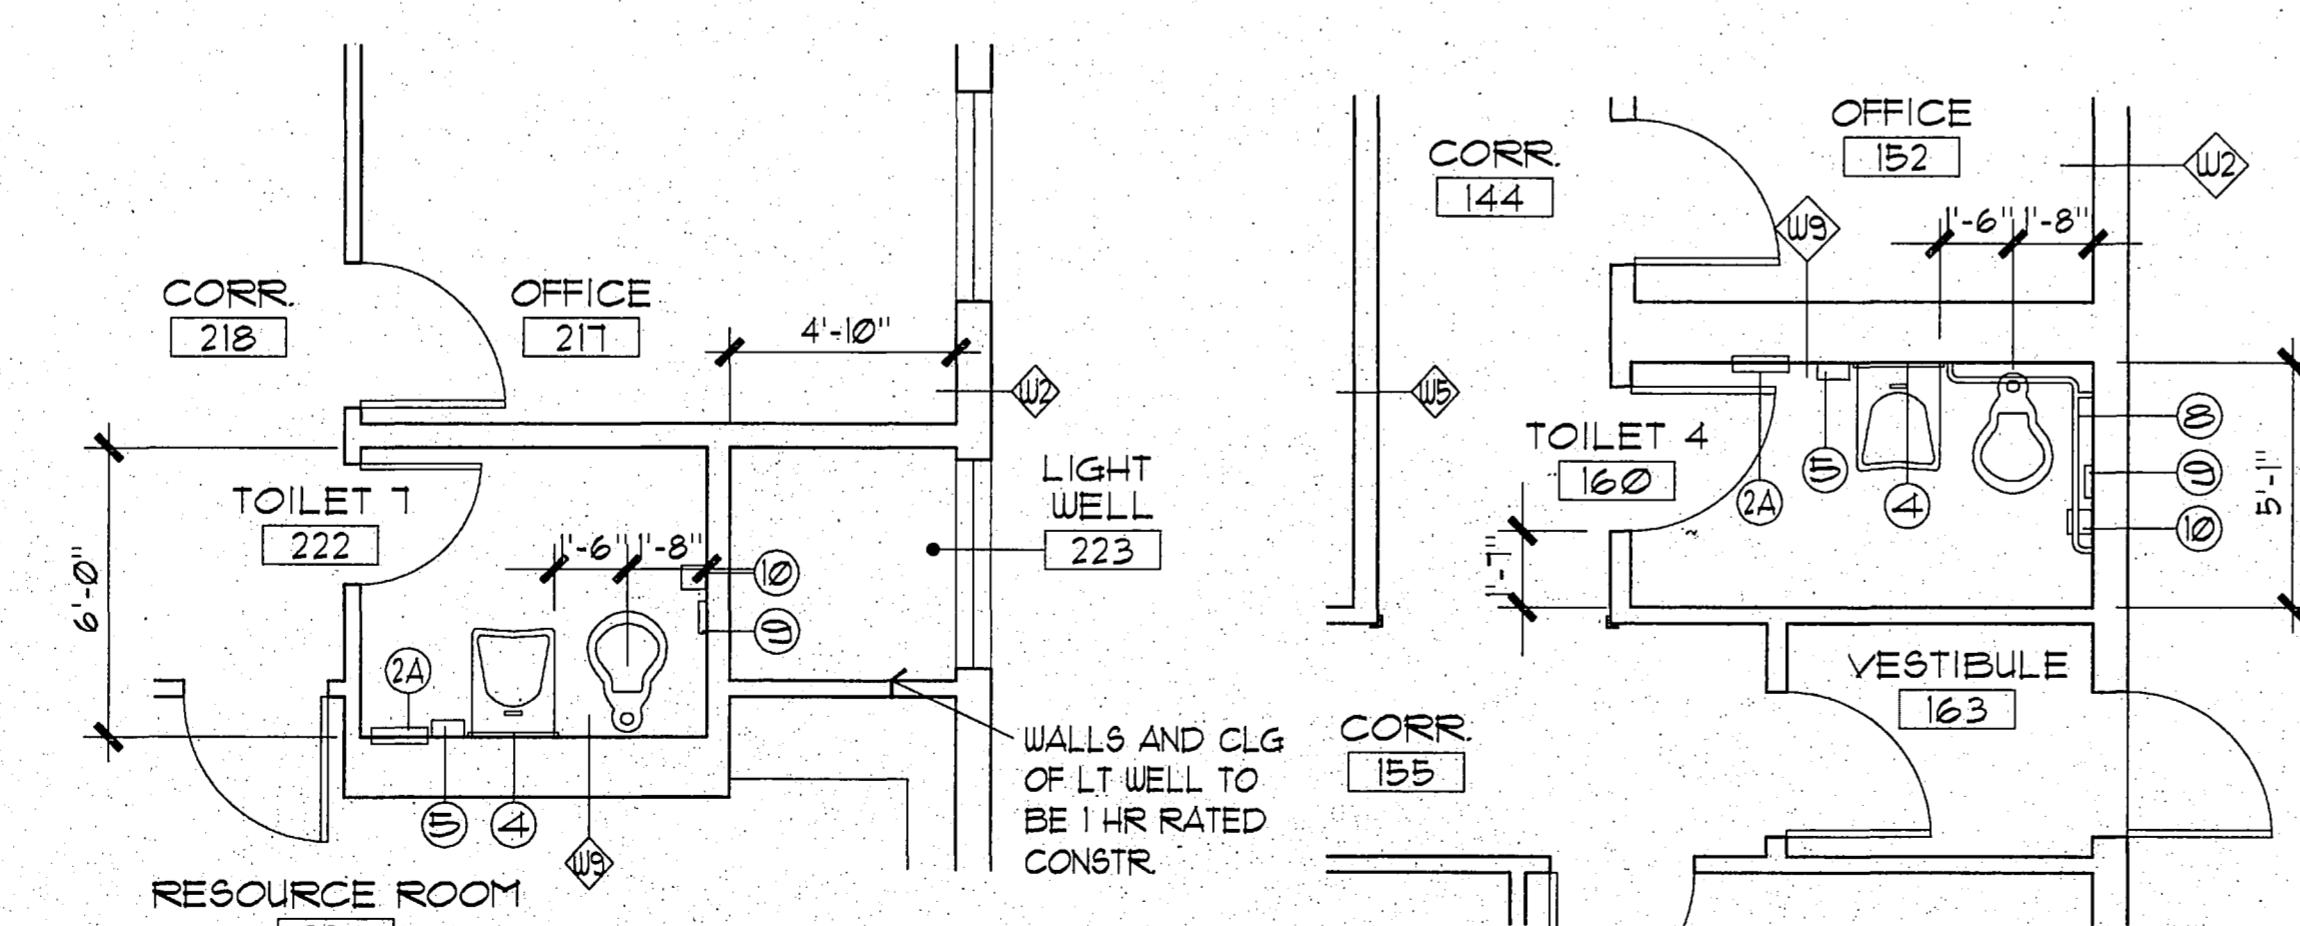




TOILET 1 222  
SCALE: 1/4" = 1'-0"

TOILET 4 160  
SCALE: 1/4" = 1'-0"

MEN'S TOILET 103/WOMEN'S TOILET 104  
SCALE: 1/4" = 1'-0"

RECEPTION AREA 132  
SCALE: 1/4" = 1'-0"

NOTE: RE. 13/A92 FOR MORE DETAIL INFO.

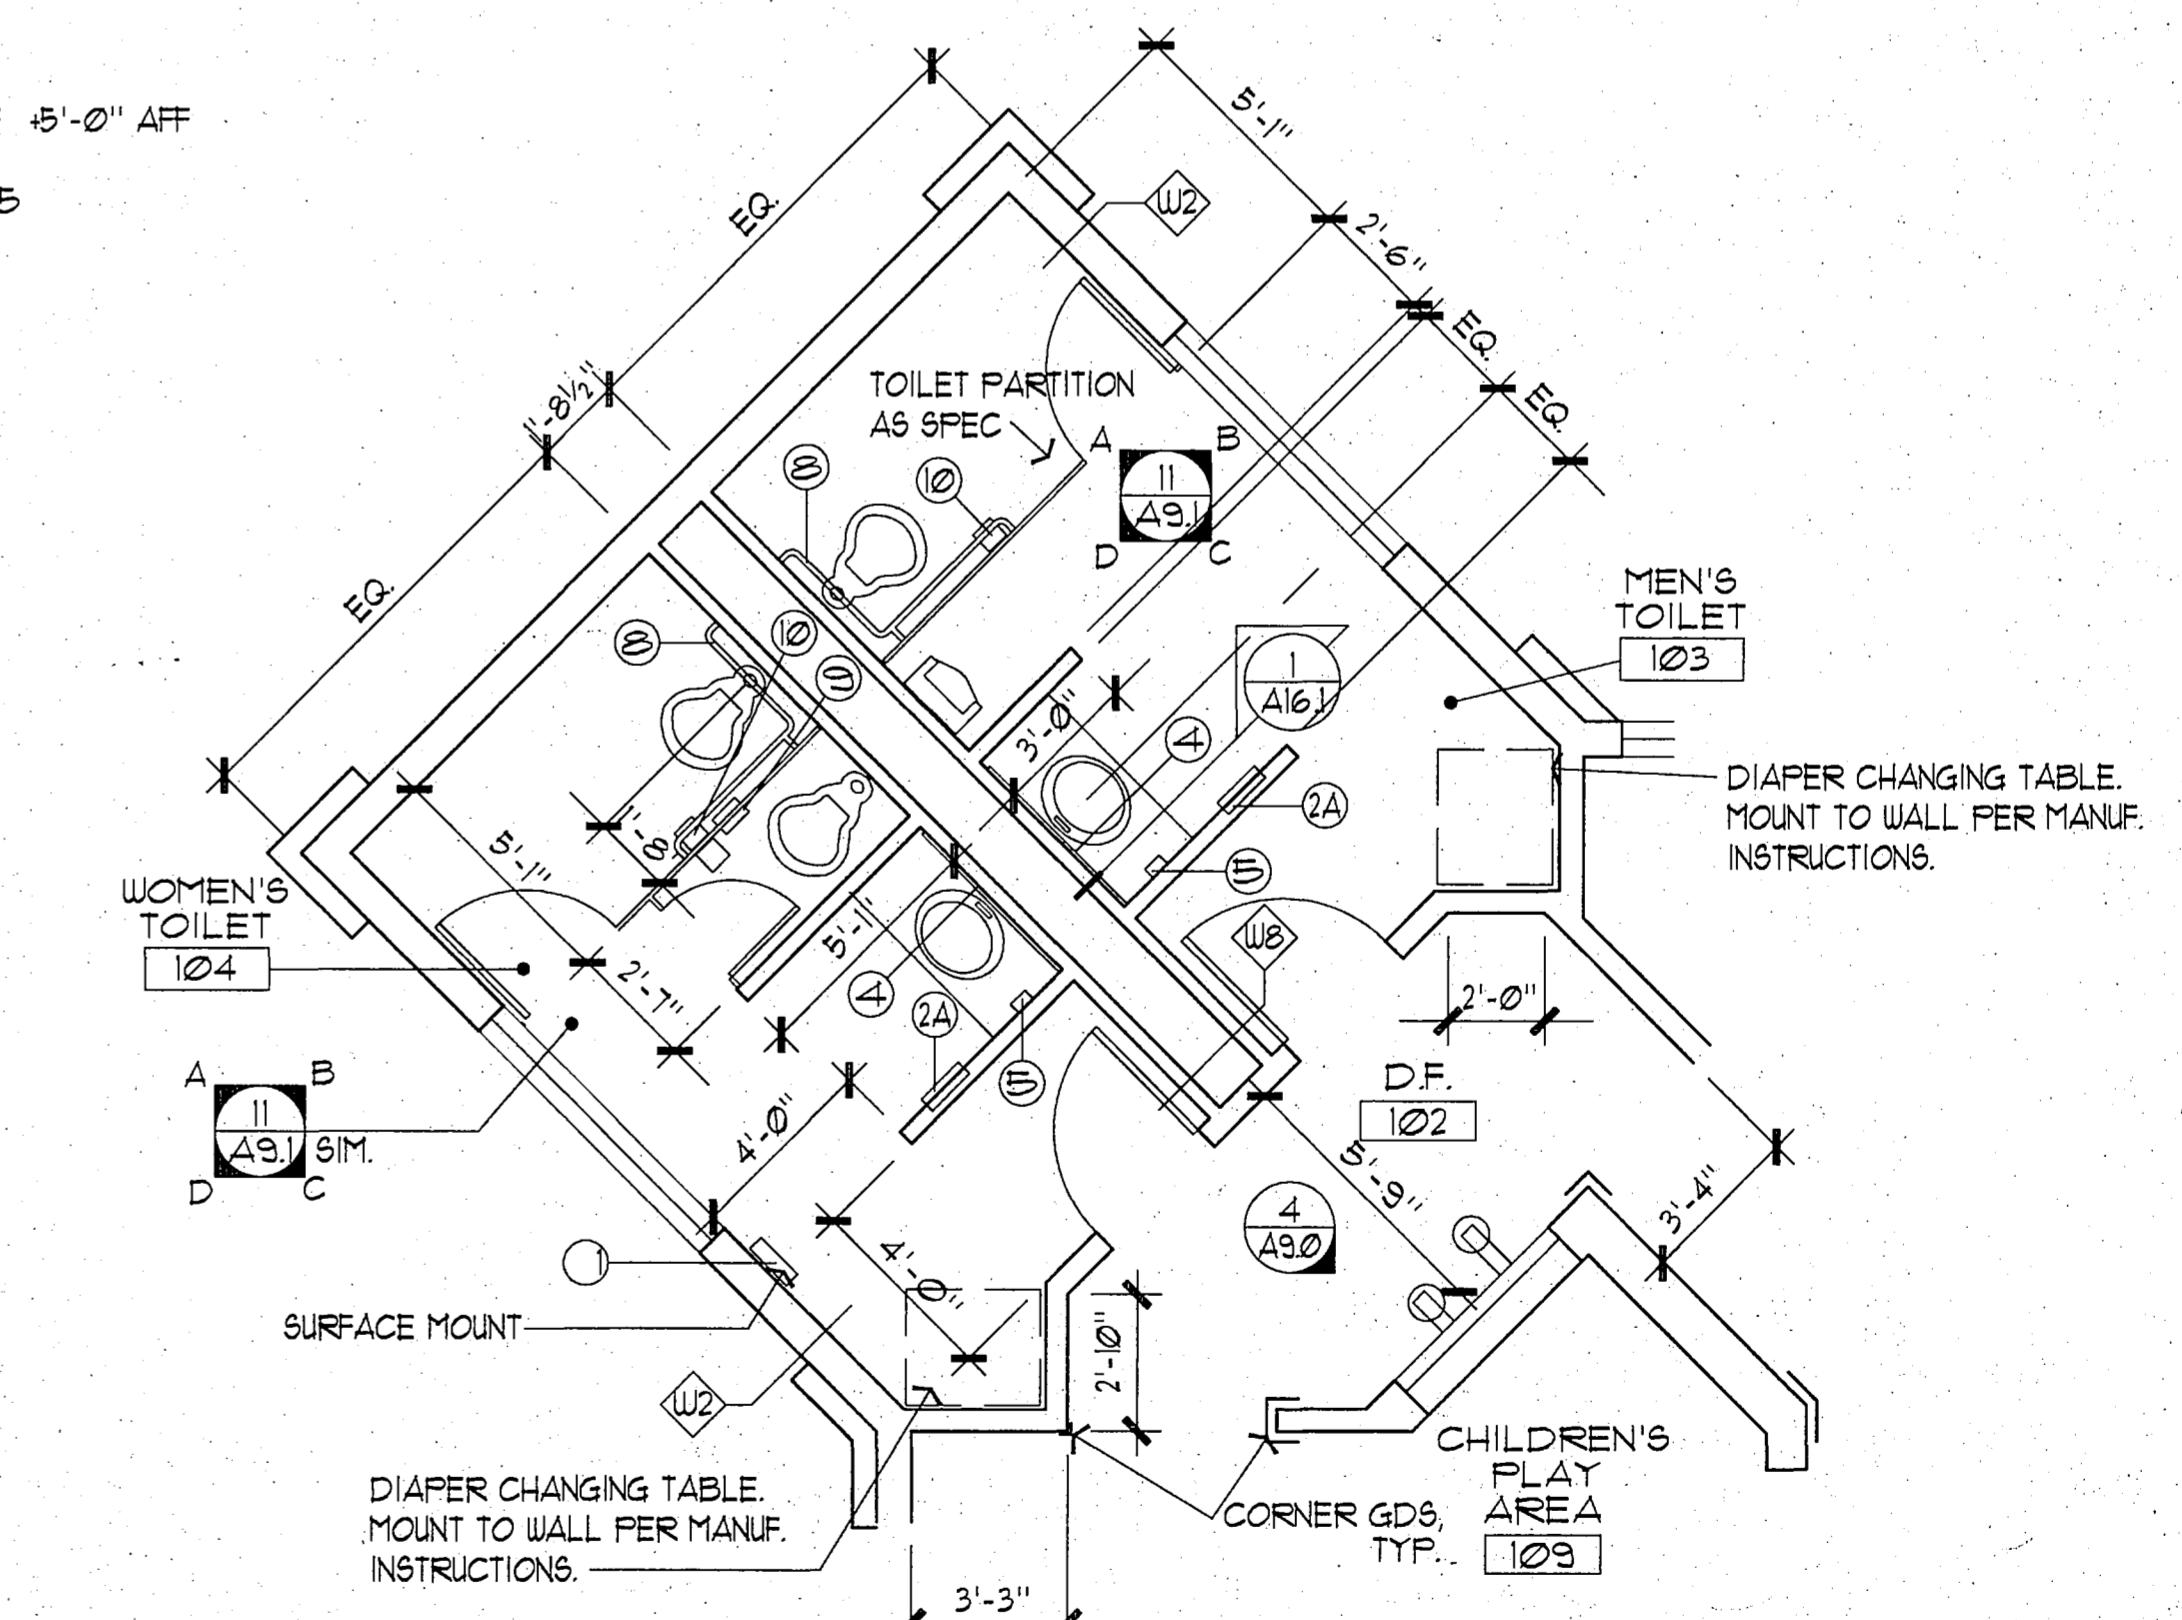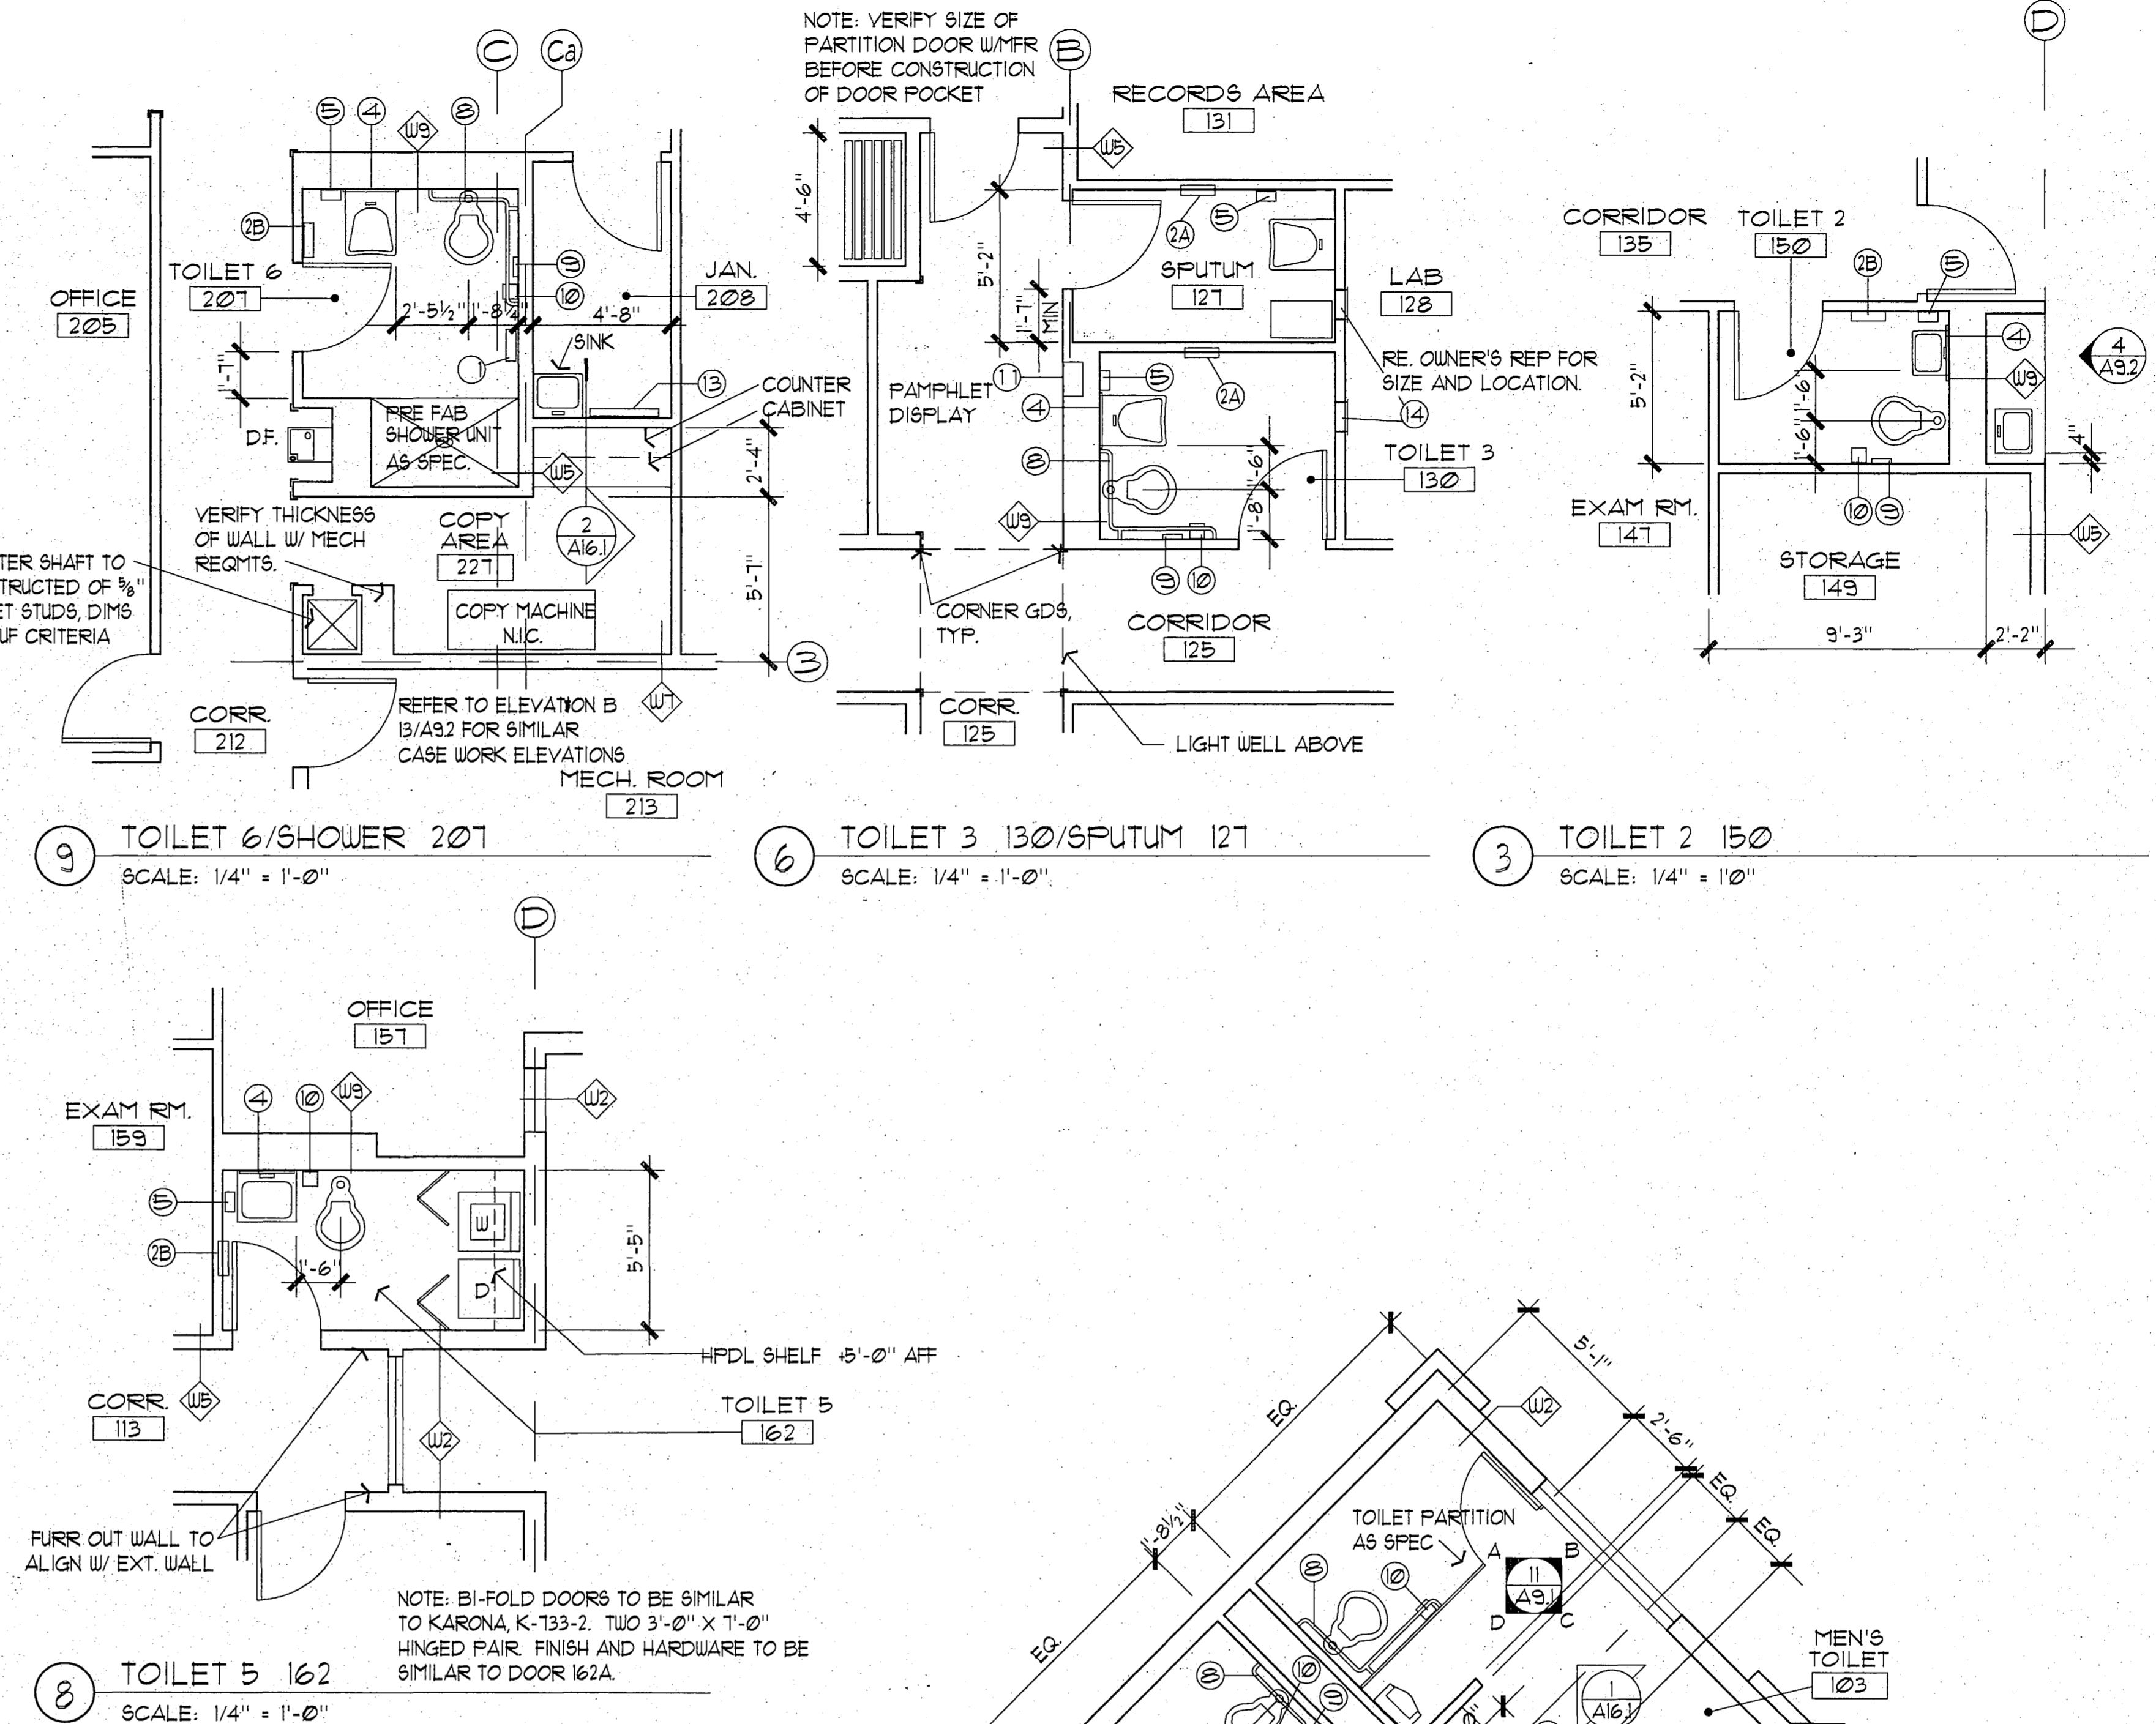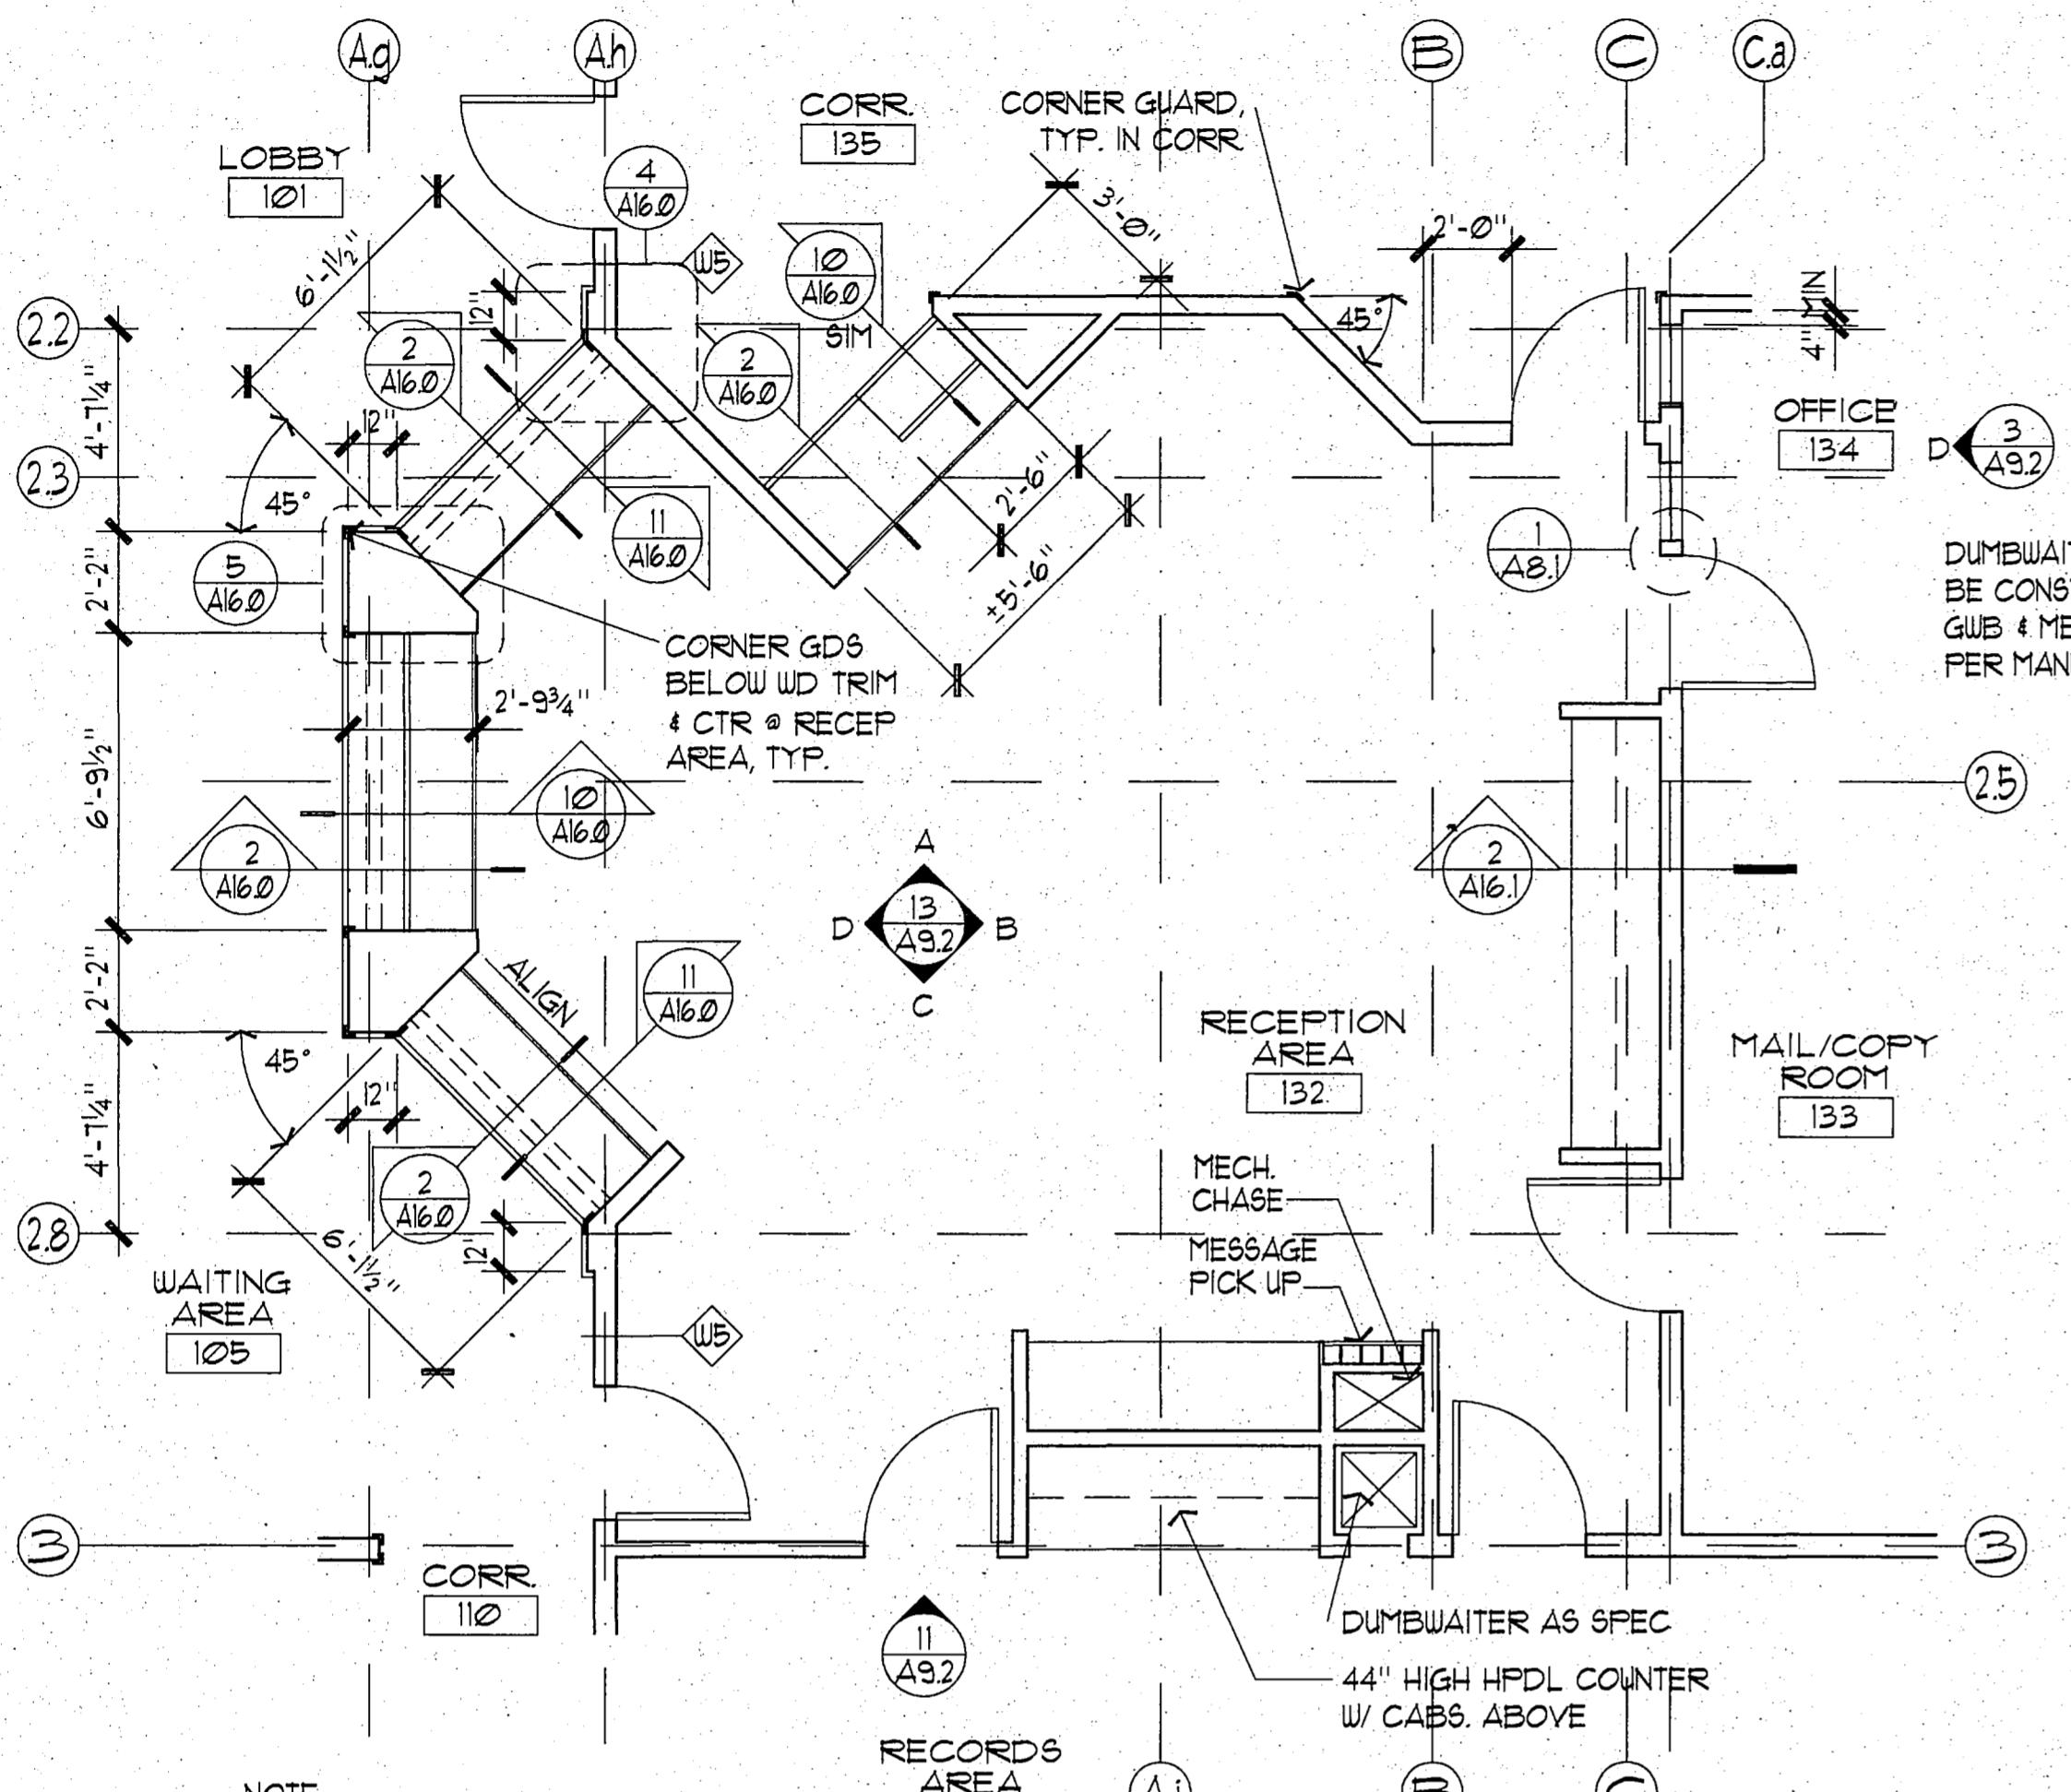

TITLE  
ENLARGED PLANS

SHEET NO.

A11.0


PROJECT NO. 115.00  
DRAWN BY AS  
CHECKED BY JBJA  
DATE DEC 9, 1992  
REVISED

STATE OF ALASKA  
49TH  
Professional  
4078A  
Thomas W. Livingston  
Architect  
4078A

LIVINGSTON  
STONE Architecture Engineering Interior Design Planning  
Incorporated

3900 Arctic Blvd. Suite 301  
Anchorage, Alaska 99503-5790  
(907) 562-2055

FAIRBANKS HEALTH CENTER  
City of Fairbanks  
Fairbanks, Alaska

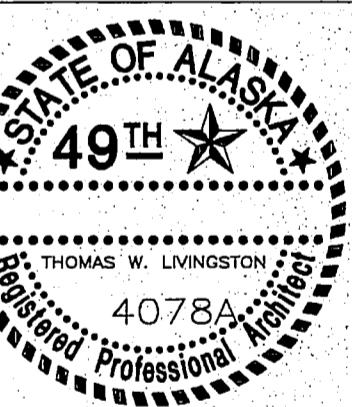

PROJECT NO. 115.00

DRAWN BY AS









CHECKED BY JB, JA

DATE DEC 9, 1992

REVISED

 TITLE  
**ENLARGED PLANS**



SHEET NO.

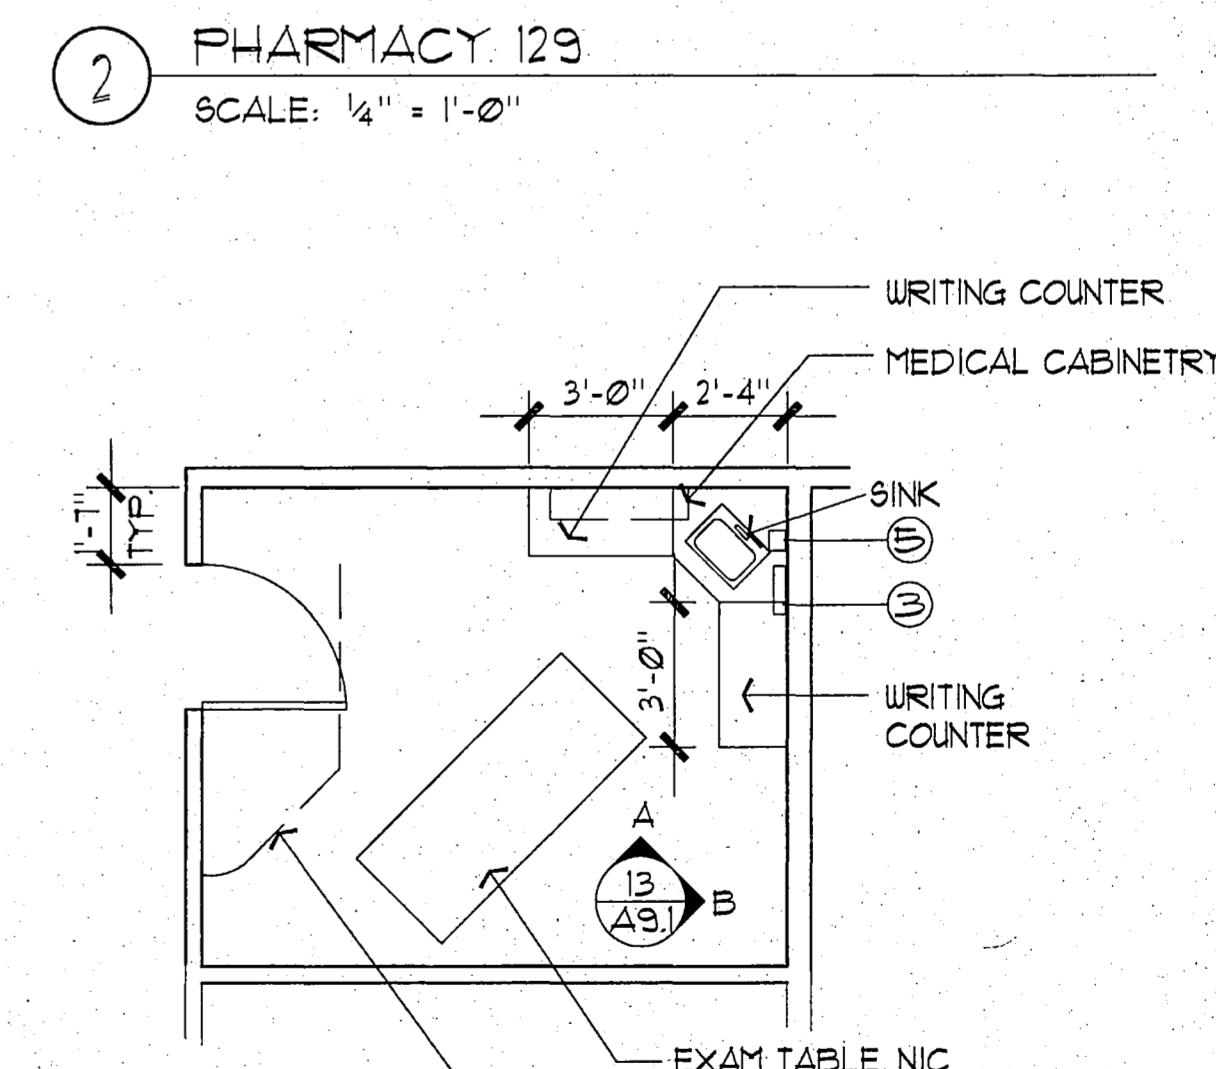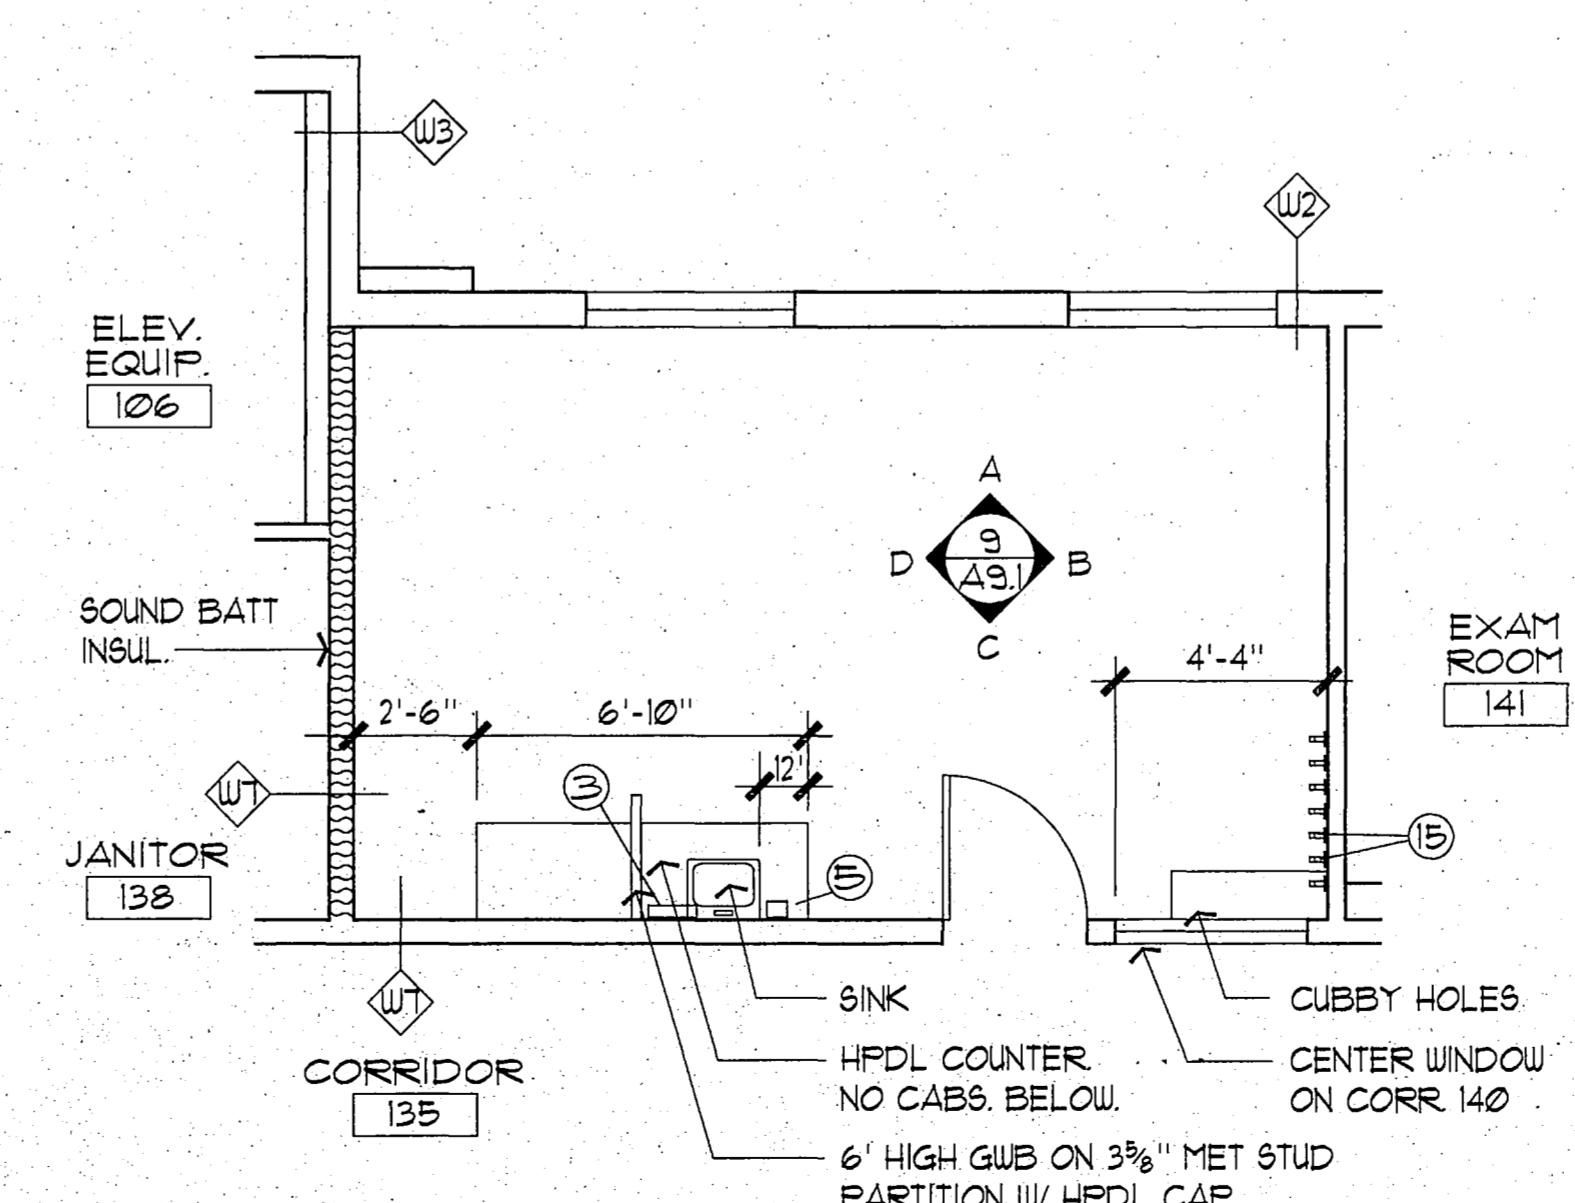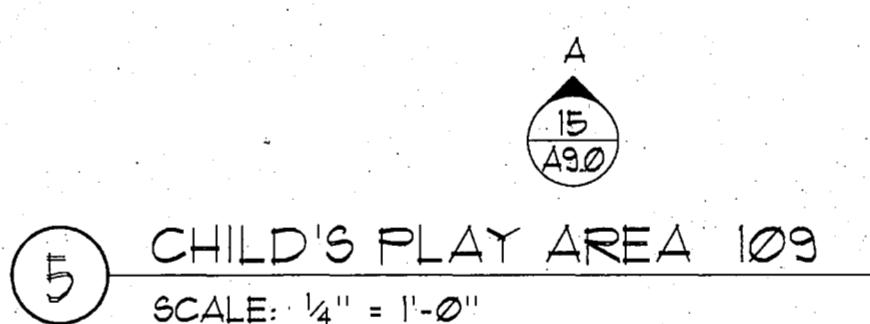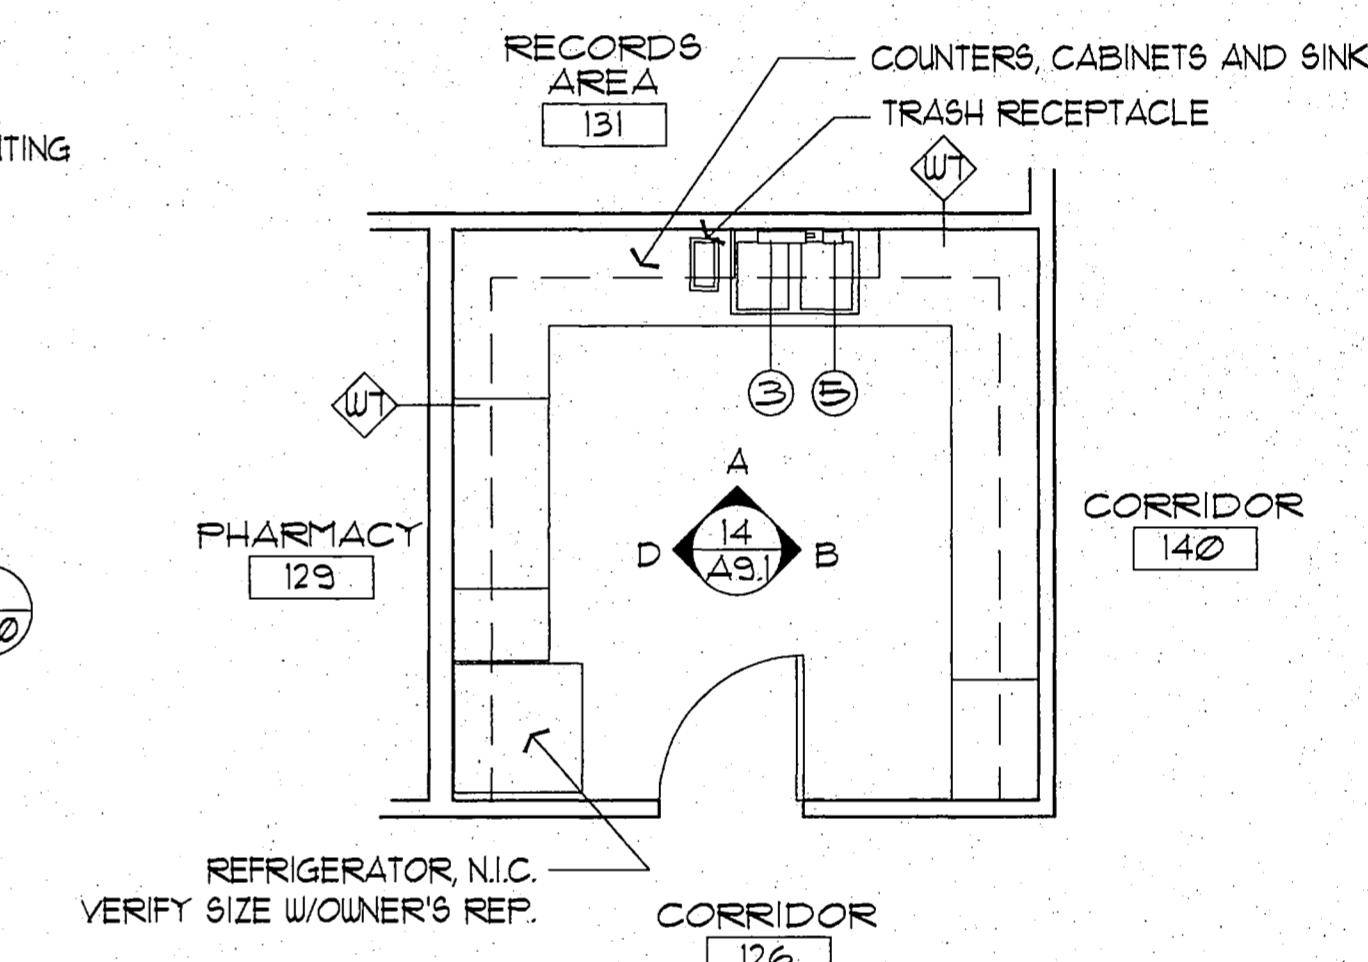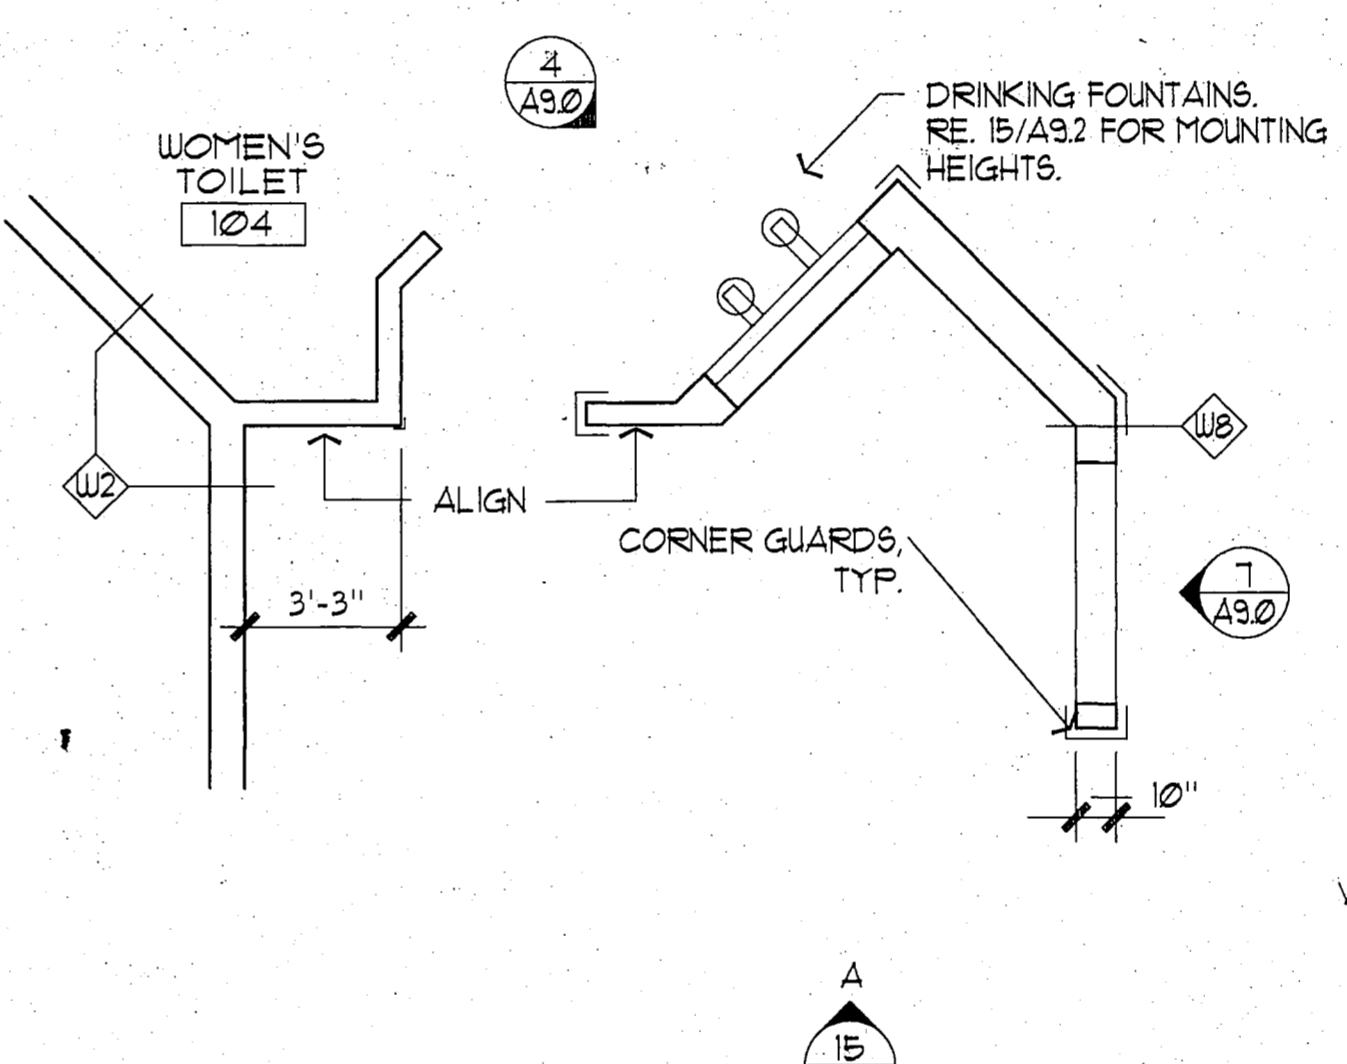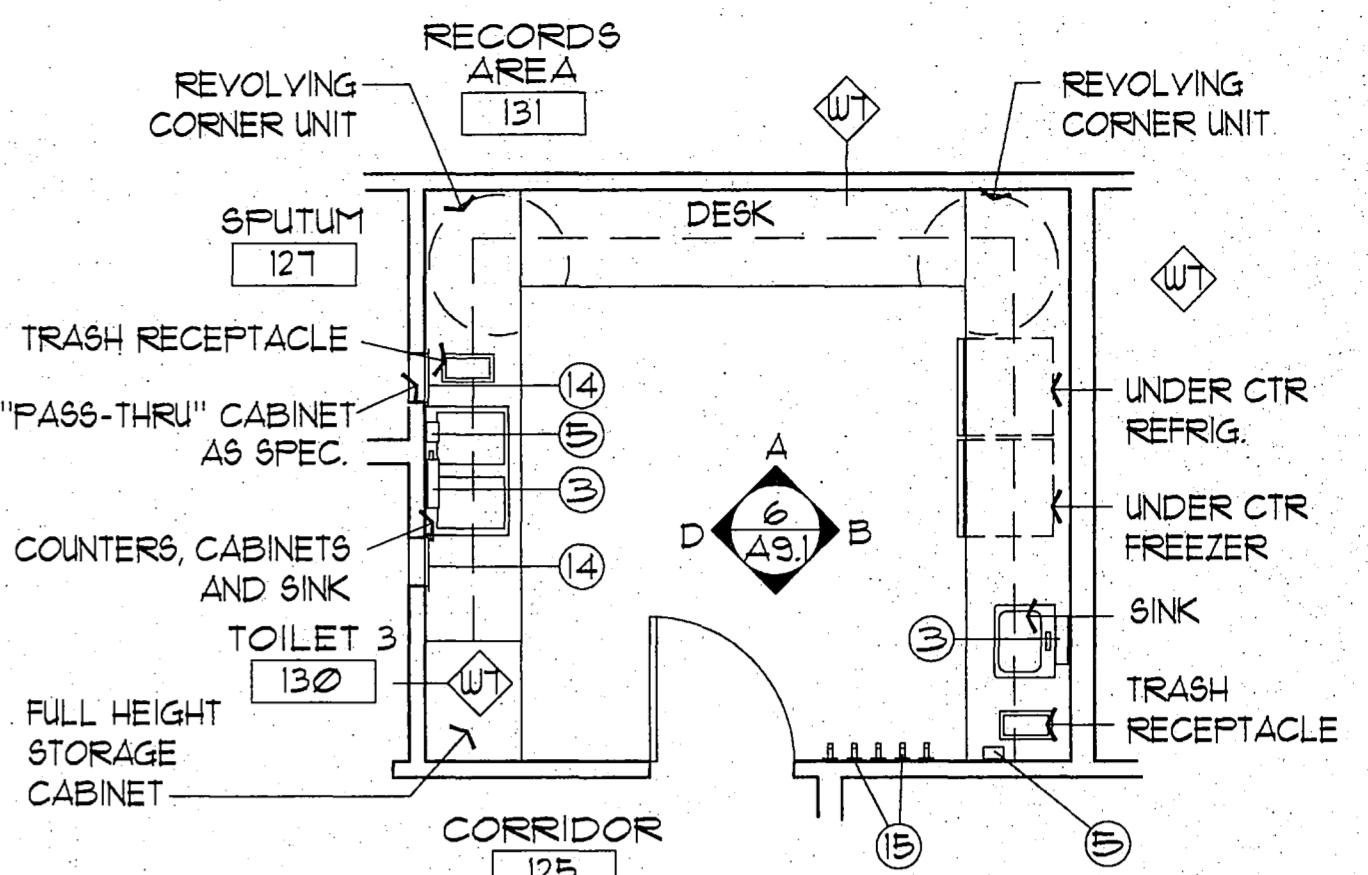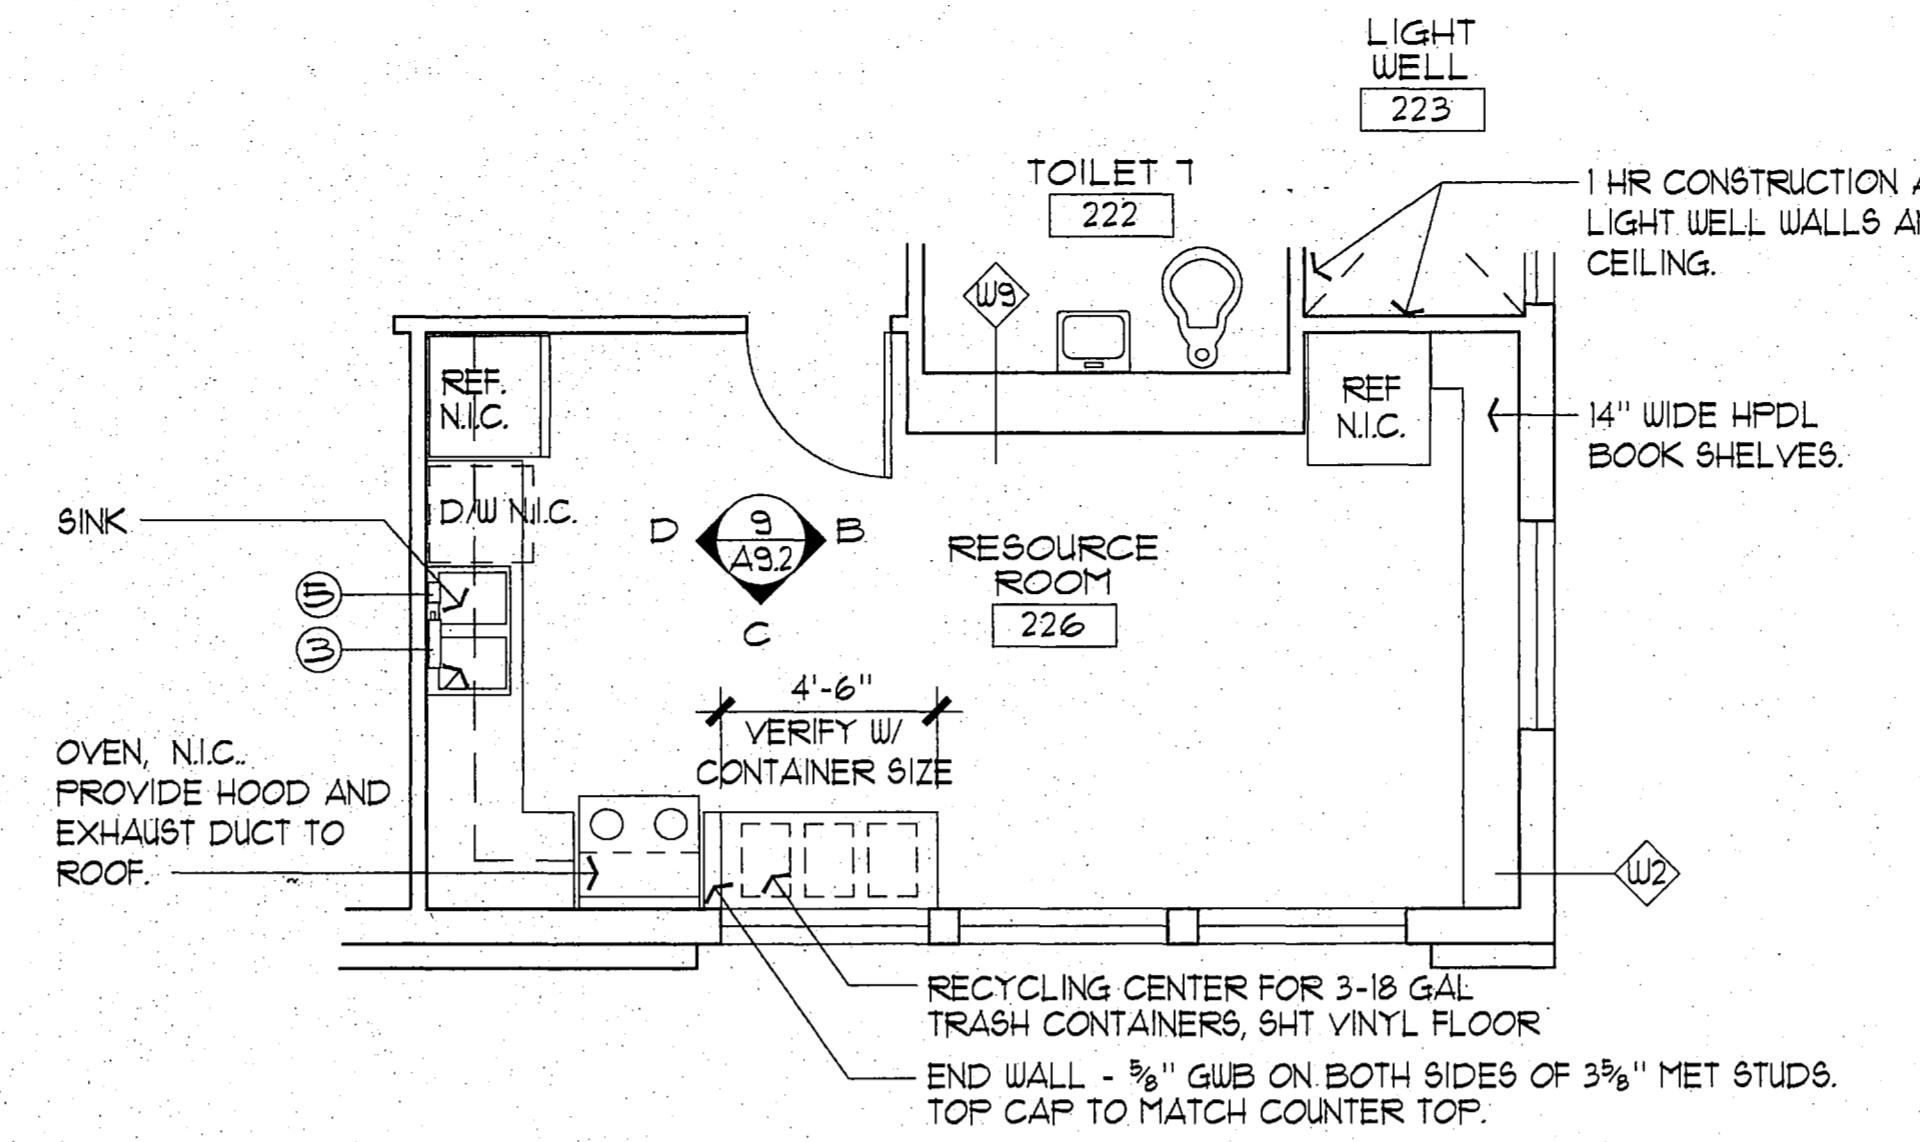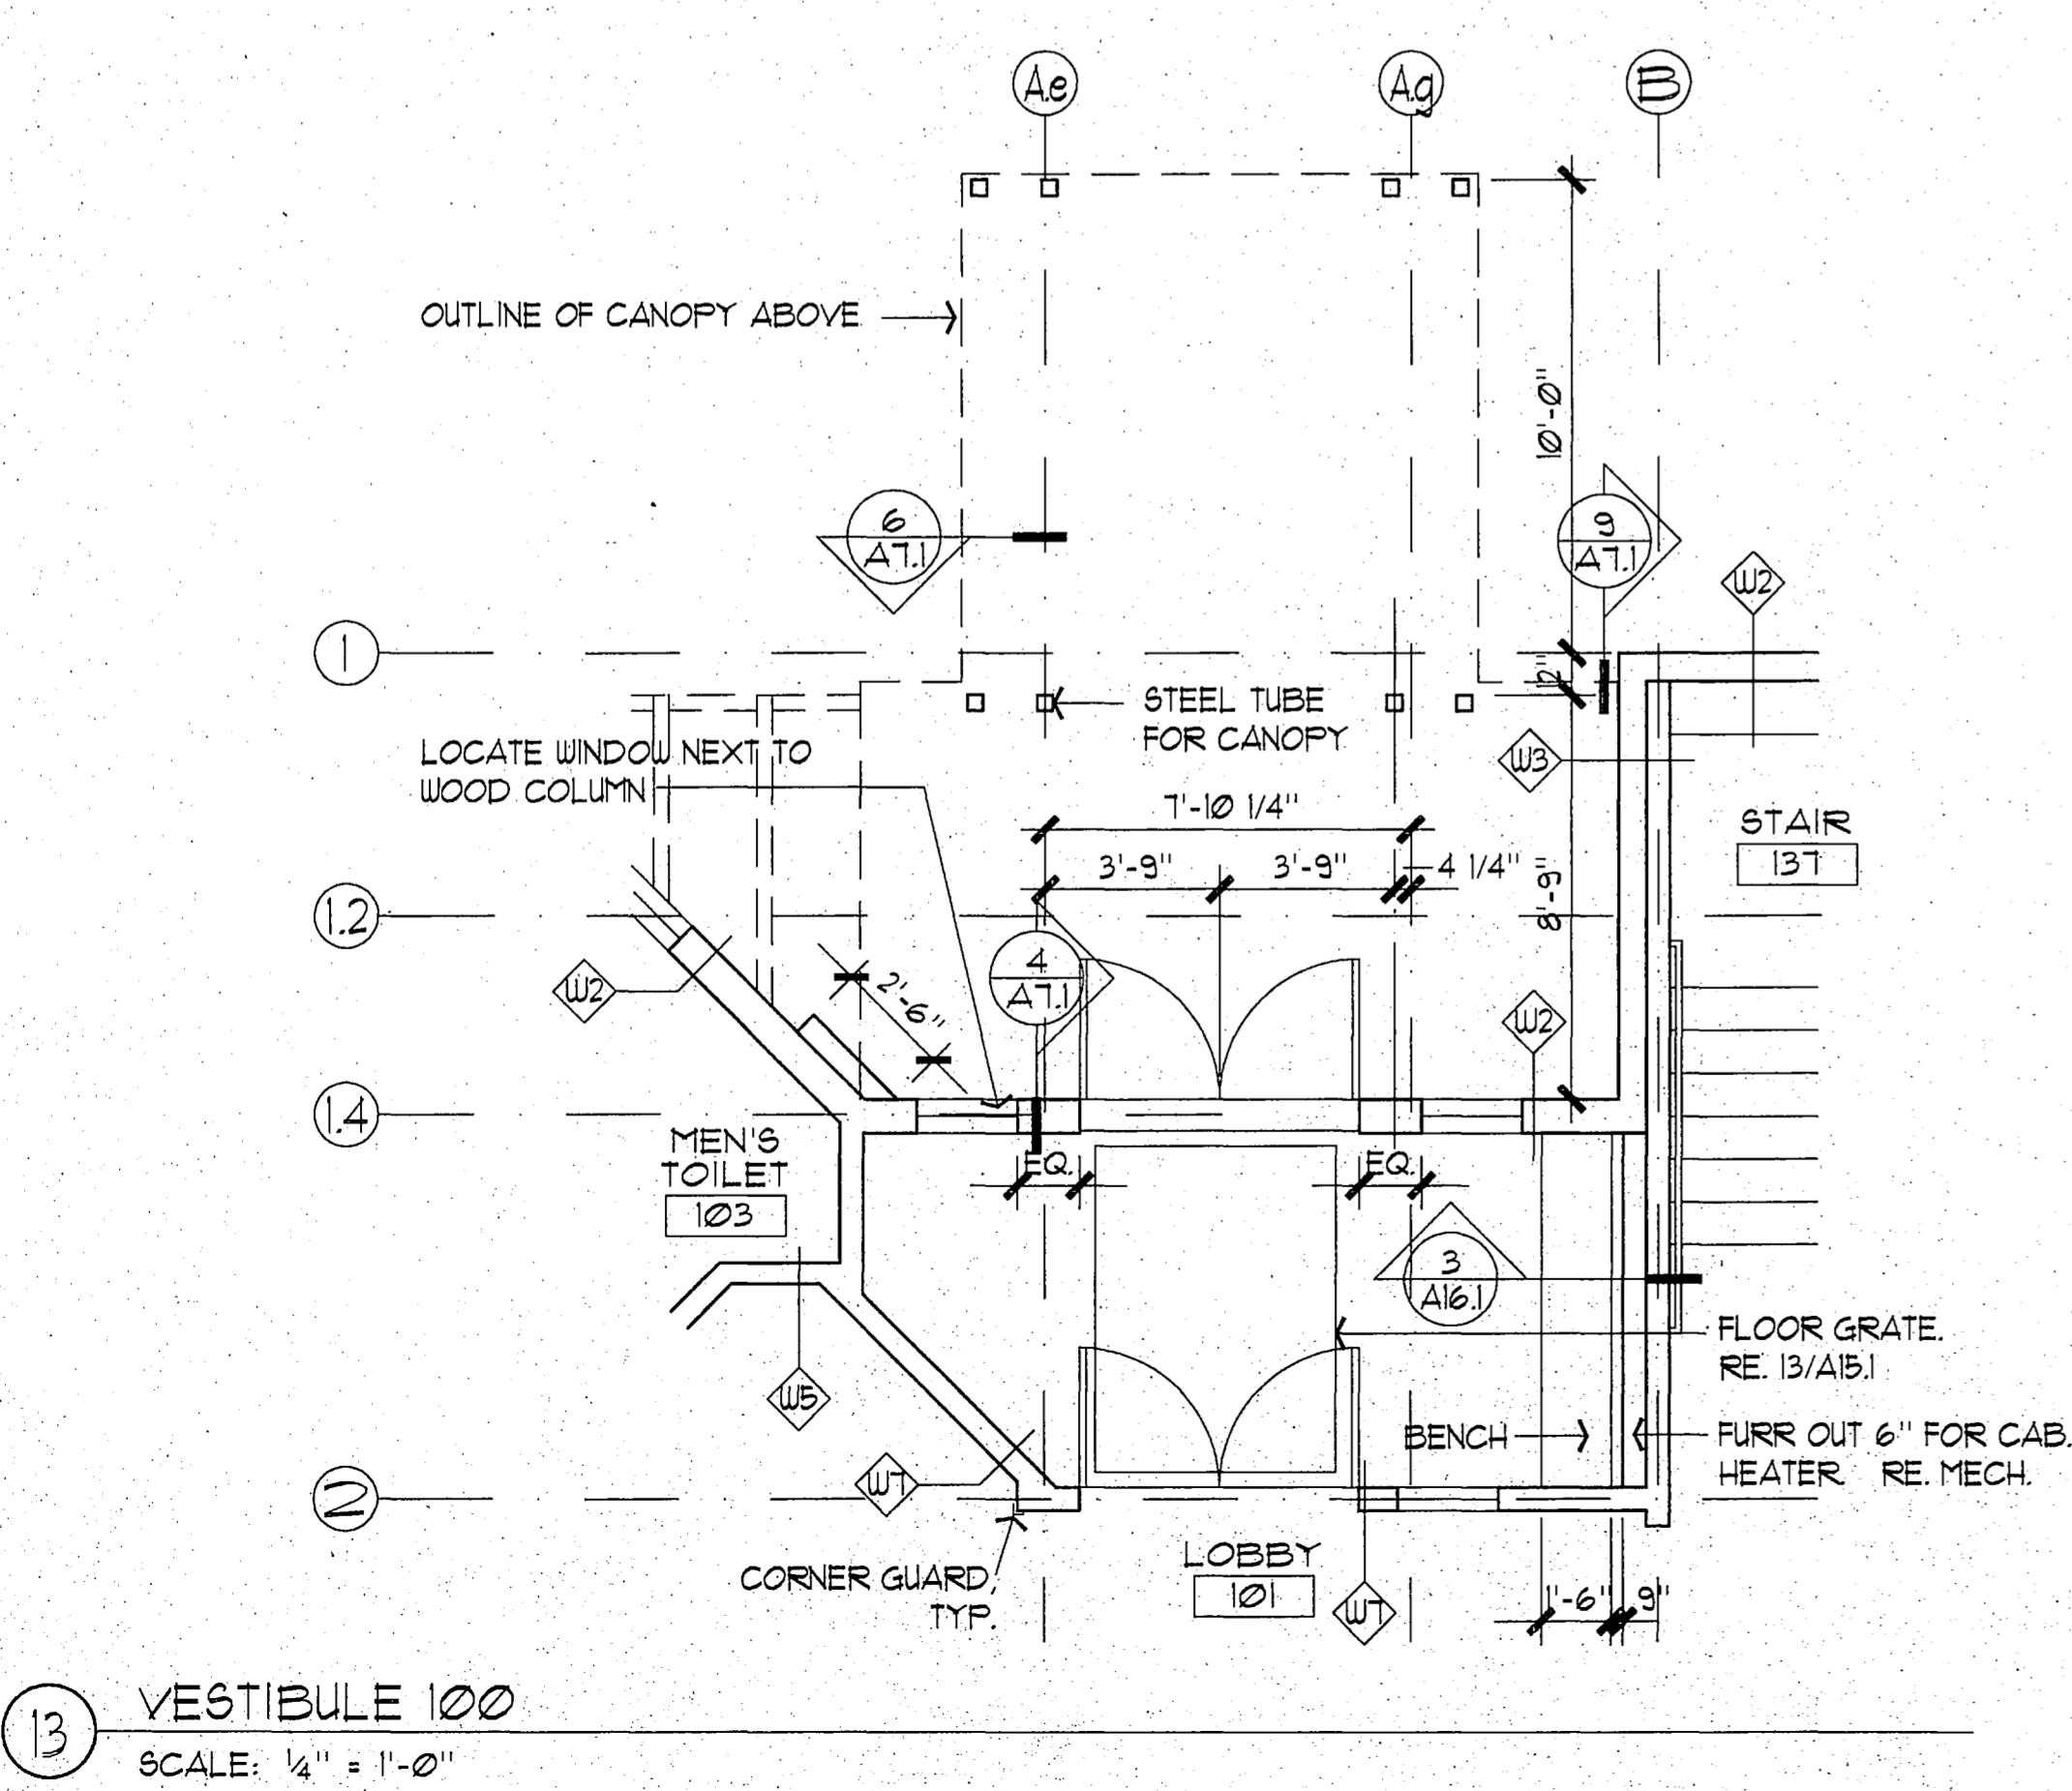**A11.1**

# RECORD DRAWING


*Rufus B. Beach*  
CITY ENGINEER, CITY OF FAIRBANKS

4/8/96  
DATE

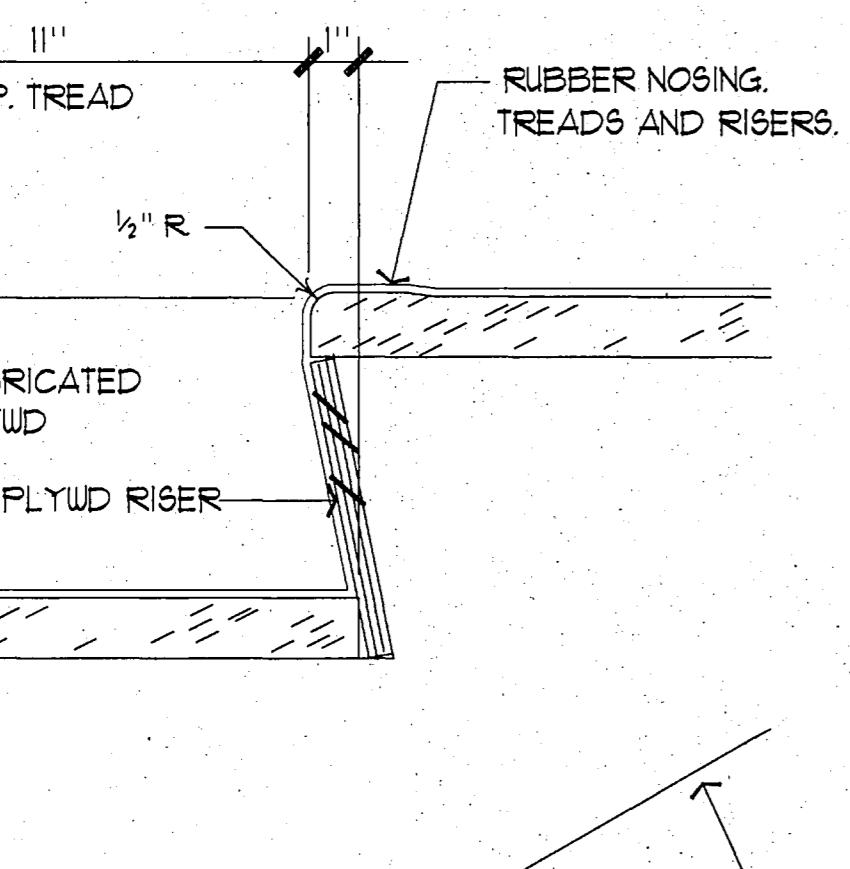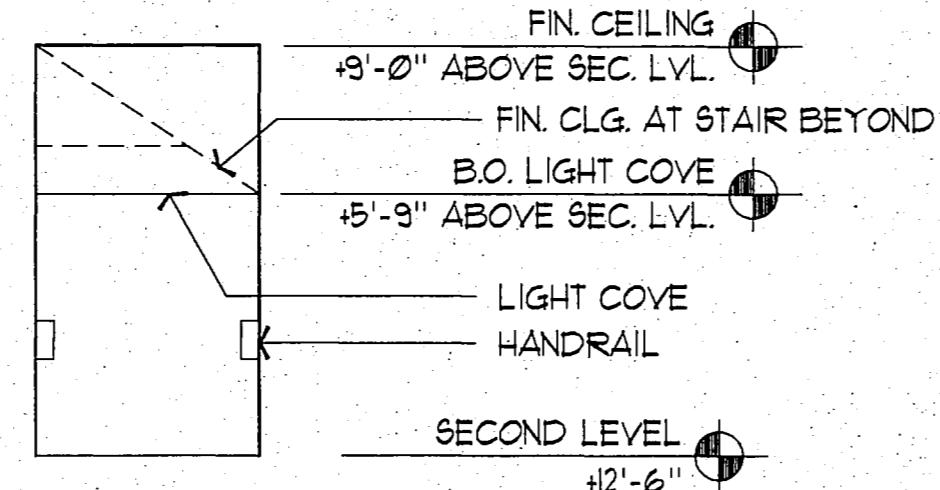


(12) ELEVATION AT STAIR 1 LANDING  
SCALE: 1/4" = 1'-0"

(14) STAIR TREAD  
SCALE: 3" = 1'-0"

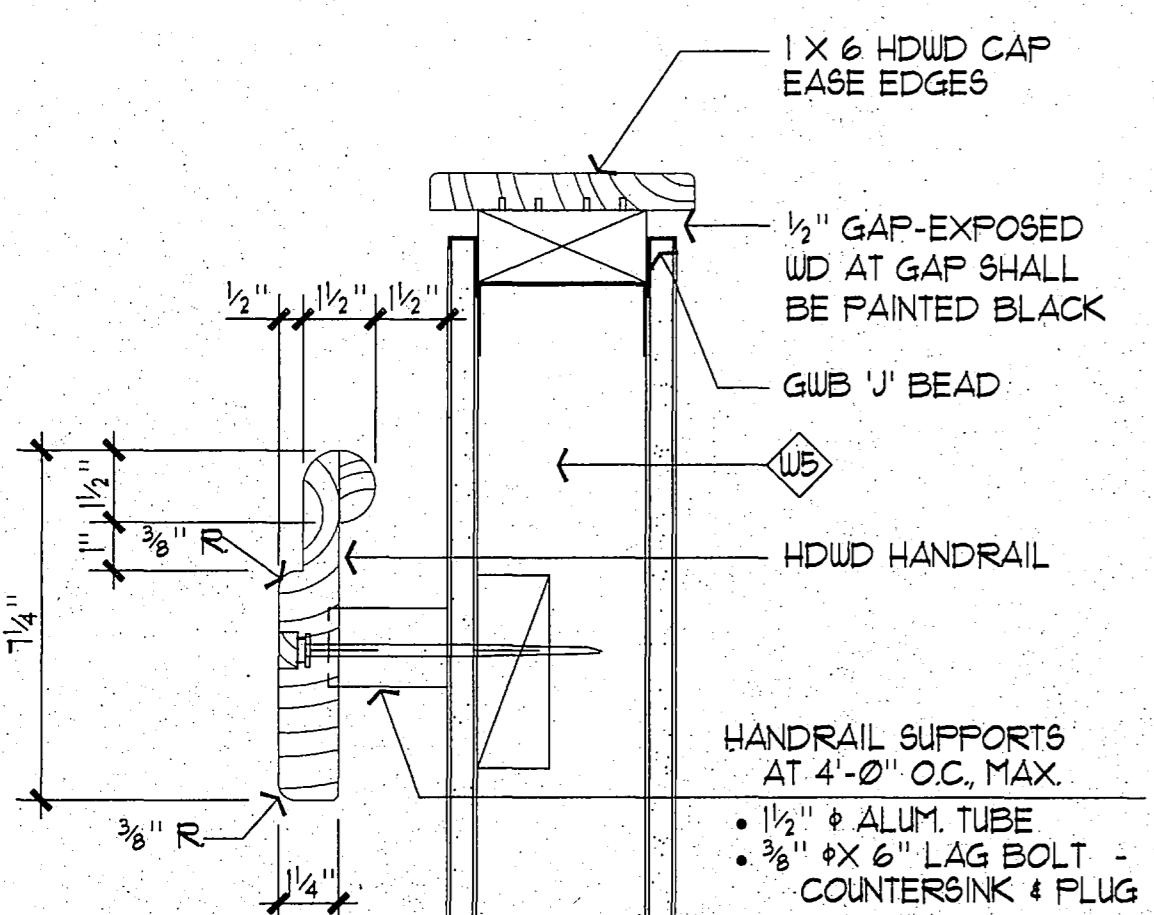


(13) HANDRAIL & WALL CAP  
SCALE: 3" = 1'-0"


(10) STAIR 1 - REFL. CLG PLAN  
SCALE: 1/4" = 1'-0"

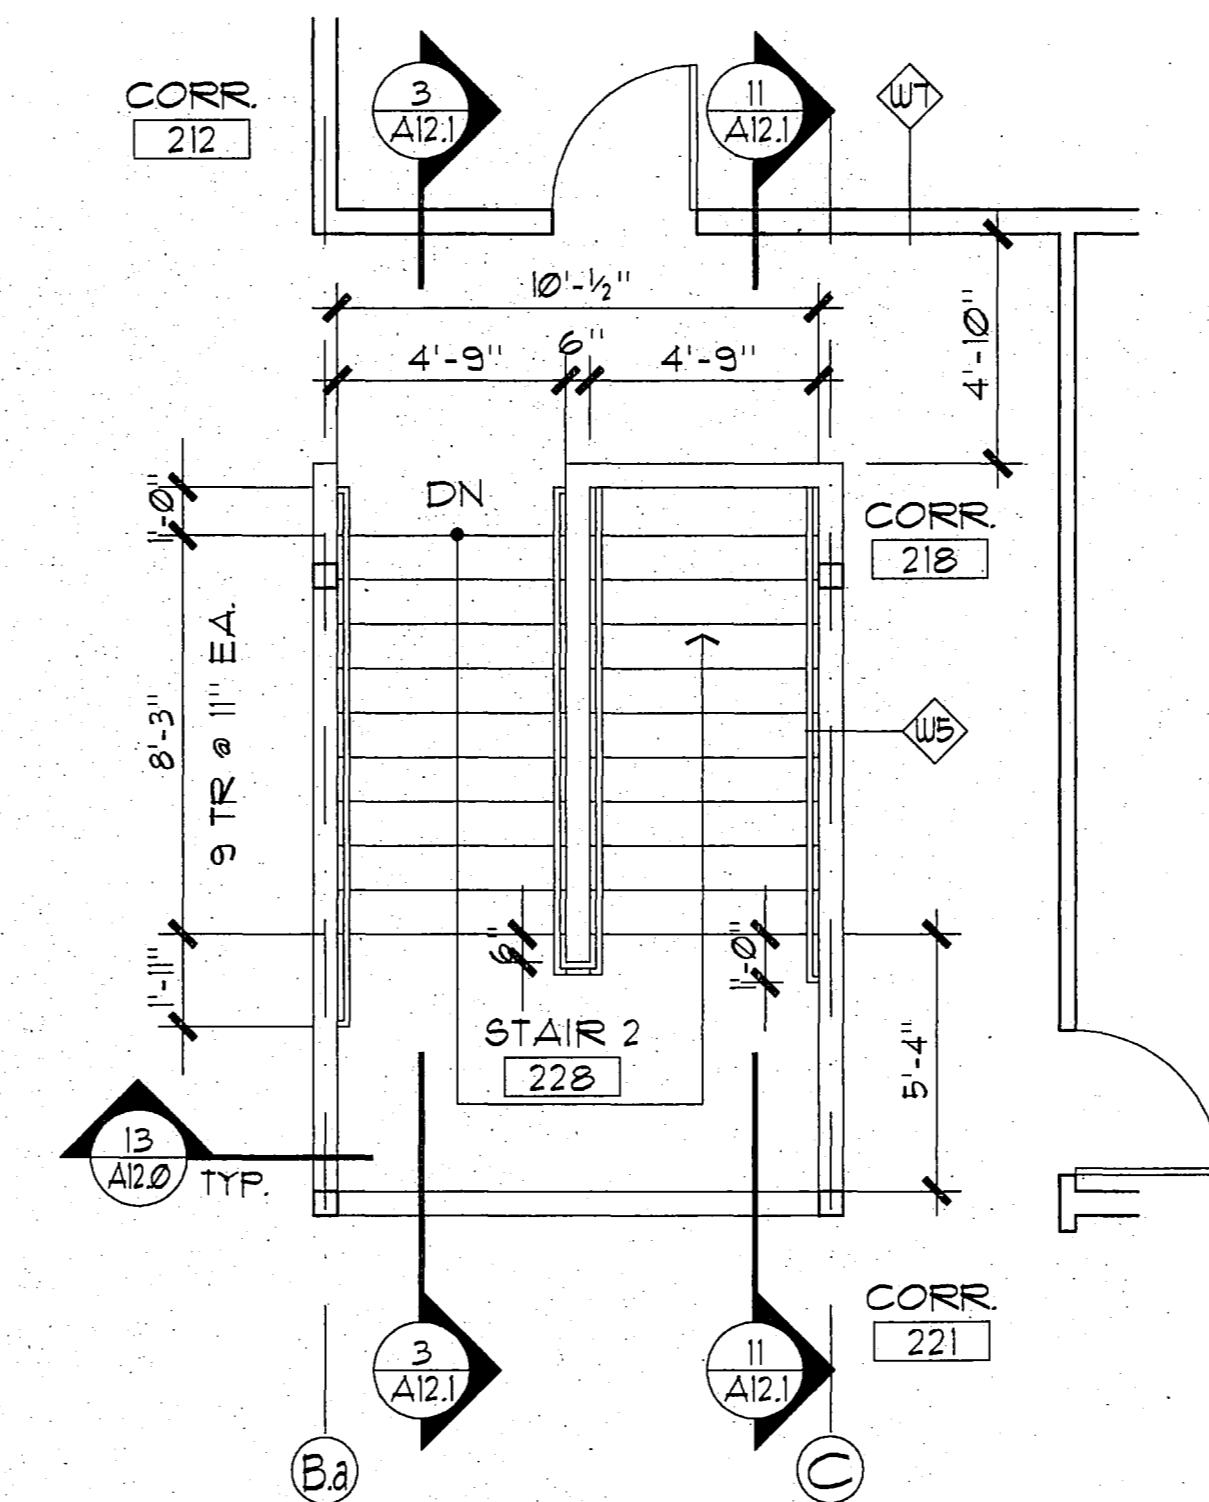


(9) STAIR 2 - SECOND LEVEL  
SCALE: 1/4" = 1'-0"

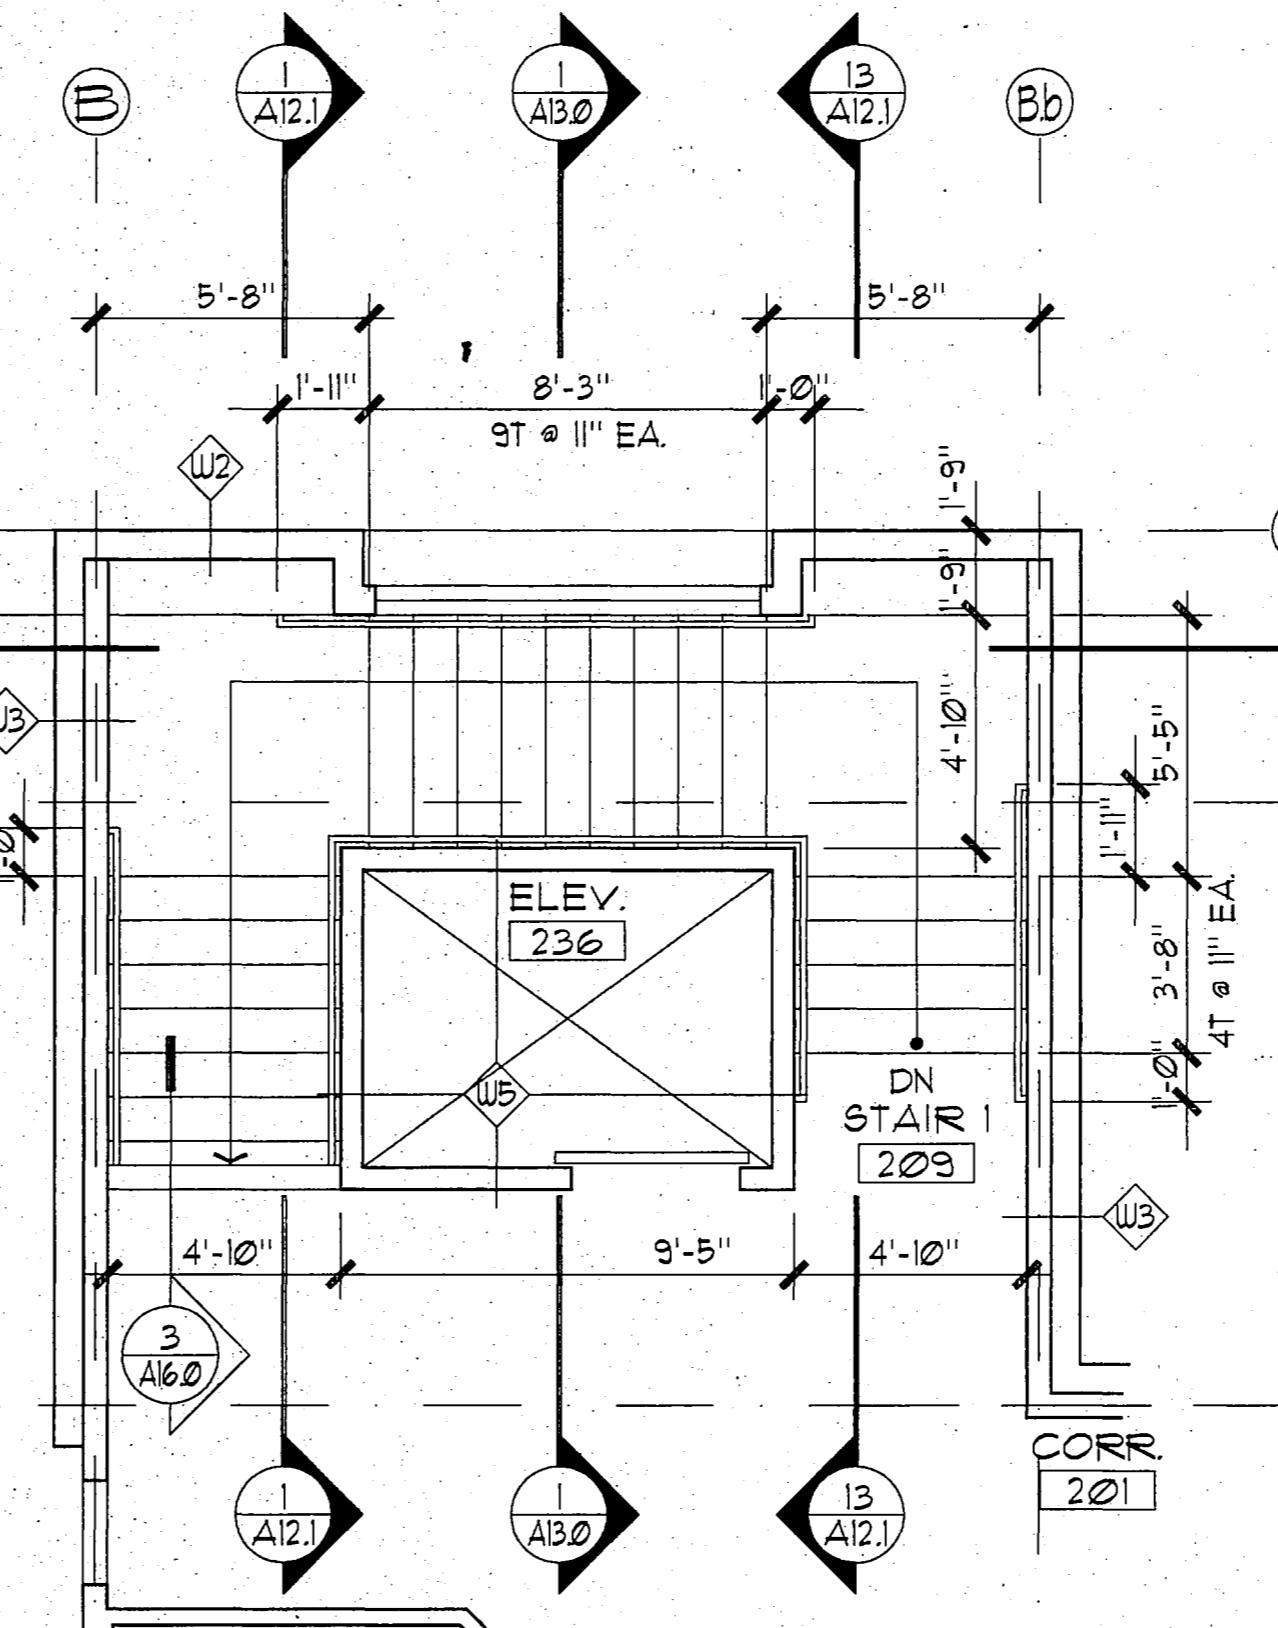

(7) STAIR 1 - SECOND LEVEL  
SCALE: 1/4" = 1'-0"

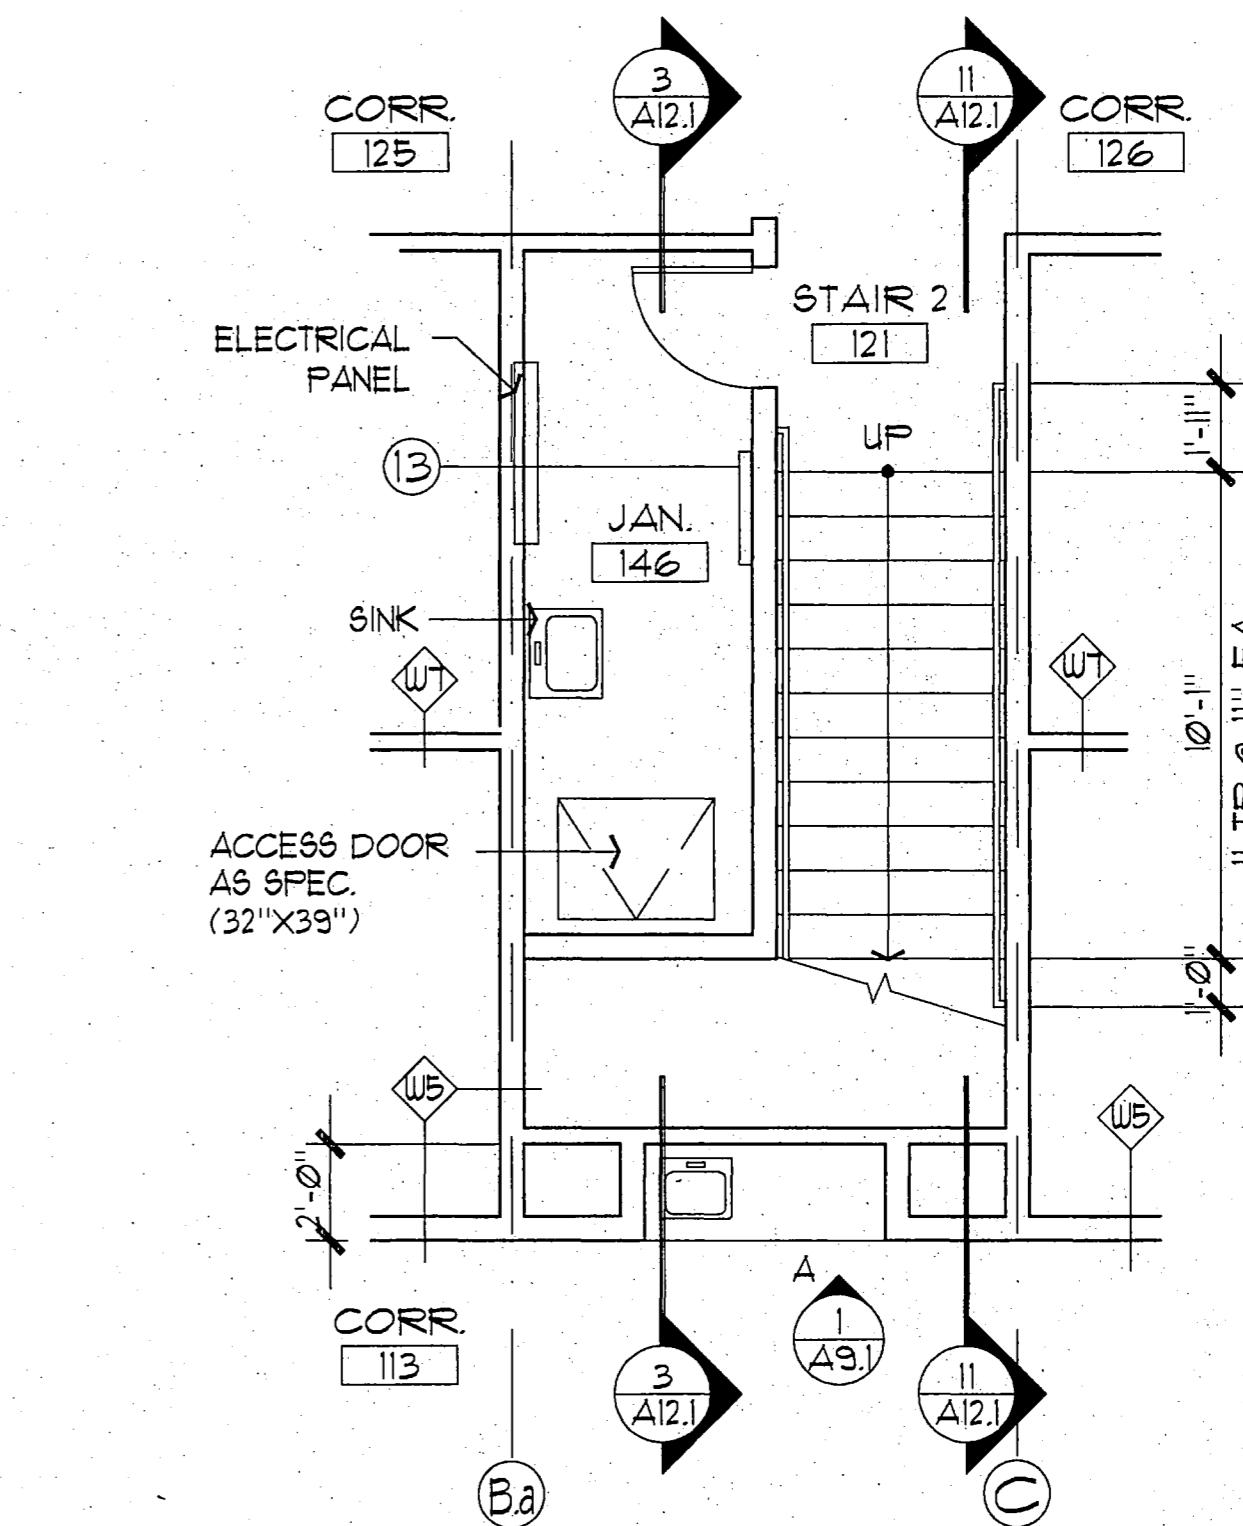

(3) STAIR 2 - FIRST LEVEL  
SCALE: 1/4" = 1'-0"

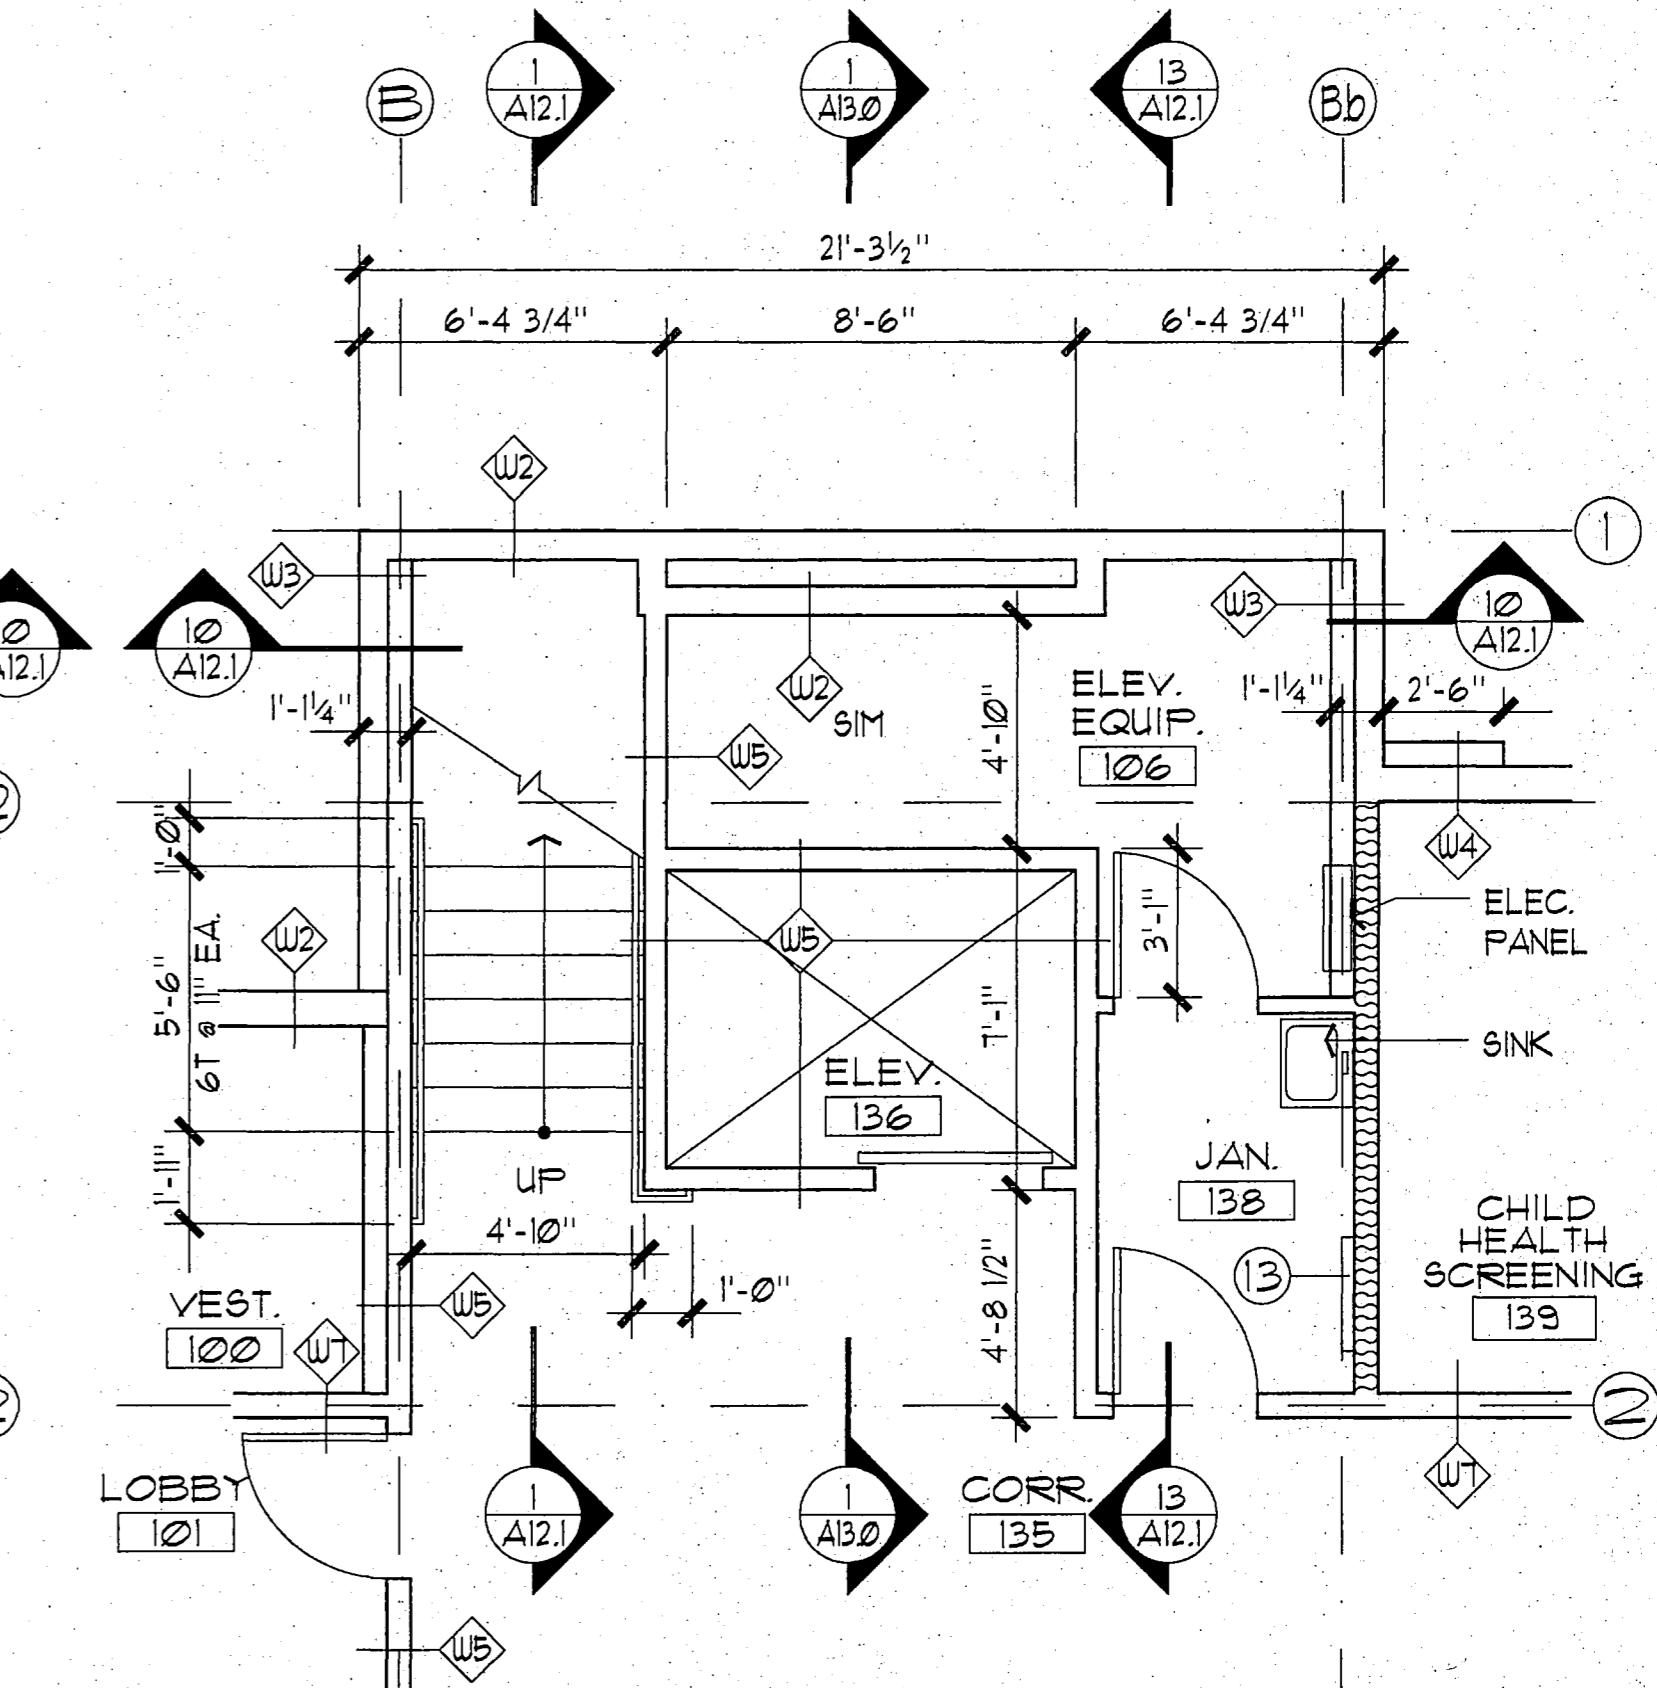


(1) STAIR 1 - FIRST LEVEL  
SCALE: 1/4" = 1'-0"

- NOTES:
1. RE. A14/0 FOR PARTITIONS TYPES. ALL PARTITIONS W/ U.ON.
  2. RE. 15/A92 FOR ACCESSORY NUMBERS AS INDICATED.

**LIVINGSTON**  
Architecture Engineering  
Interior Design Planning  
Incorporated

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(907) 563-2058

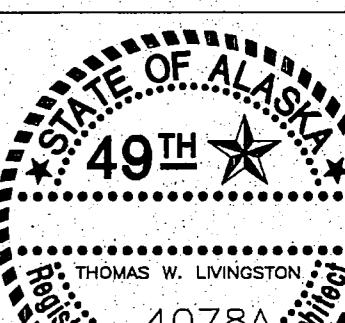

PROJECT NO. 115.00  
DRAWN BY ALS,CY,OK  
CHECKED BY JB,JA  
DATE DEC 9, 1992  
REVISED

TITLE  
STAIR  
PLANS  
SHEET NO.

A12.0




# FAIRBANKS HEALTH CENTER

Fairbanks, Alaska

## RECORD DRAWING


Rufus B. Ranch  
CITY ENGINEER, CITY OF FAIRBANKS

4/18/96

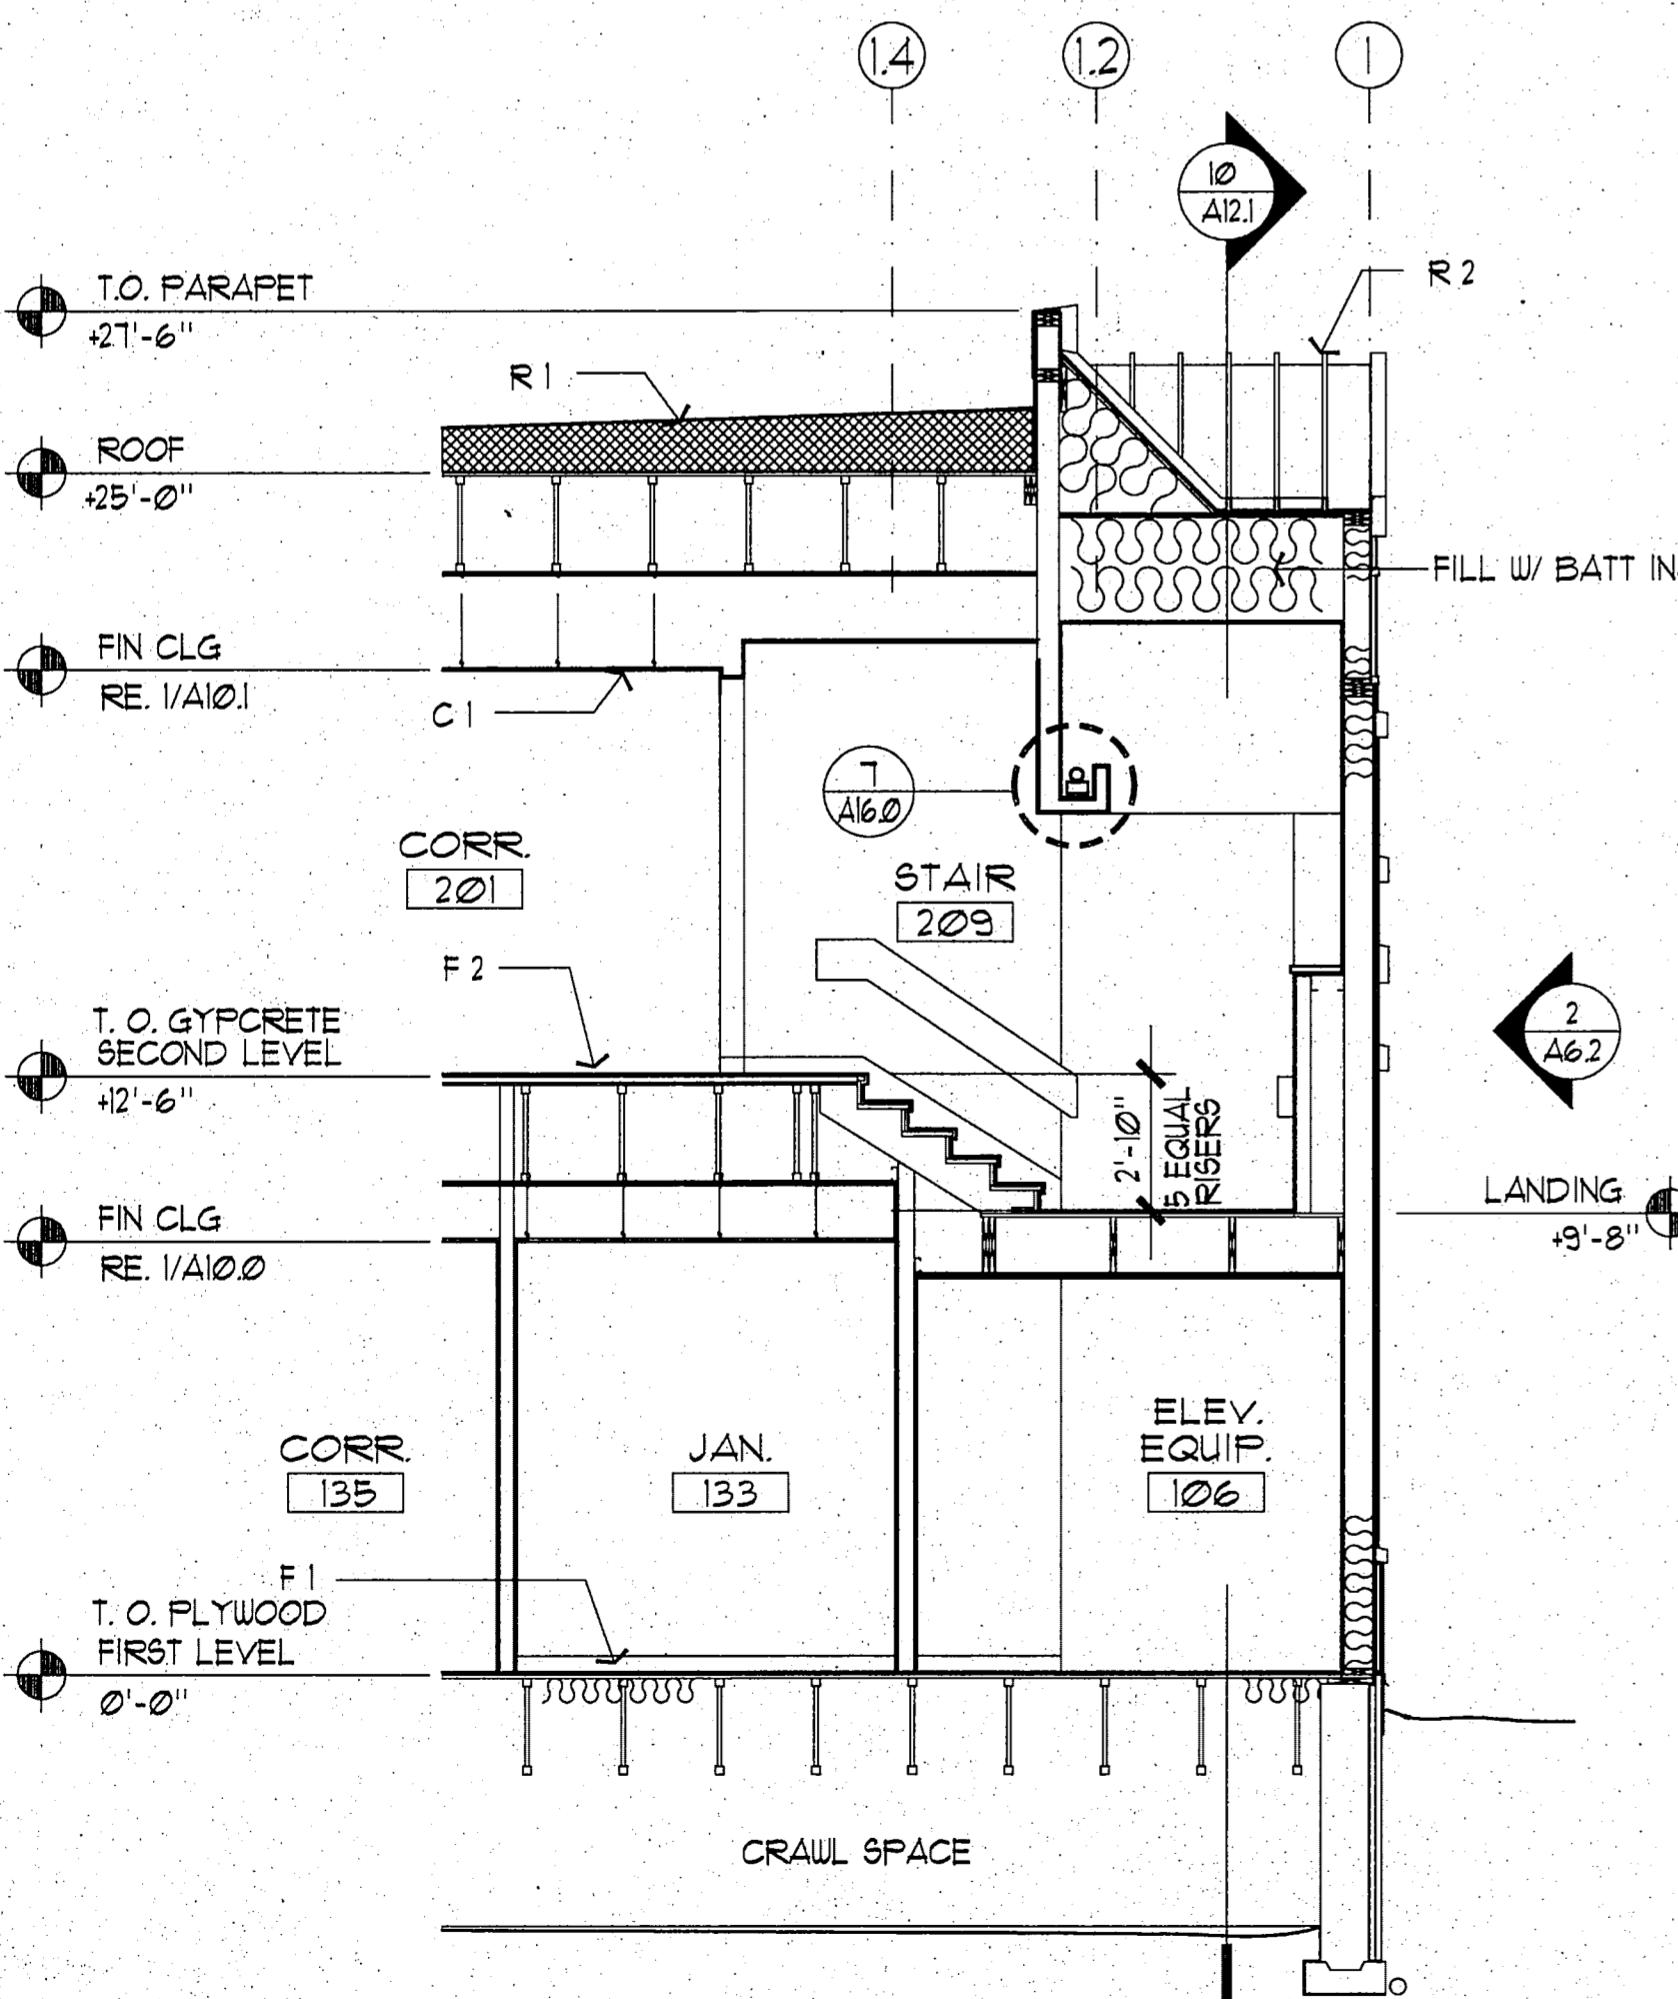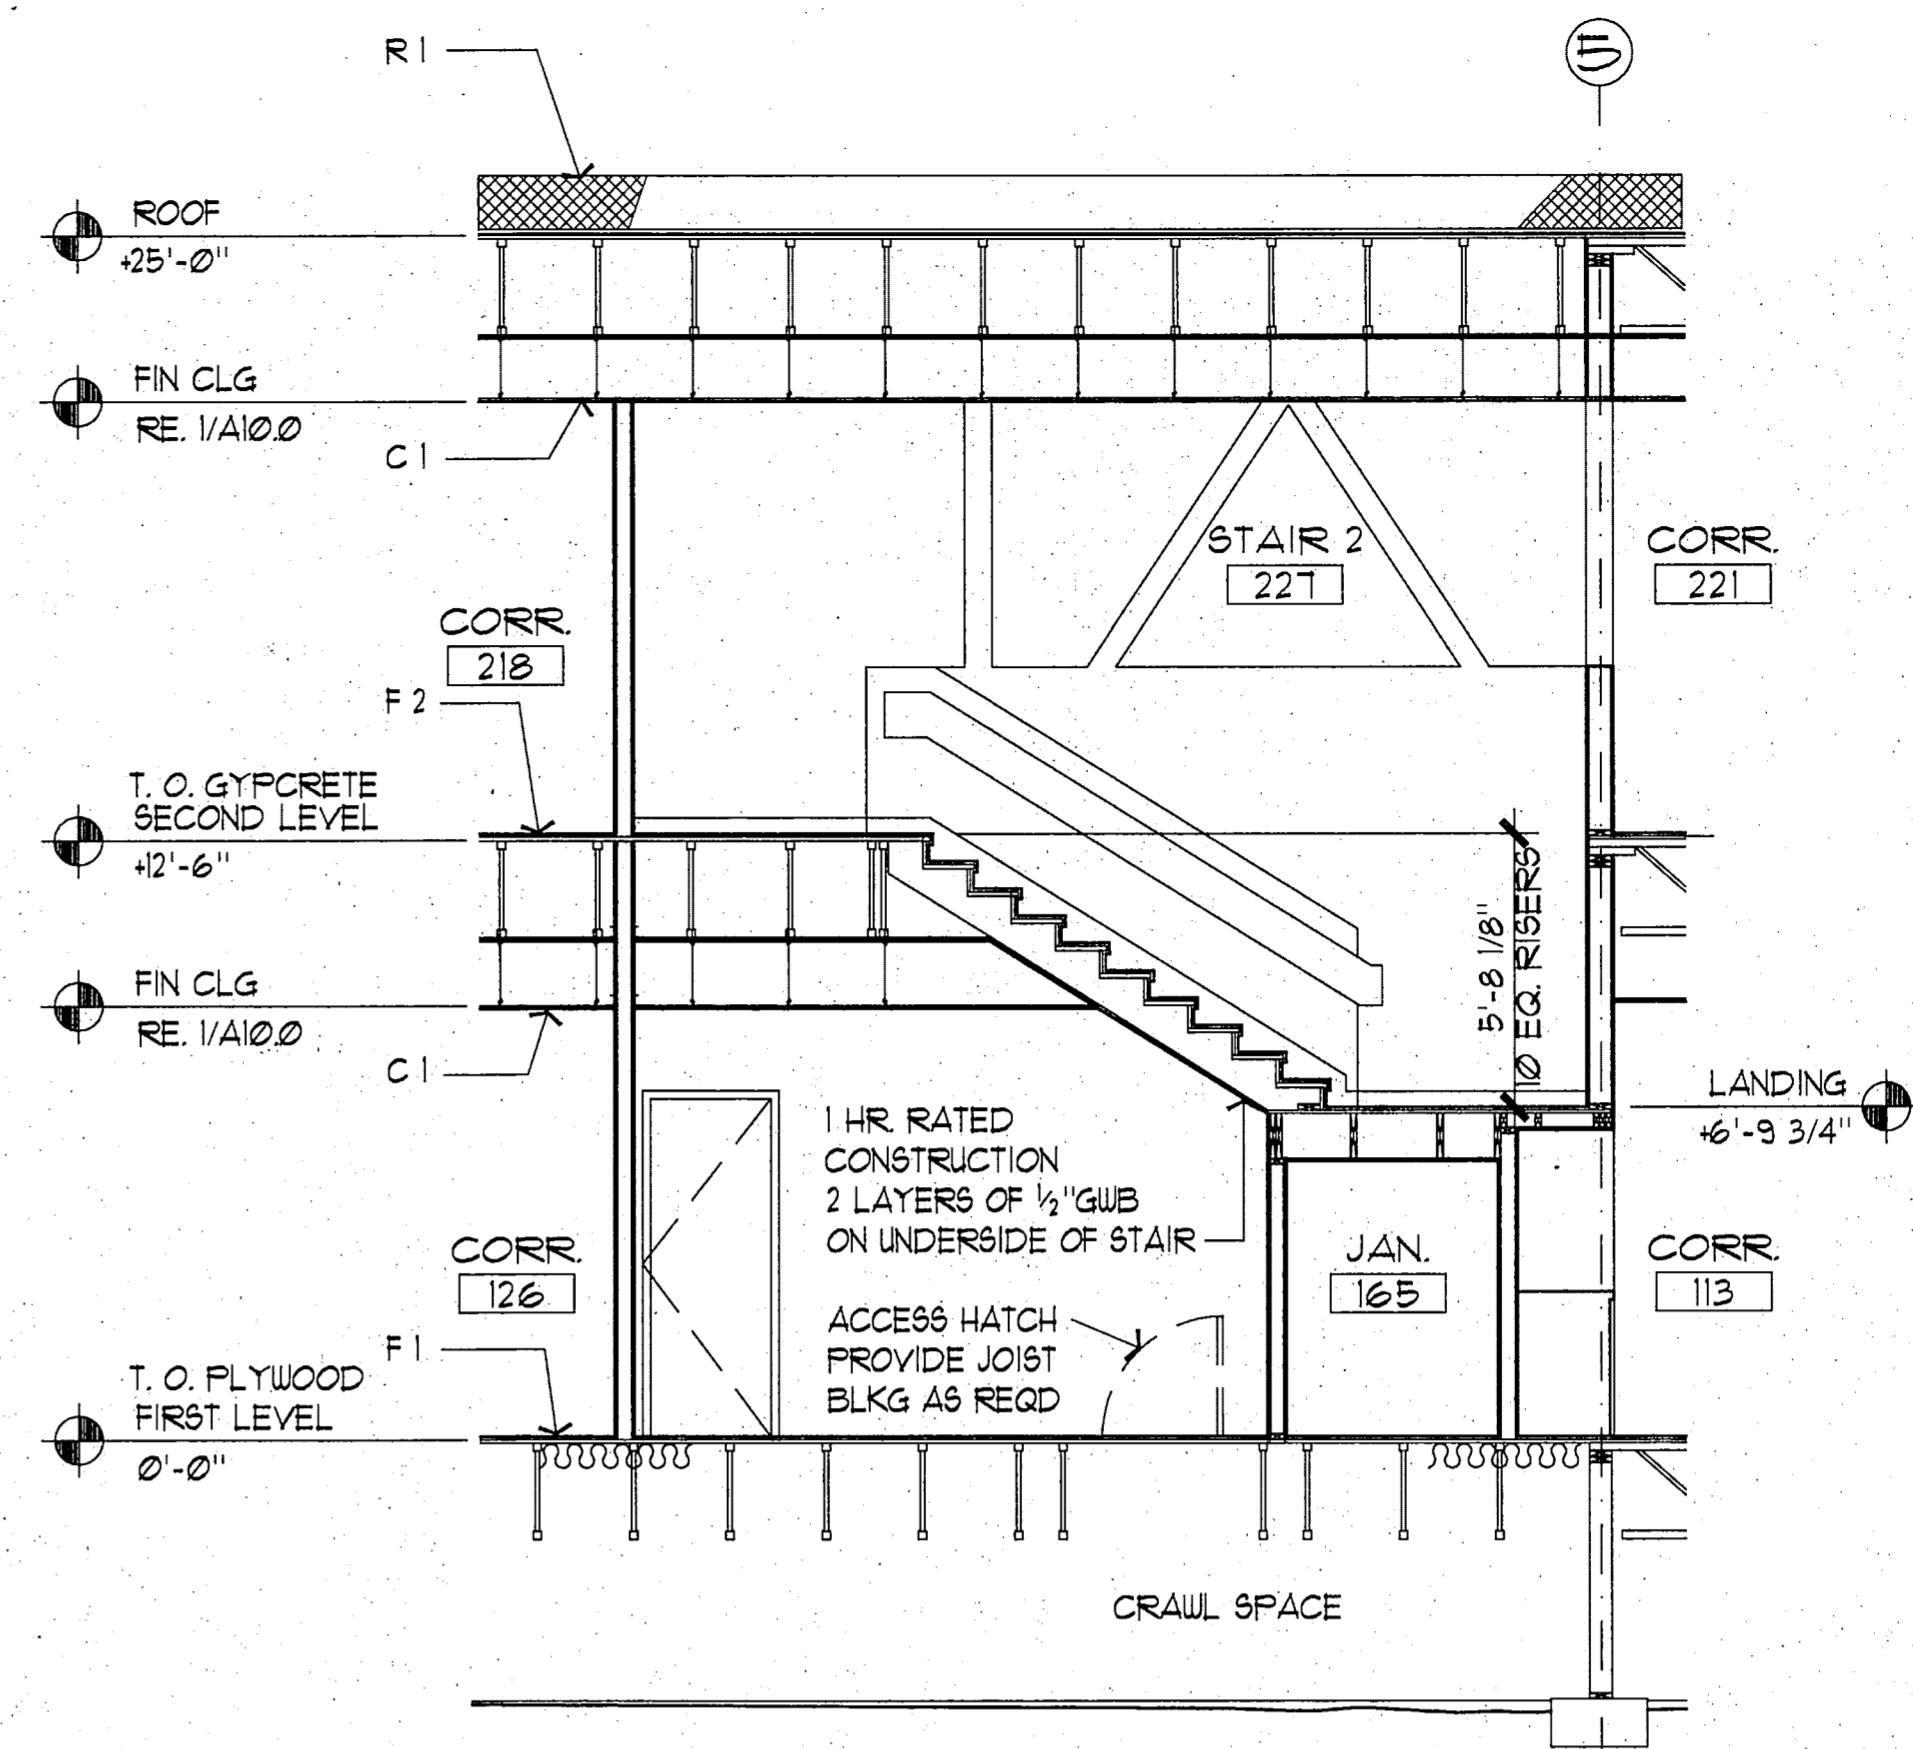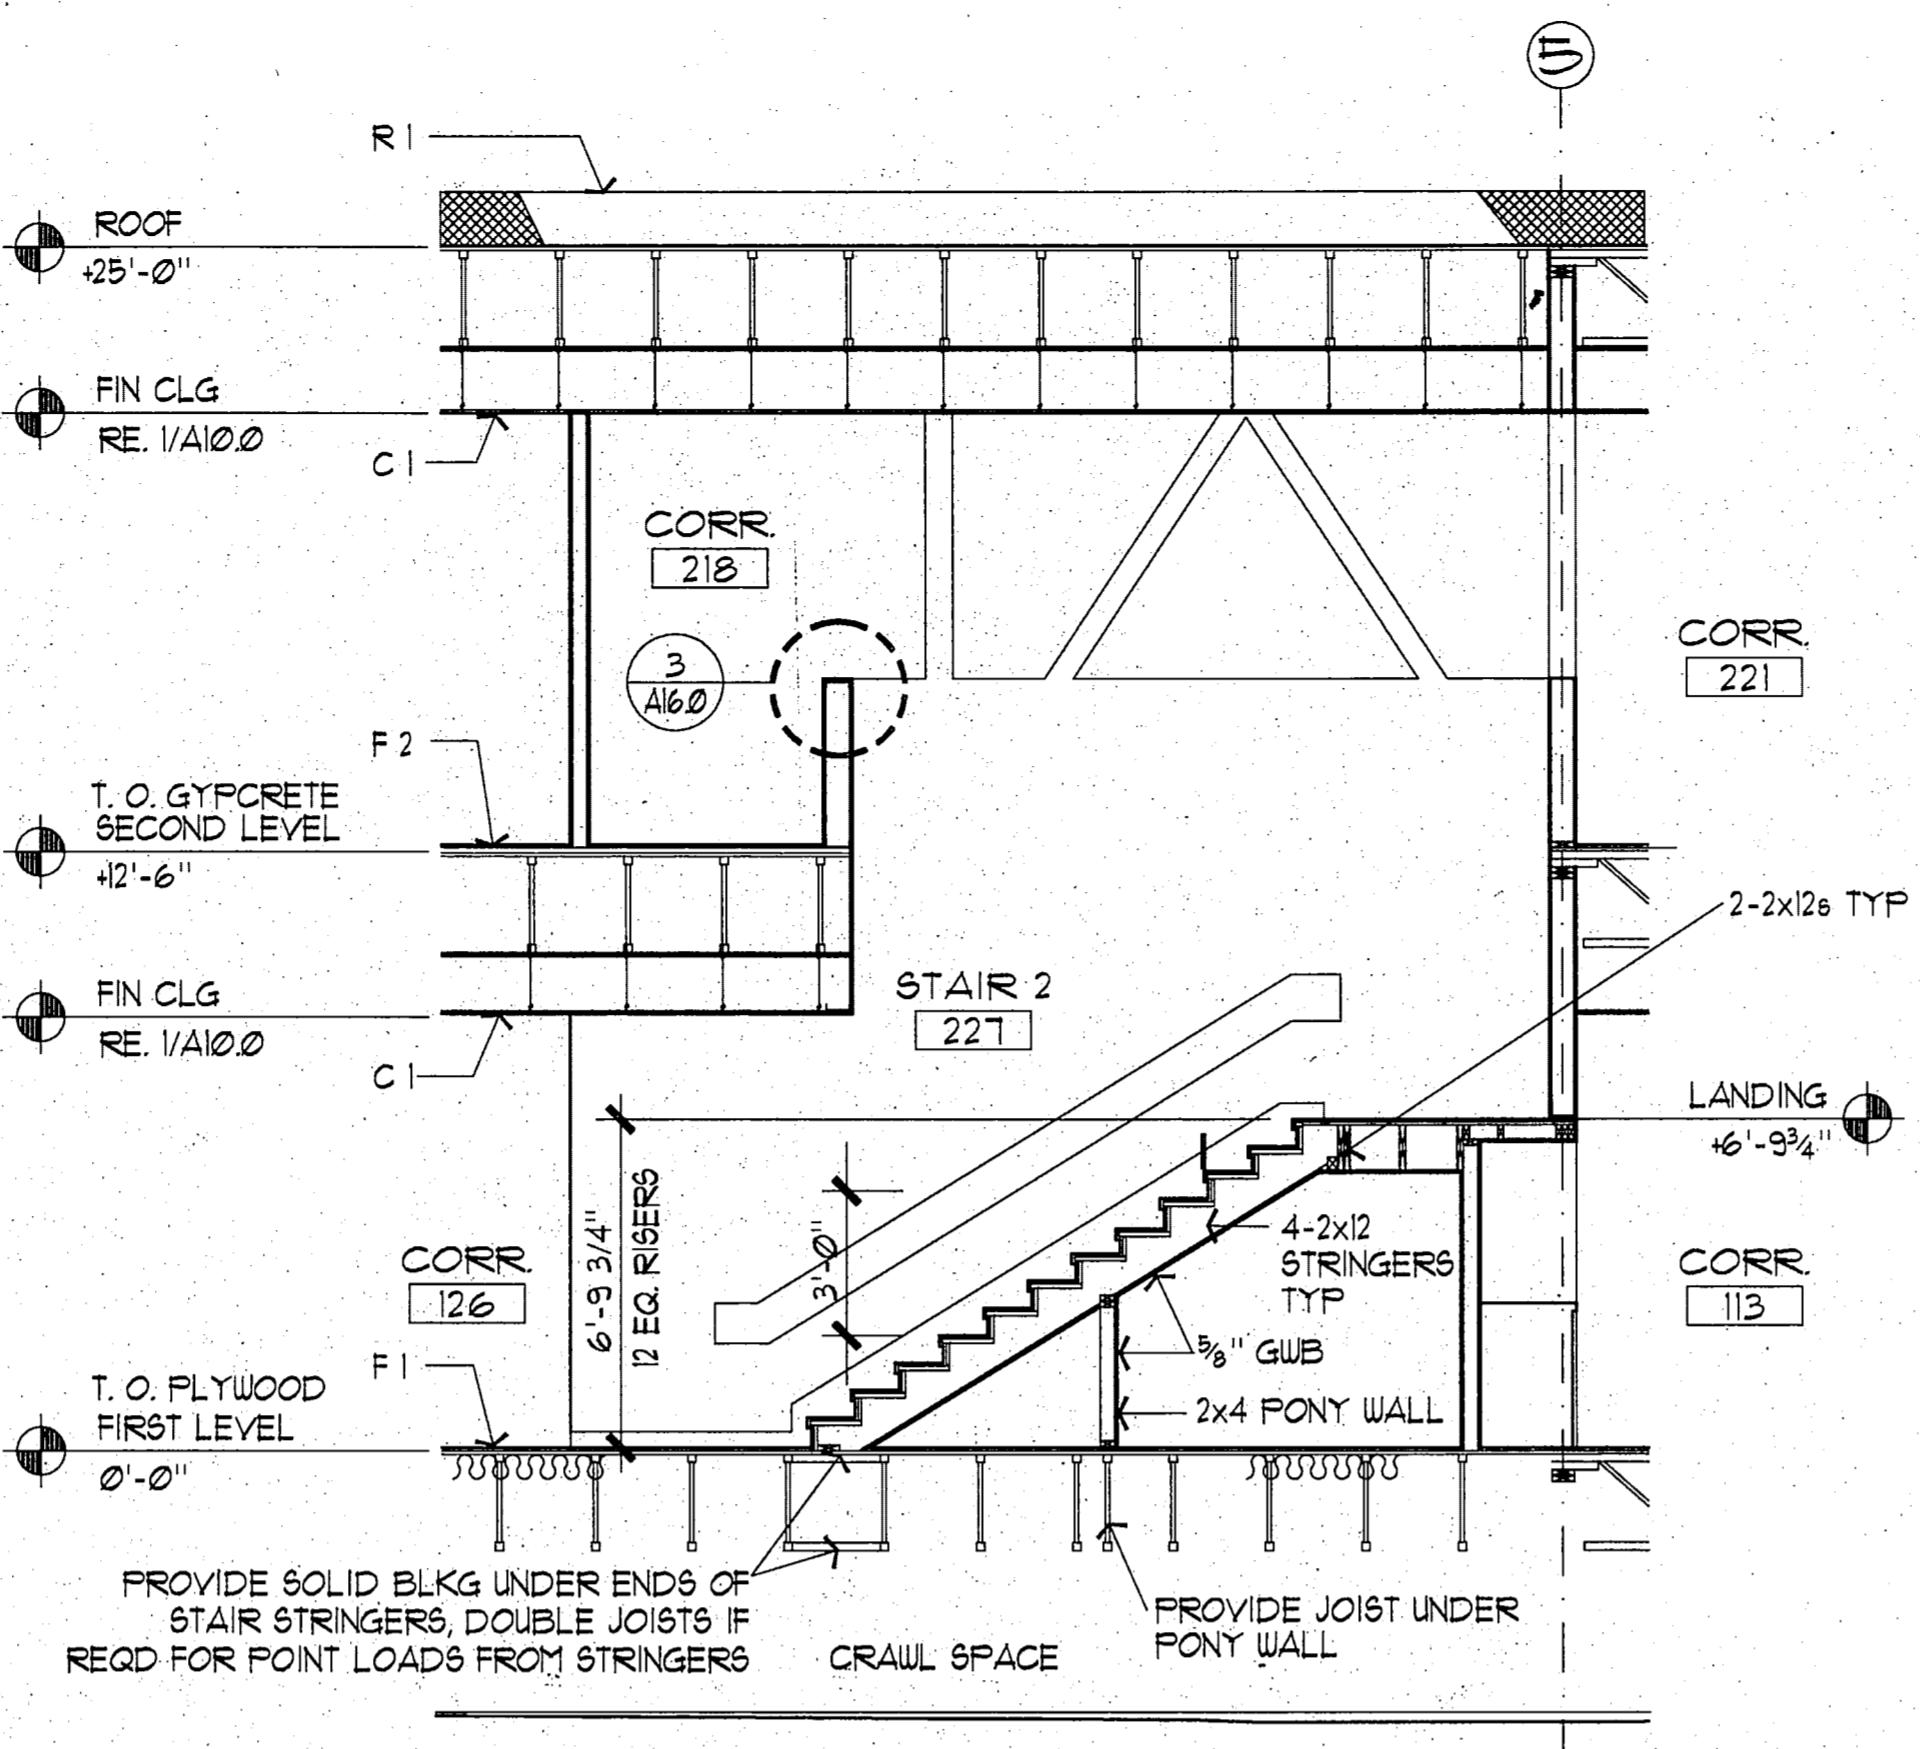


11 SECTION - STAIR 2

SCALE: 1/4" = 1'-0"

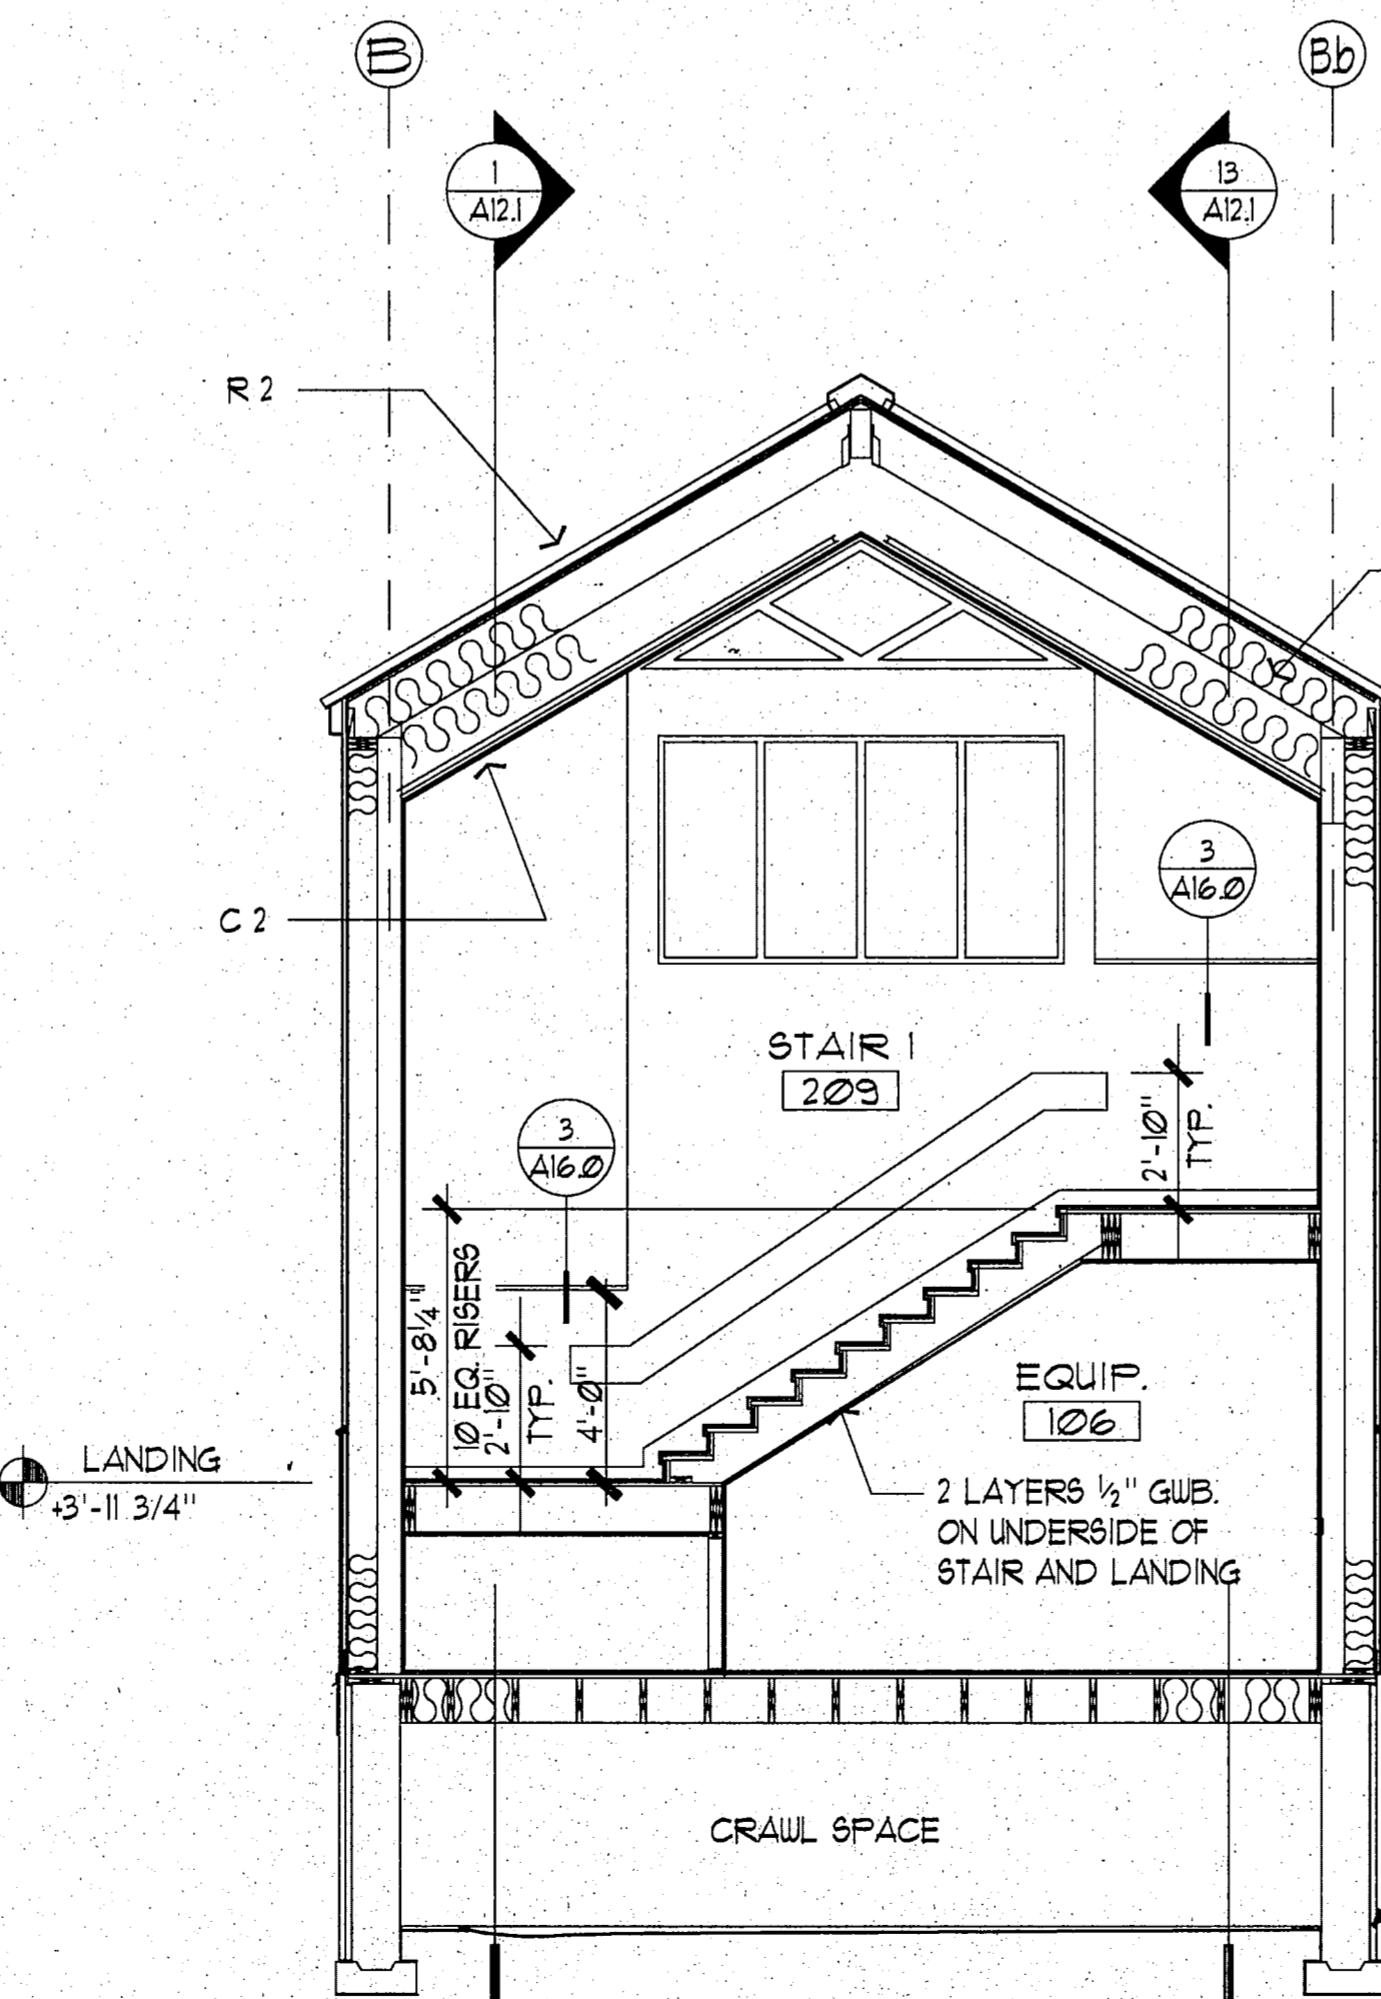

10 SECTION - STAIR 1

SCALE: 1/4" = 1'-0"

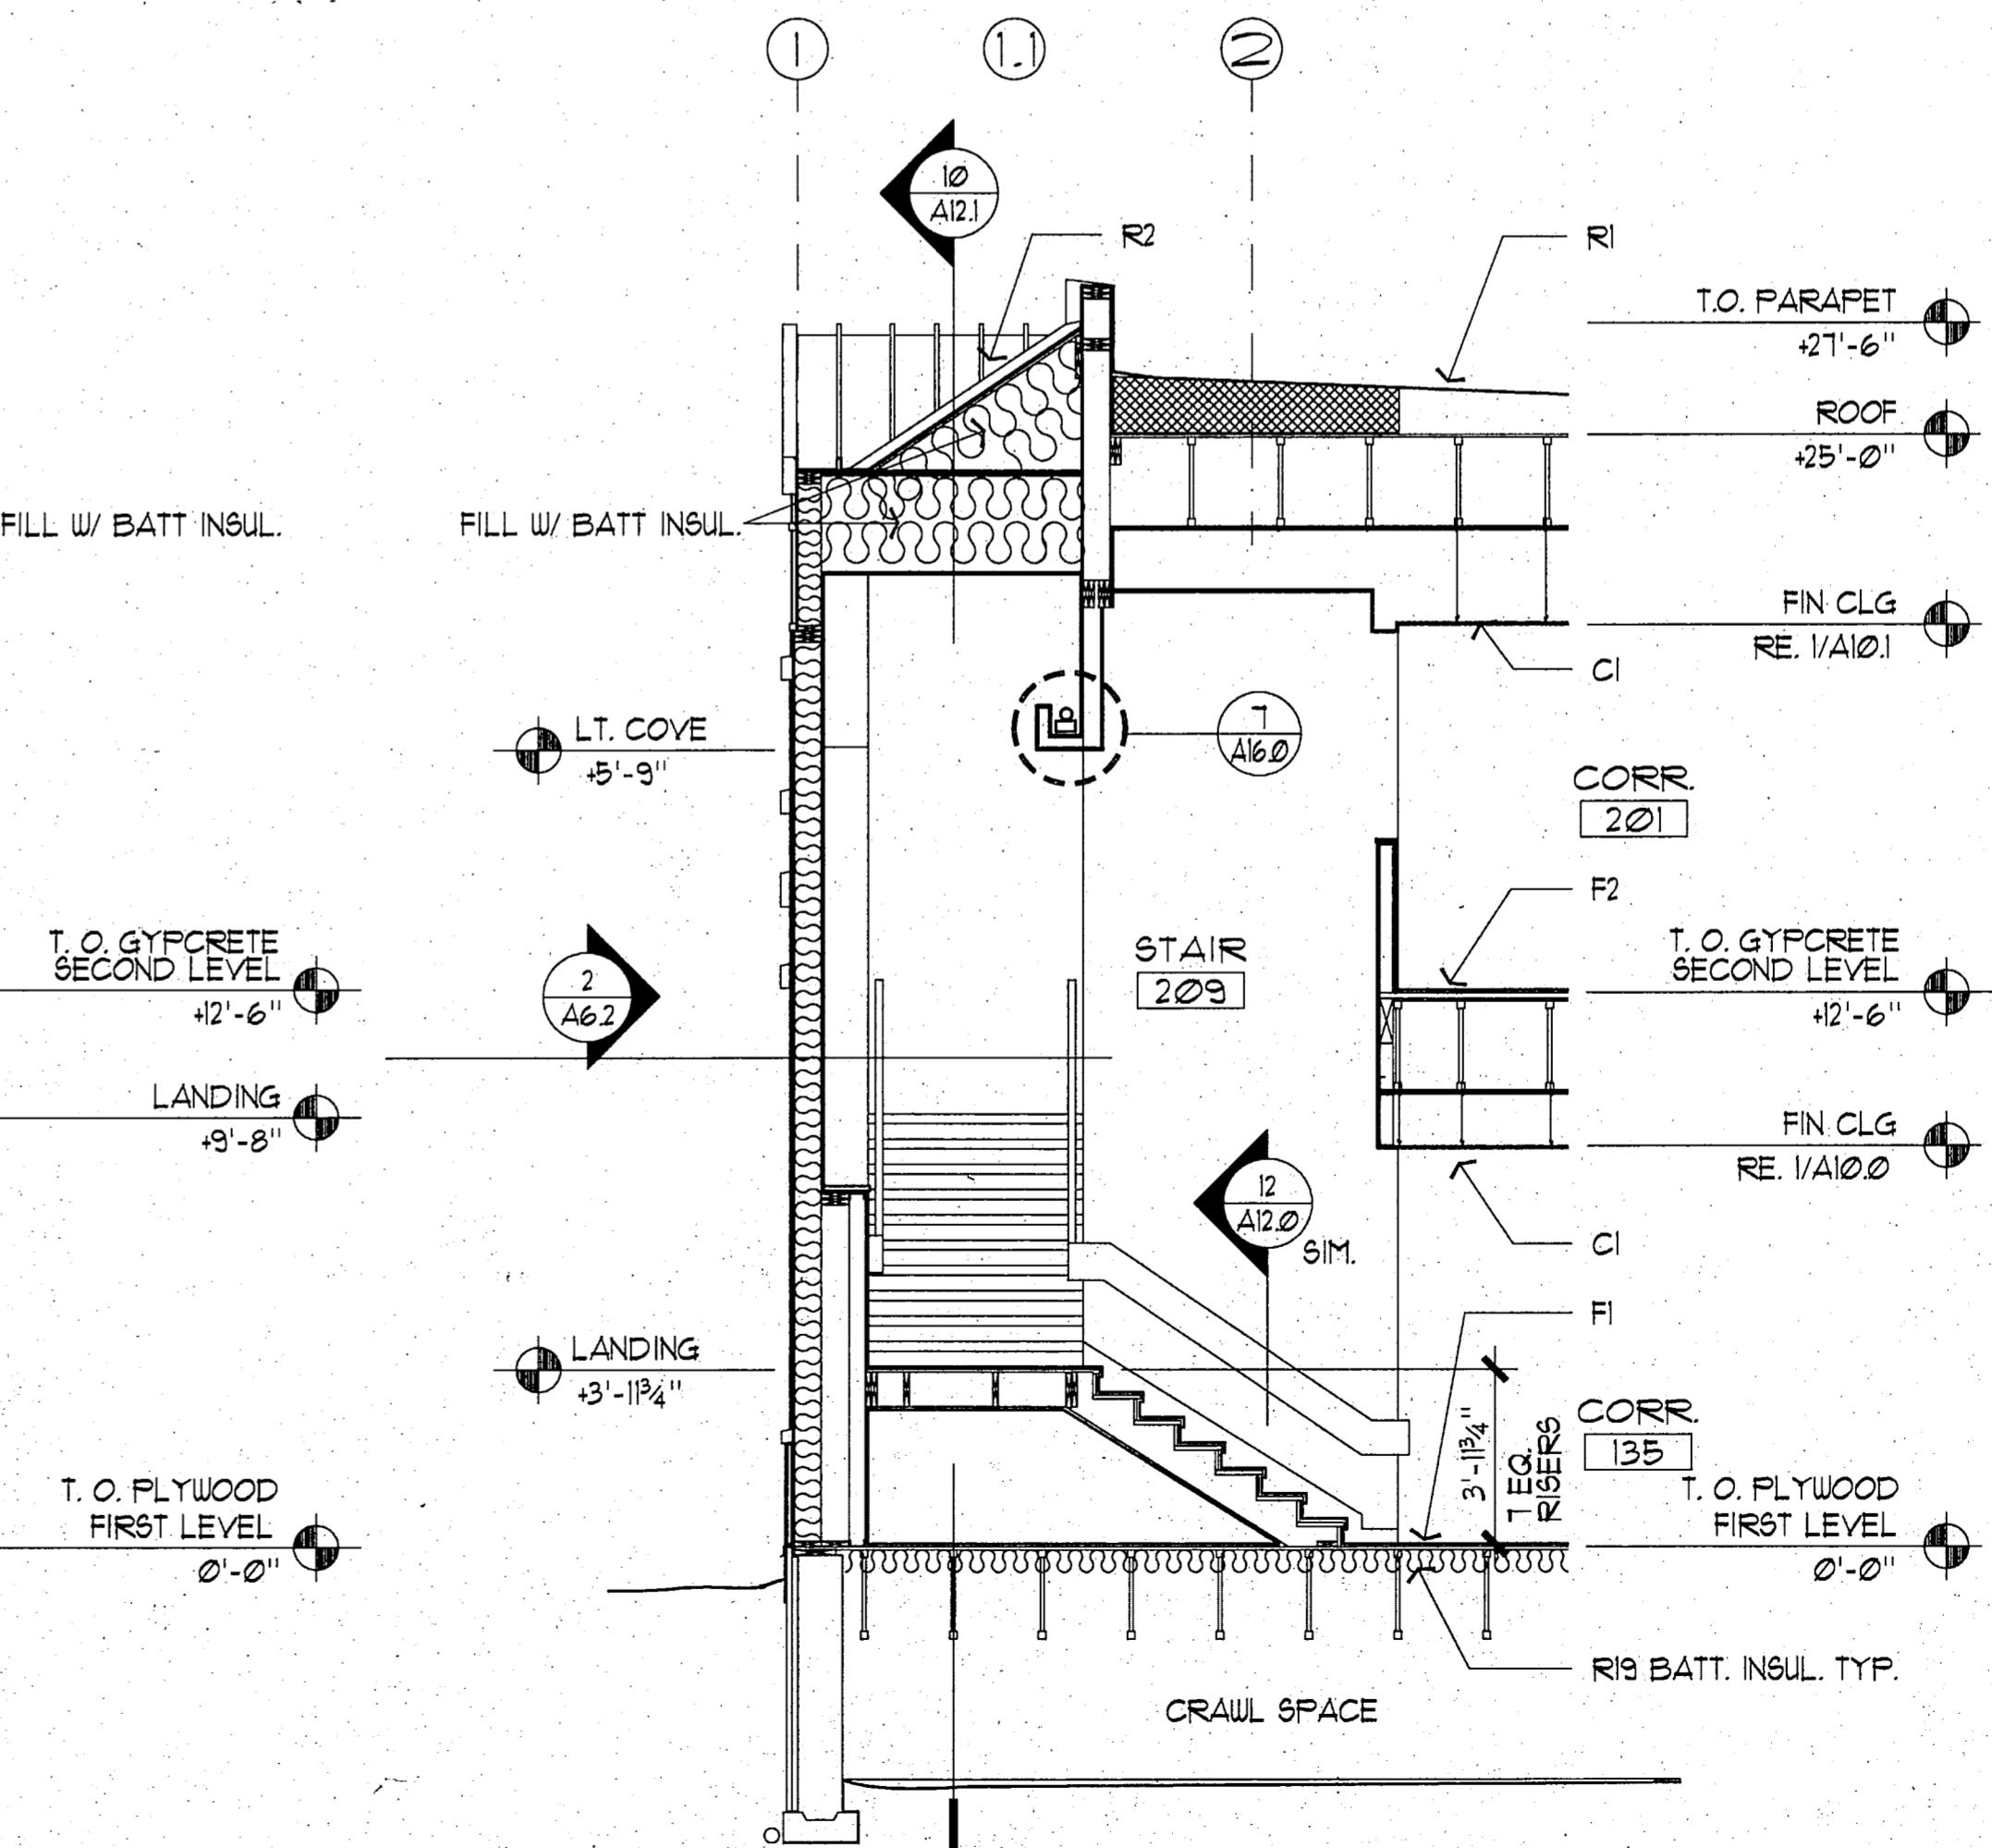

1 SECTION - STAIR 1

SCALE: 1/4" = 1'-0"

**LIVINGSTON**  
Architecture Engineering  
Interior Design Planning  
Incorporated

3900 Arctic Blvd. Suite 301  
Anchorage, Alaska 99503-5790  
(907) 566-2056



PROJECT NO. 115.00  
DRAWN BY JB, AS, OM  
CHECKED BY JB, JA  
DATE DEC. 9, 1992  
REVISED

TITLE  
**STAIR  
SECTIONS/  
DETAILS**

SHEET NO.

**A12.1**



**FAIRBANKS HEALTH CENTER**

**LIVINGSTON STONE** Architecture Engineering Interior Design Planning Incorporated

3900 Arctic Blvd. Suite 301  
Anchorage, Alaska 99503-5790  
(907) 563-2050



PROJECT NO. 115.00

DRAWN BY: ALS

CHECKED BY: JB, JA

DATE: DEC 9, 1992






REVISED

TITLE:  
**WALL FLOOR  
AND CEILING  
TYPES**


SHEET NO.

**A14.0**


F 3.0062

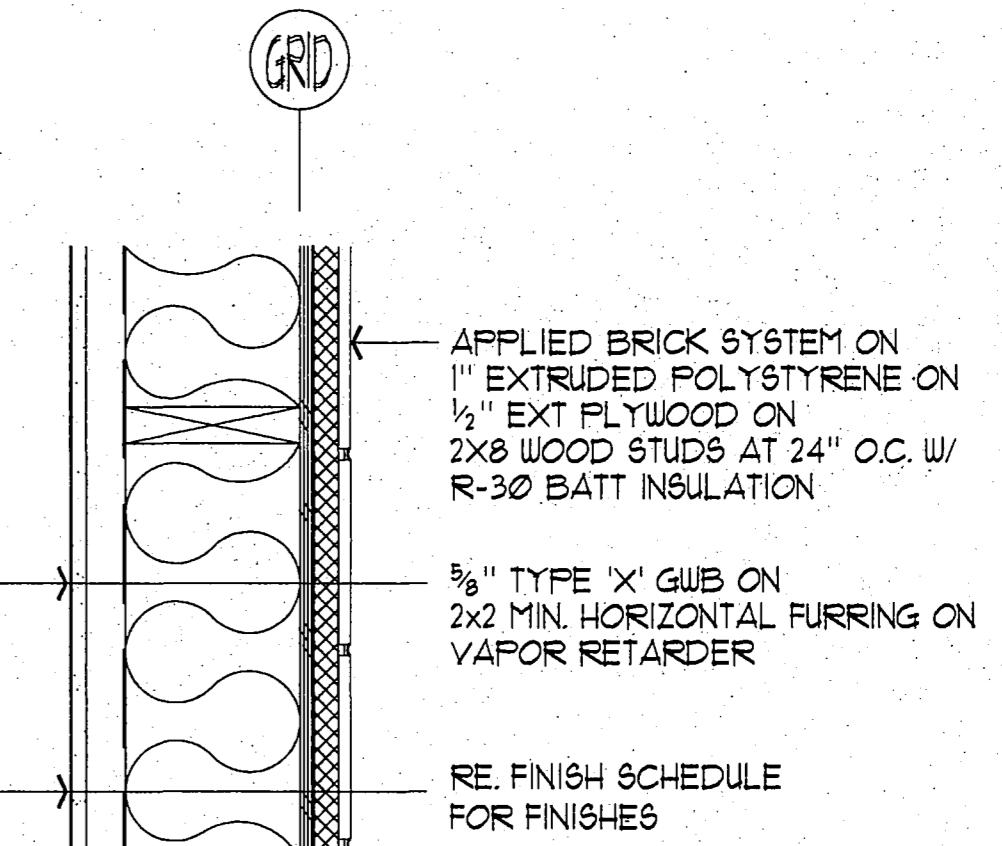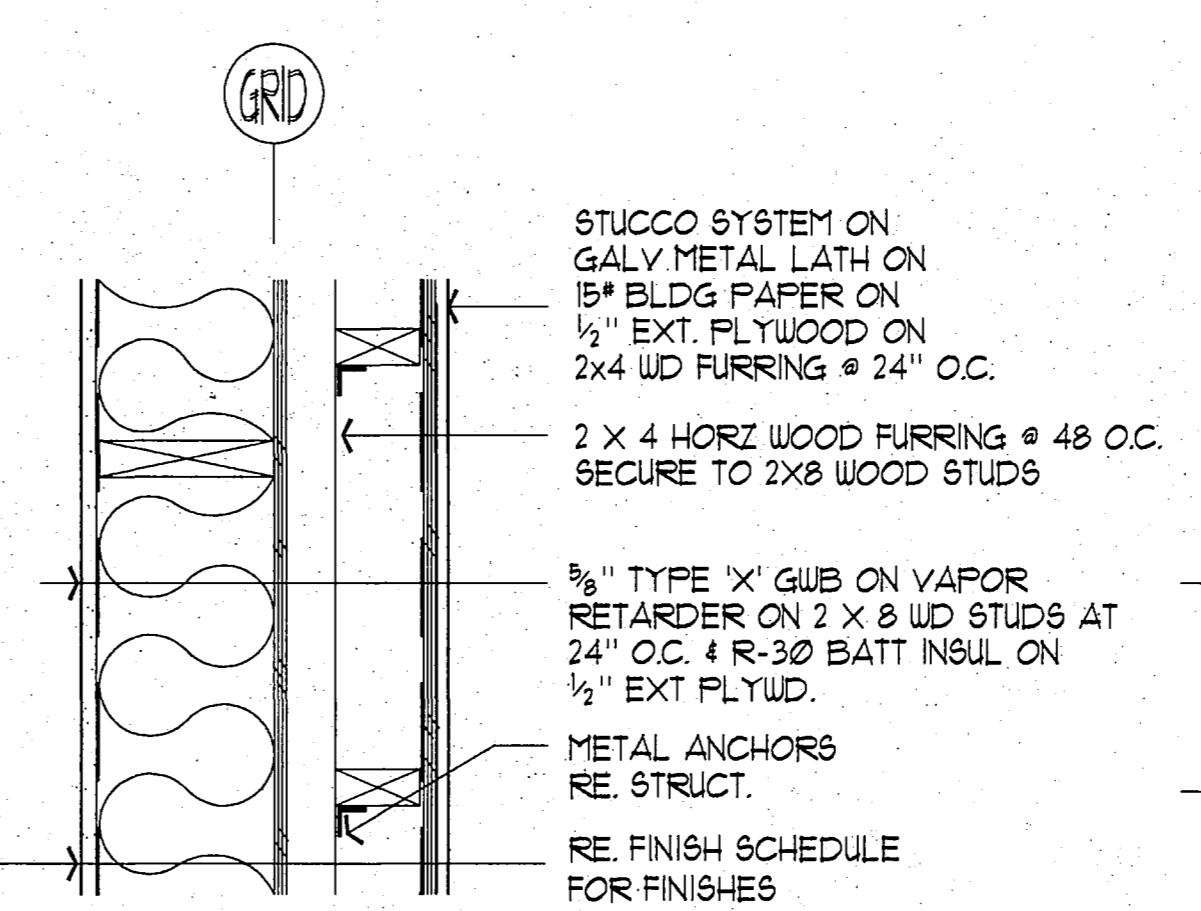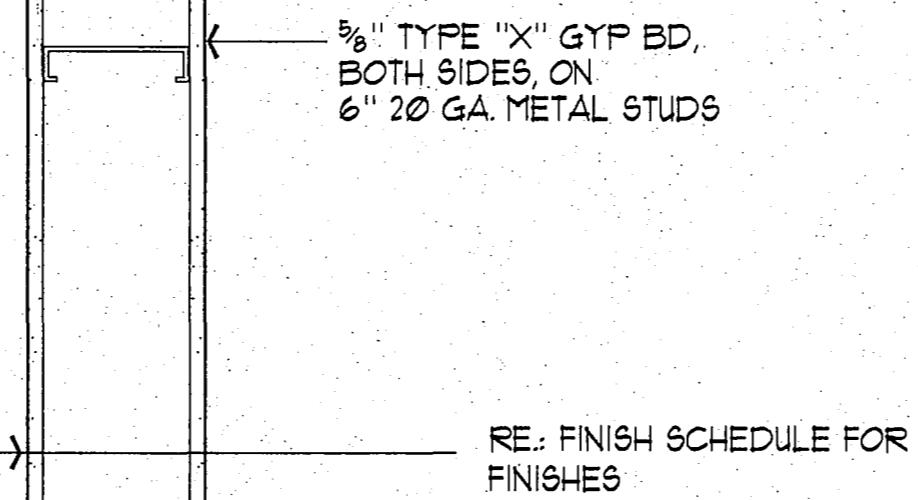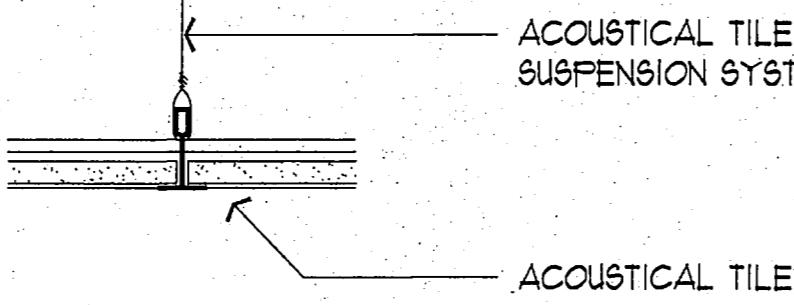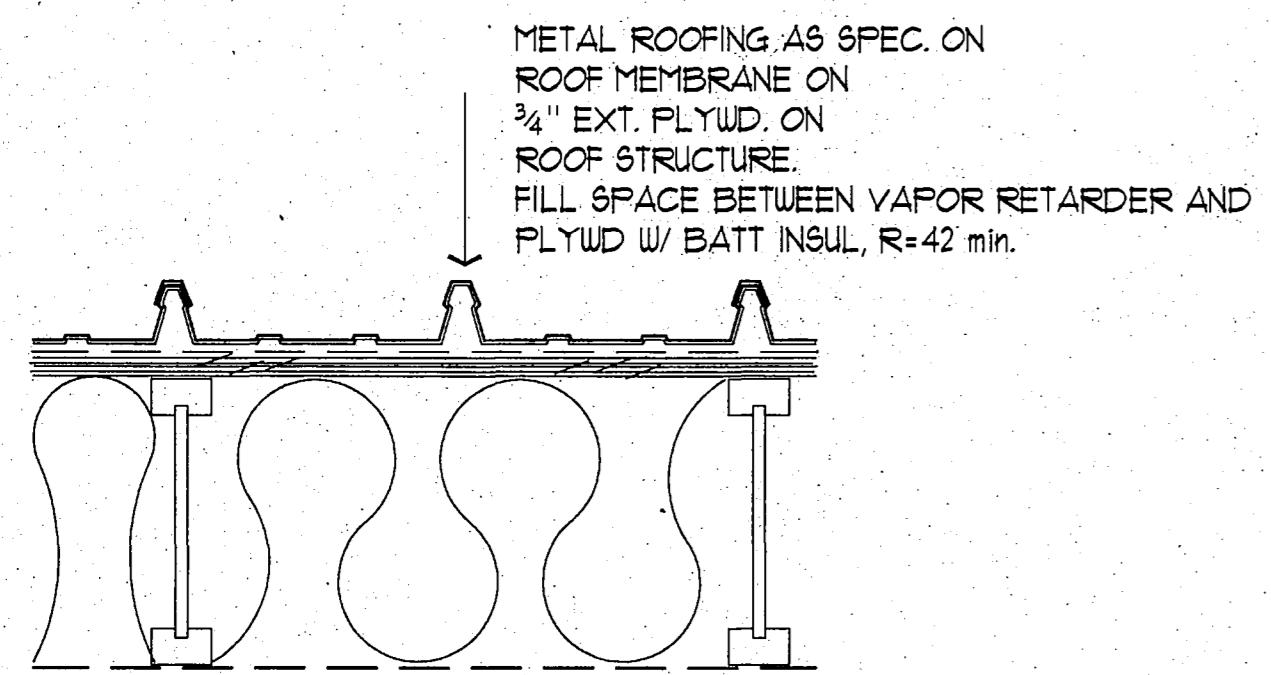


**15 ROOF TYPE - R2**  
SCALE:  $\frac{1}{2}$ " = 1'-0"

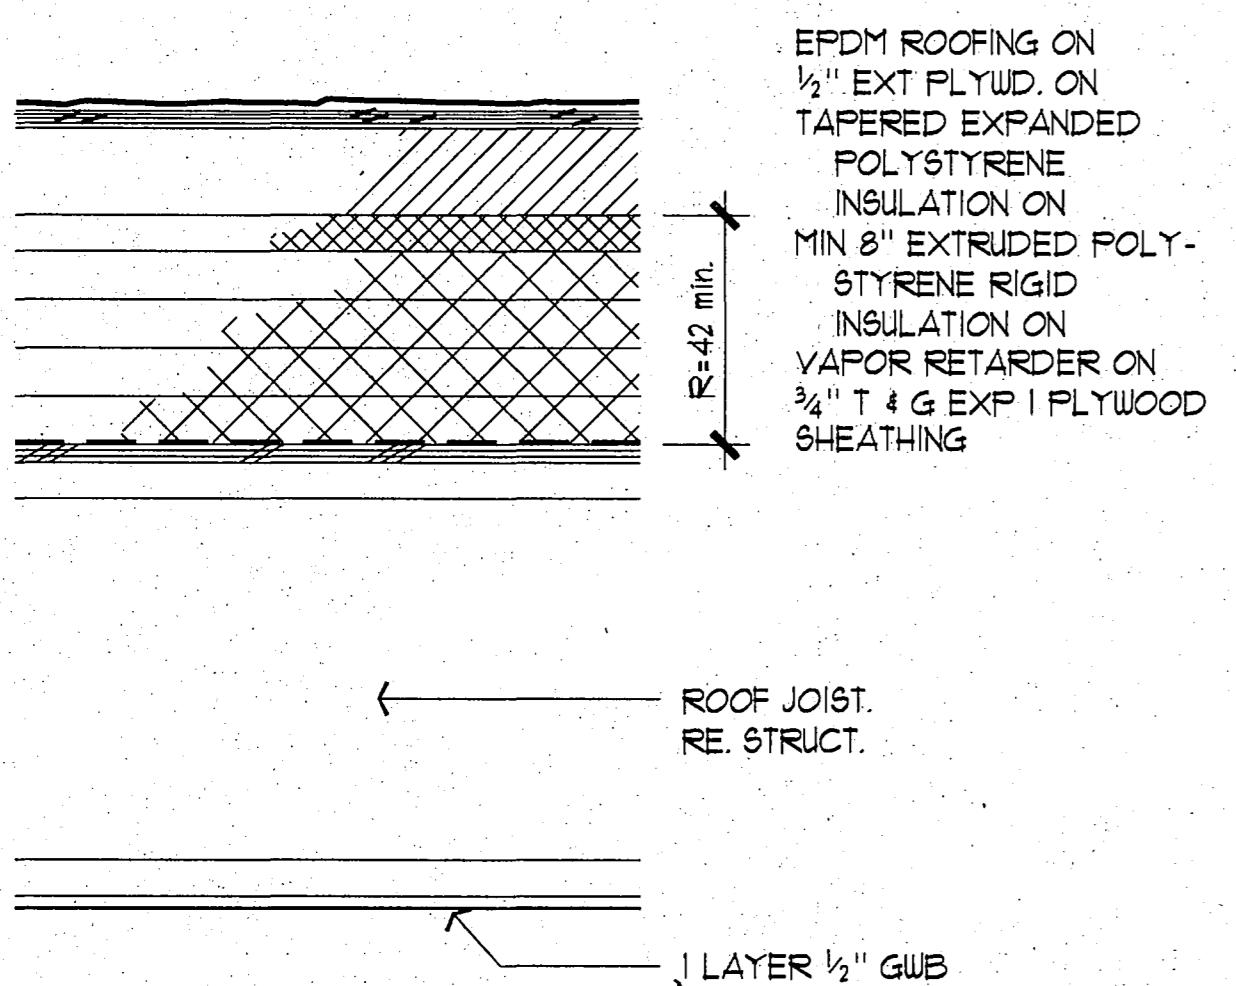


**12 CEILING TYPE - C1**  
SCALE: 3" = 1'-0"

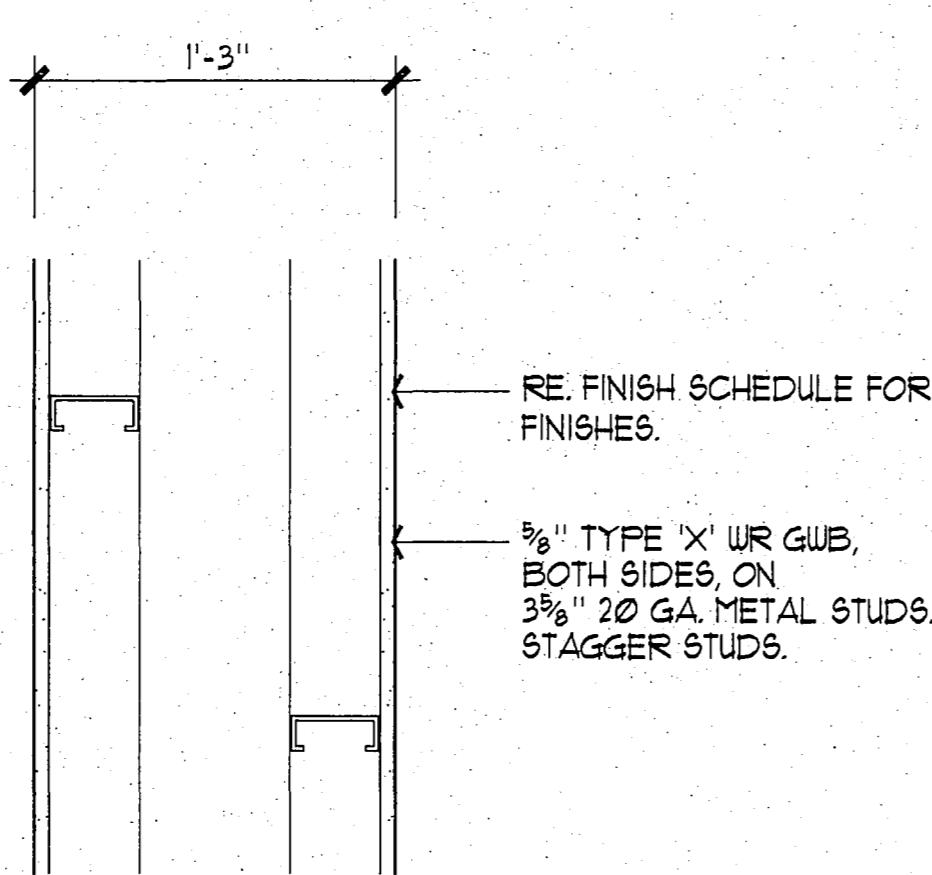


**9 WALL TYPE - W1**  
SCALE:  $\frac{1}{2}$ " = 1'-0"

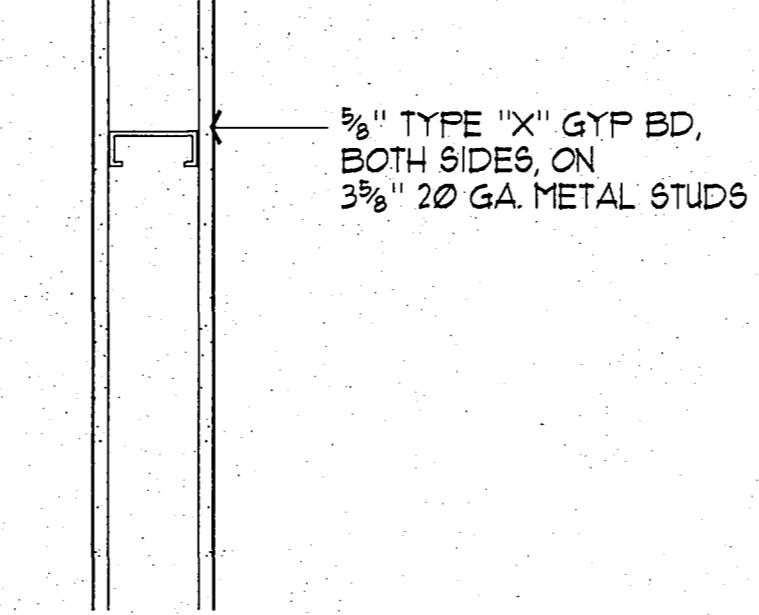


**6 WALL TYPE - W4**  
SCALE:  $\frac{1}{2}$ " = 1'-0"

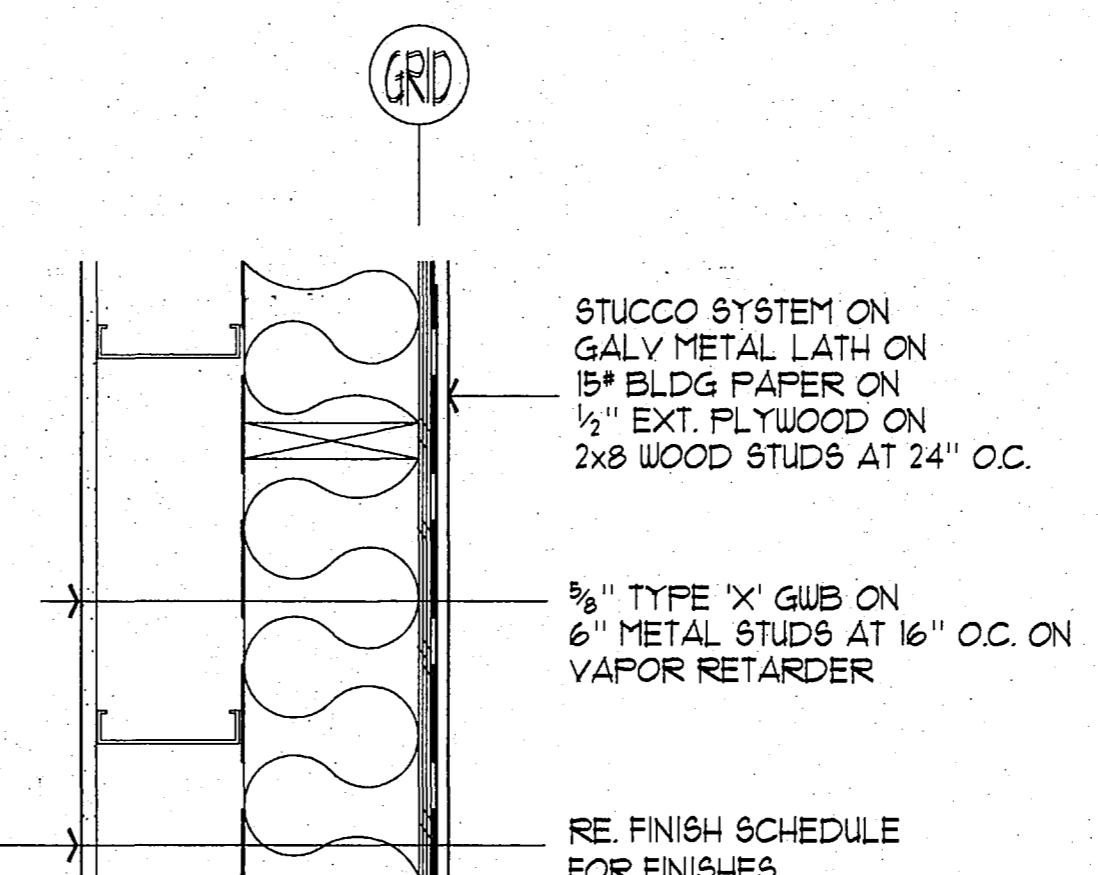


**3 WALL TYPE - W1**  
SCALE:  $\frac{1}{2}$ " = 1'-0"

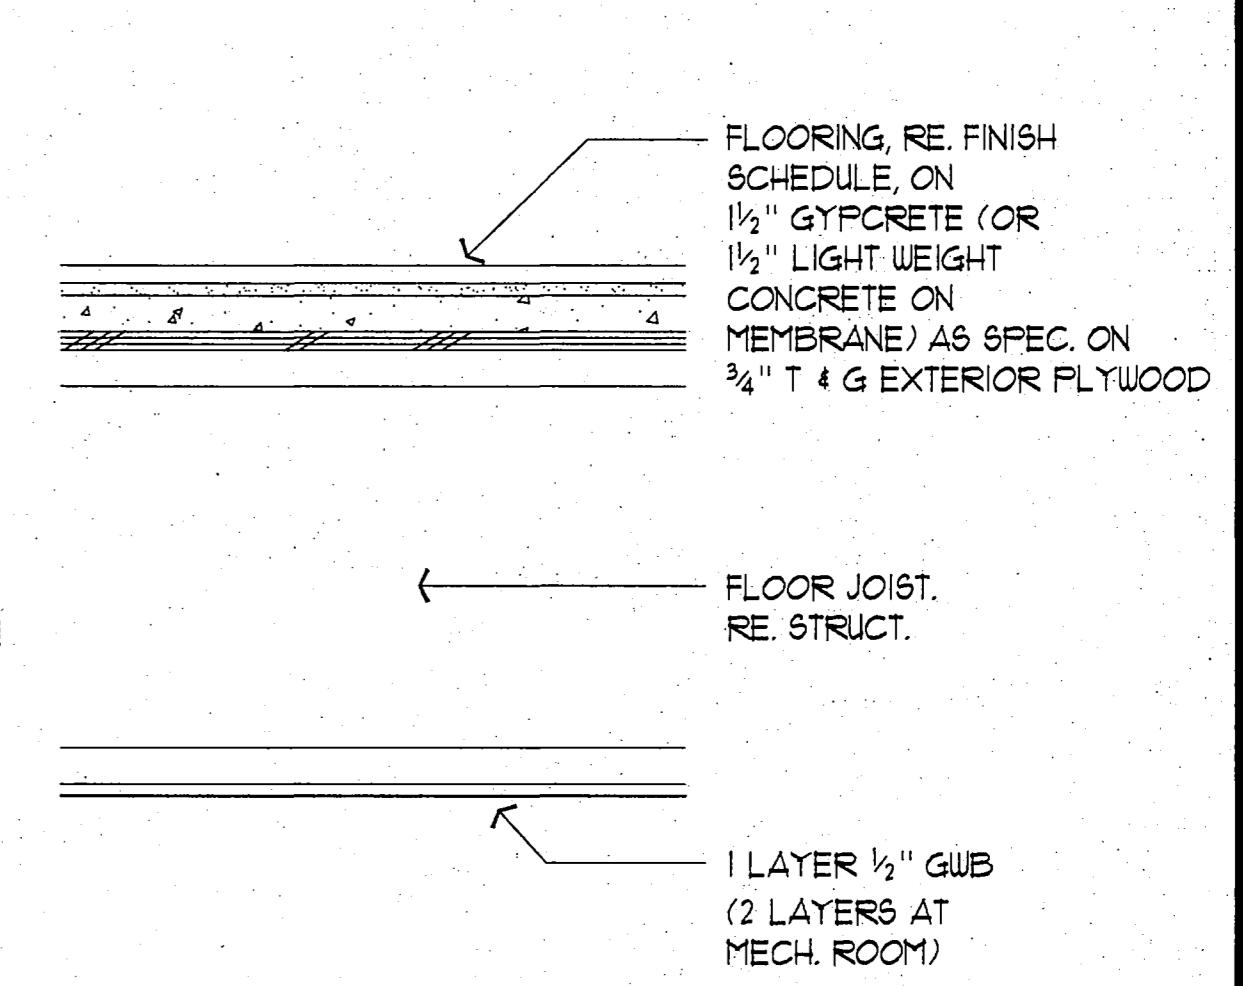


**14 ROOF TYPE - RI**  
SCALE:  $\frac{1}{2}$ " = 1'-0"

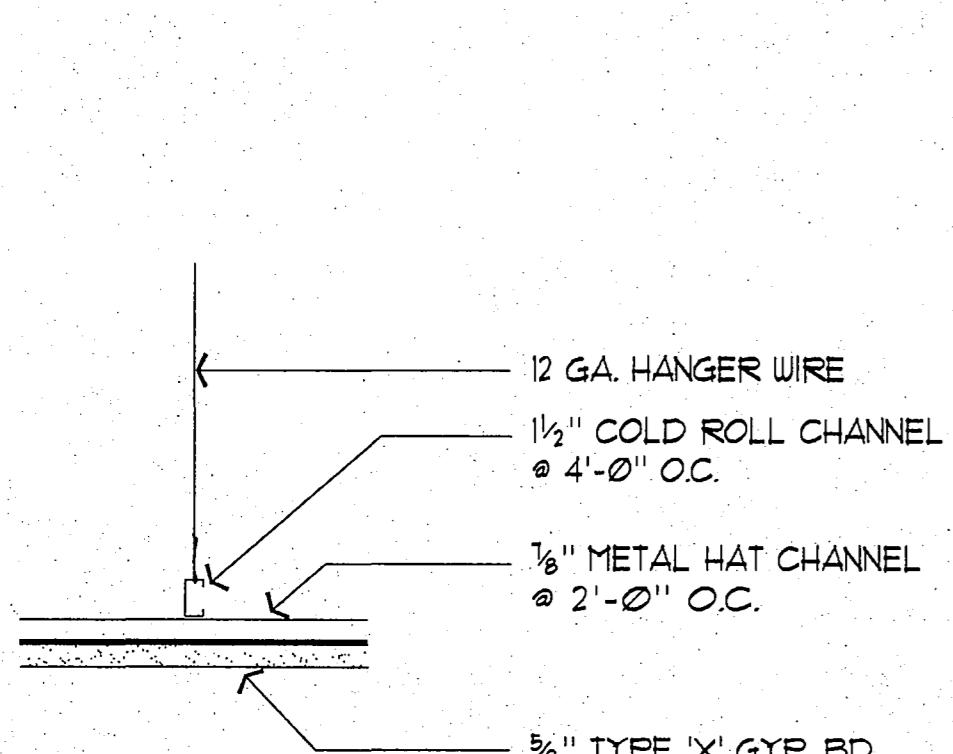


**11 WALL TYPE - W9**  
SCALE:  $\frac{1}{2}$ " = 1'-0"

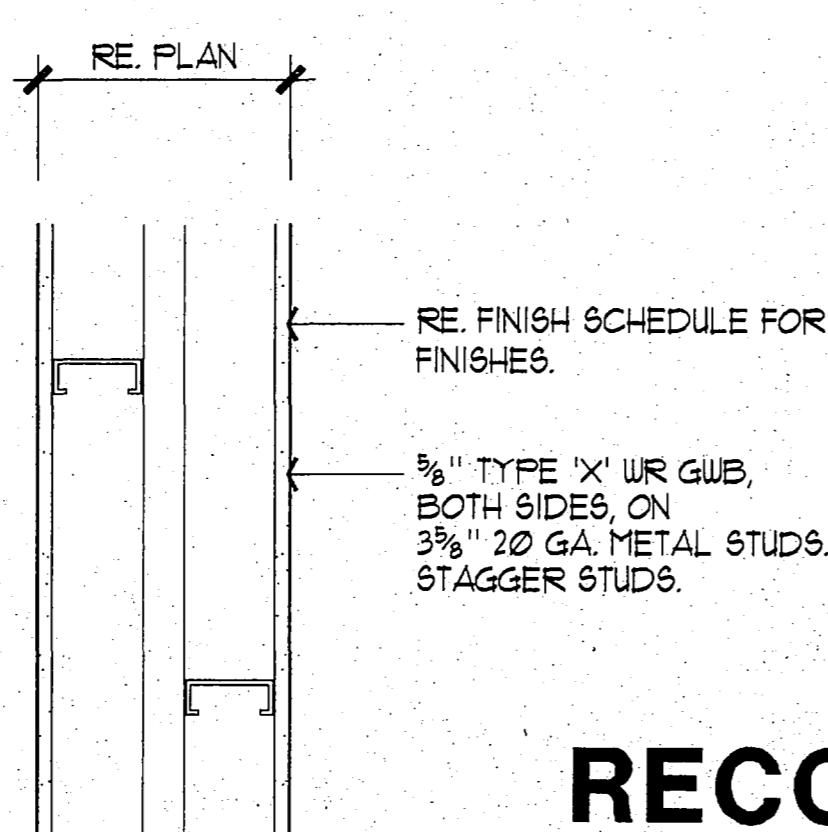


**8 WALL TYPE - W6**  
SCALE:  $\frac{1}{2}$ " = 1'-0"

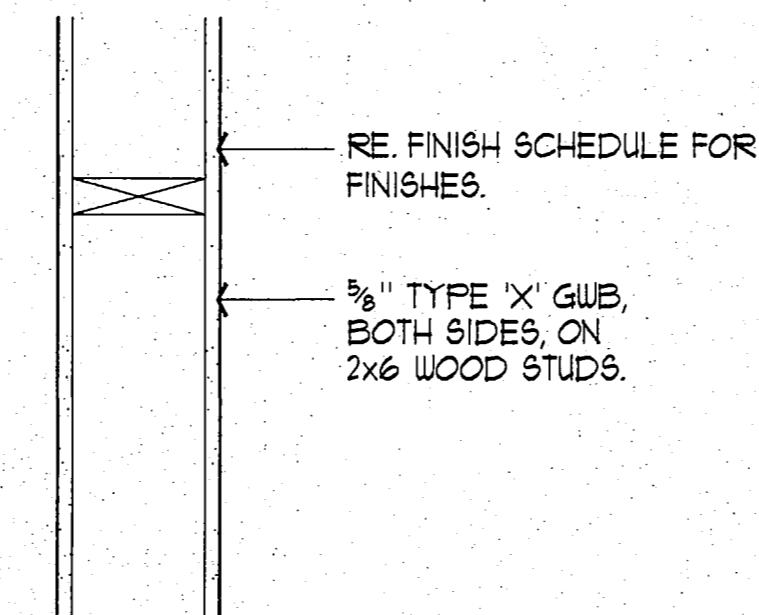

**5 WALL TYPE - W3**  
SCALE:  $\frac{1}{2}$ " = 1'-0"

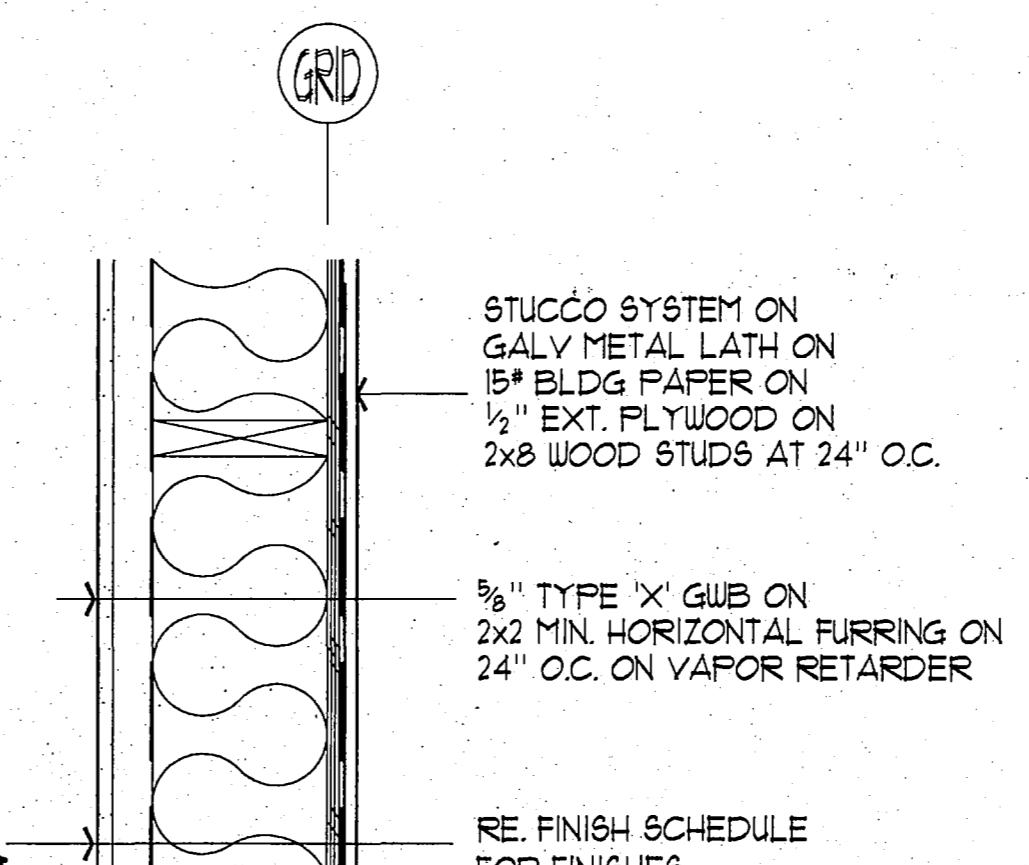

**2 FLOOR TYPE - F2**  
SCALE:  $\frac{1}{2}$ " = 1'-0"

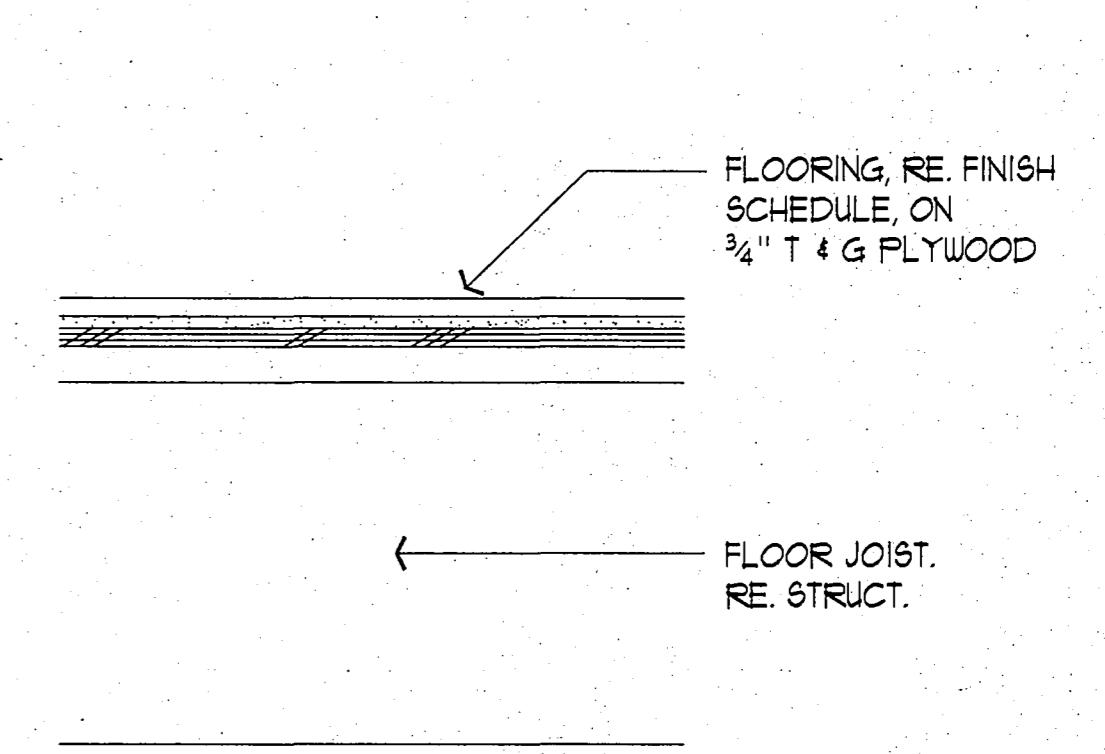

**RECORD  
DRAWING**

*John B. Bensel*  
CITY ENGINEER, CITY OF FAIRBANKS

DATE 9/8/96

**13 CEILING TYPE - C2**  
SCALE: 3" = 1'-0"

**10 WALL TYPE - W8**  
SCALE:  $\frac{1}{2}$ " = 1'-0"

**7 WALL TYPE - W5**  
SCALE:  $\frac{1}{2}$ " = 1'-0"

**4 WALL TYPE - W2**  
SCALE:  $\frac{1}{2}$ " = 1'-0"

**1 FLOOR TYPE - F1**  
SCALE:  $\frac{1}{2}$ " = 1'-0"

- NOTE:  
1. SUBSTITUTE  $\frac{1}{2}$ " WR GUB FOR  $\frac{1}{2}$ " TYPE 'X' GUB AT TOILET ROOMS  
2. DELETE 2x2 MIN. HORIZONTAL FURRING AT SIM.



# RECORD DRAWING

*Rufus B. Beach*  
CITY ENGINEER, CITY OF FAIRBANKS


4/8/96

- NOTES
- MATERIALS AND INSTALLATION OF SUSPENDED CEILING SYSTEMS SHALL COMPLY WITH SECTION 41, 1991 UBC, AND APPLICABLE PROVISIONS OF UBC STANDARDS FOR HEAVY-DUTY SYSTEM.
  - SUSPENDED CEILING BRACING NOT REQUIRED IN ROOMS UNDER 144 SQ. FT. FLOOR AREA, PER UBC.


(1) SUSPENDED CEILING SEISMIC BRACING  
SCALE: NONE

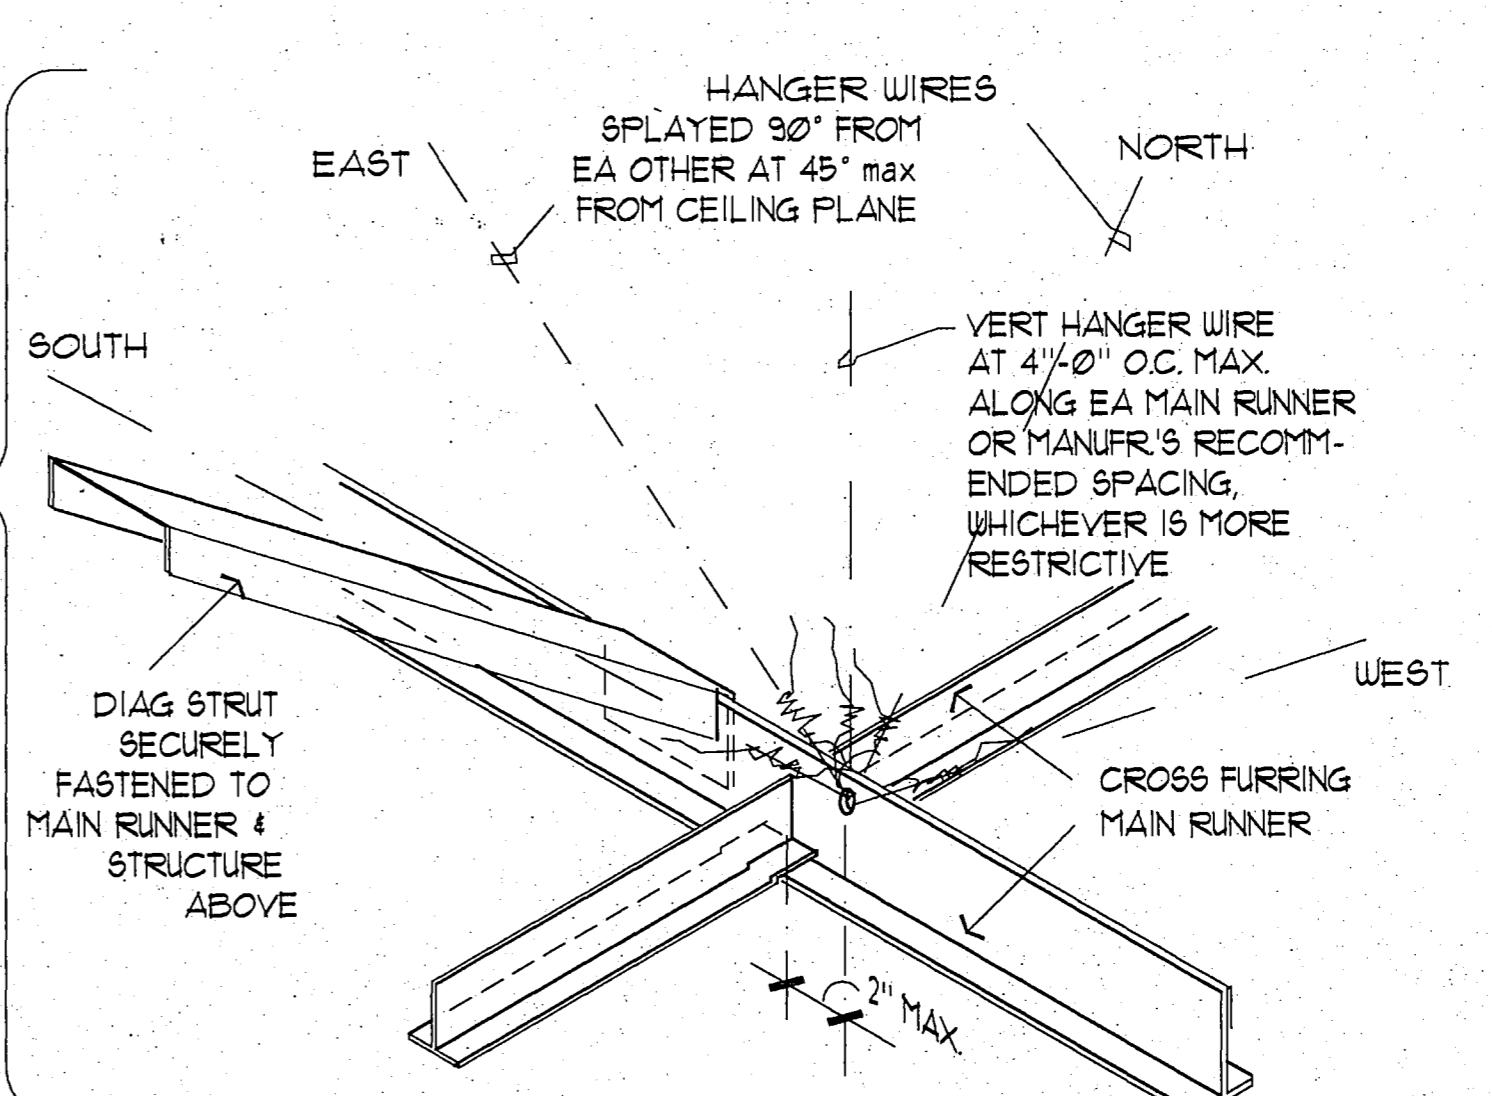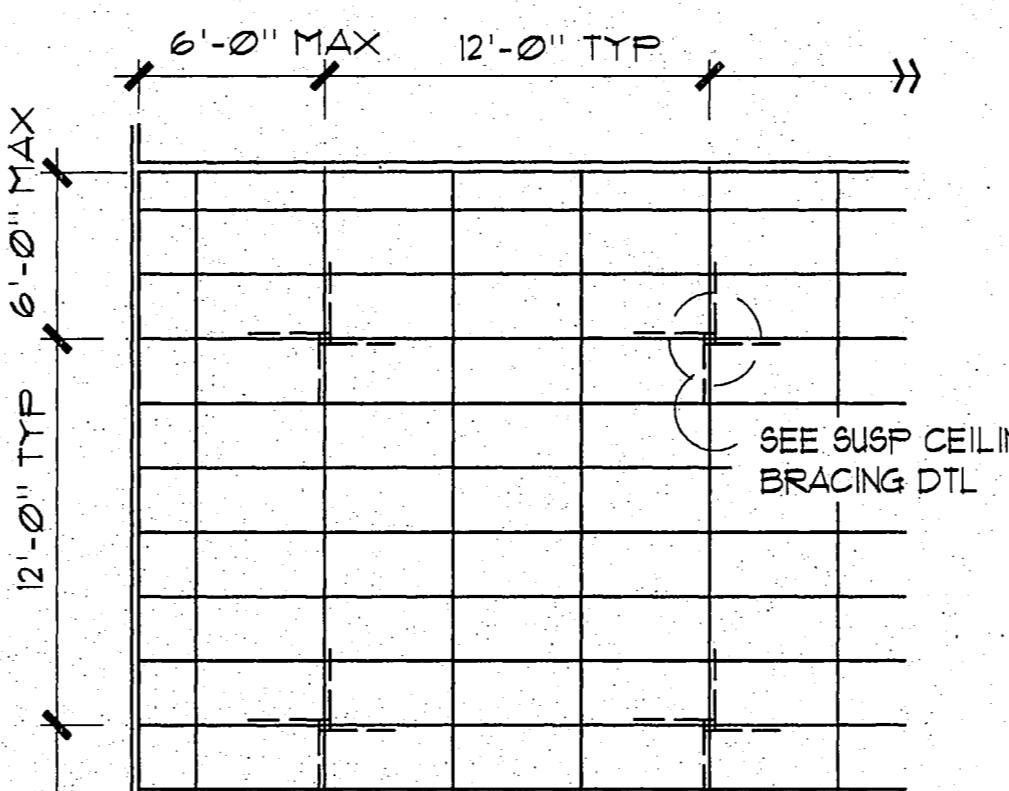


(2) DETAIL AT PARTITION  
SCALE: 1/2" = 1'-0"

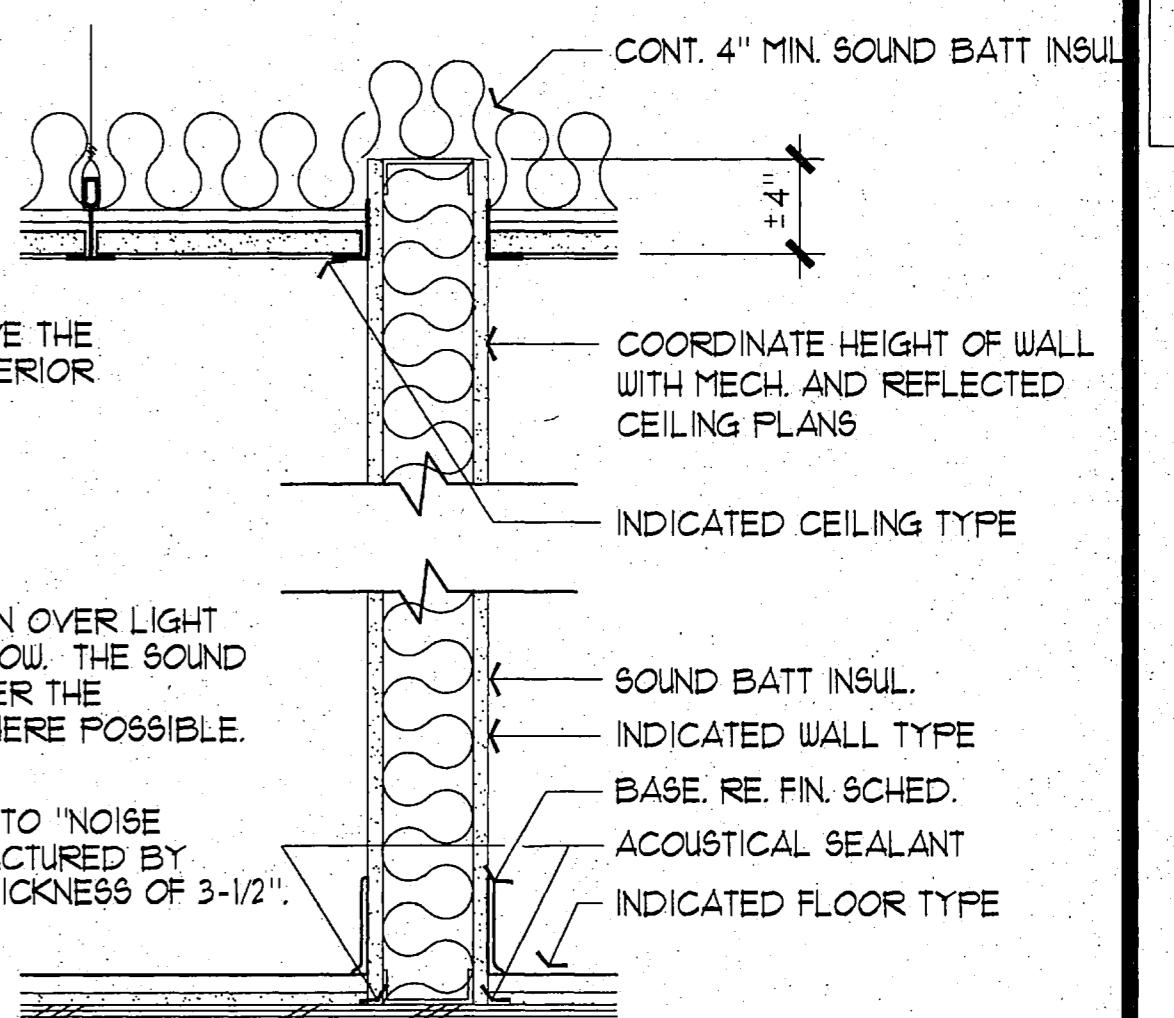

(3) TOP OF WALL  
SCALE: 3" = 1'-0"

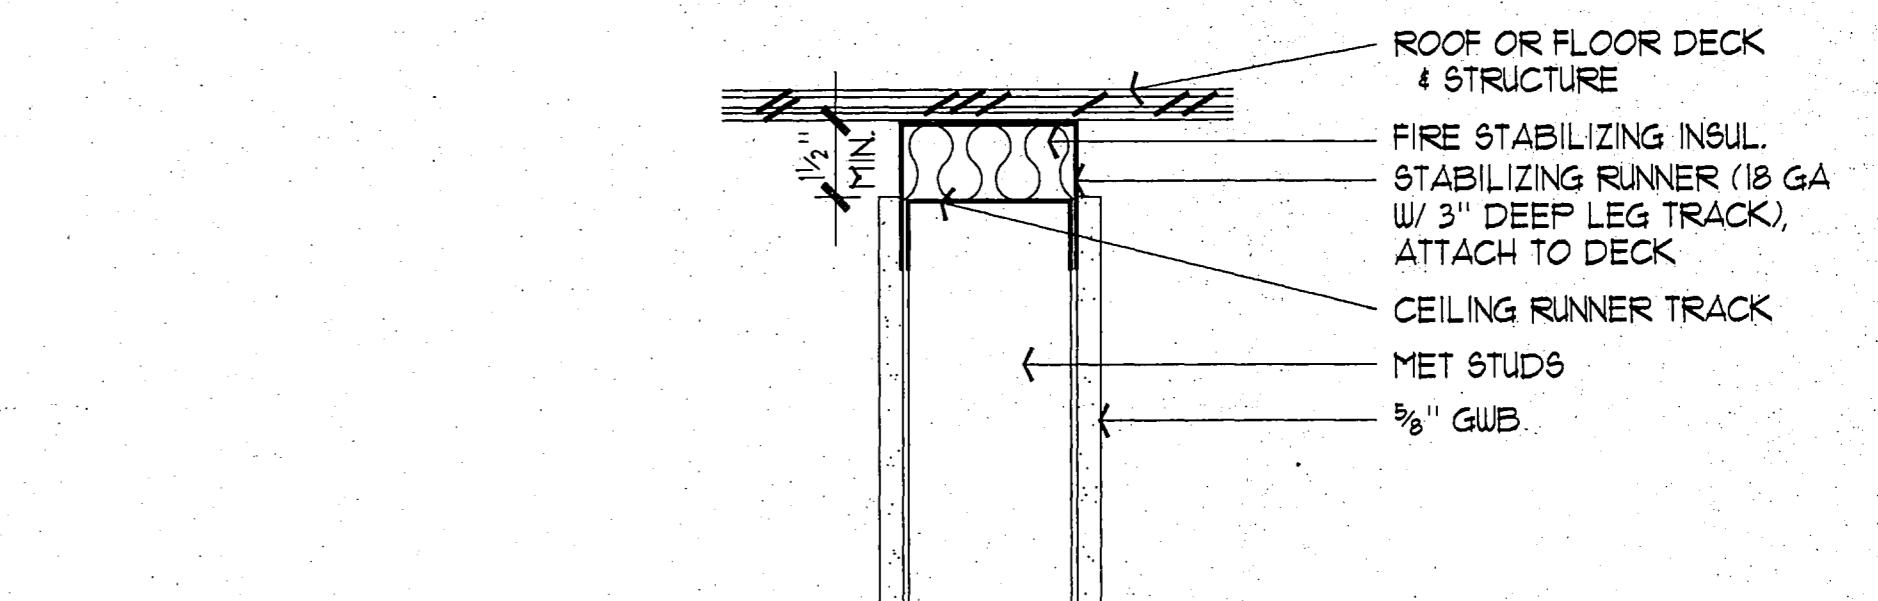

NOTE:  
LEAVE PARTITION FREE  
TO MOVE VERTICALLY AT  
CEILING RUNNER

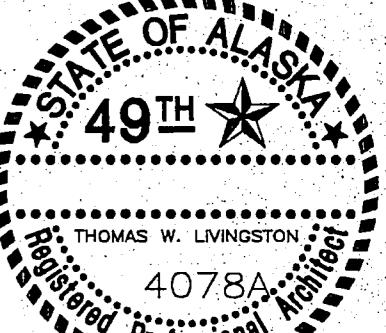

PROJECT NO. 115.00

DRAWN BY JB

CHECKED BY JB, JA

DATE DEC. 9, 1992

REVISED

TITLE  
PARTITION  
DETAILS

SHEET NO.

A14.1

CITY OF FAIRBANKS  
FAIRBANKS HEALTH CENTER  
Fairbanks, Alaska

LIVINGSTON STONE

Architecture Engineering  
Interior Design Planning

3900 Arctic Blvd. Suite 301  
Anchorage, Alaska 99503-5790  
(907) 562-2036

# DOOR SCHEDULE

## FIRST FLOOR

DOOR NUMBER	LOCATION	ROOM NO.	DOOR		FRAME		HEAD DETAIL	JAMB DETAIL	THRSHD DETAIL	FIRE RATING	HARDWARE	REMARKS		
			DR TYPE	WIDTH	HEIGHT	THICKNESS	CONSTR.	FINISH						
100A	VESTIBULE 1	100	A	3'-0"	7'-0"	1 3/4"	MTL	PT	12/A15.1	10/A15.1	NR	1	3	
100B	VESTIBULE 1	100	A	3'-0"	7'-0"	1 3/4"	MTL	PT	9/A15.1	6/A15.1	11/A15.1	NR	2	3
101A	LOBBY	101	C	3'-0"	7'-0"	1 3/4"	SC	ST	9/A15.1	6/A15.1	-	NR	3	
103A	MEN'S TOILET	103	C	3'-0"	7'-0"	1 3/4"	SC	ST	9/A15.1	6/A15.1	8/A15.1	20 MIN	4	
104A	WOMEN'S TOILET	104	C	3'-0"	7'-0"	1 3/4"	SC	ST	9/A15.1	6/A15.1	8/A15.1	20 MIN	4	
105A	WAITING AREA	105	C	3'-0"	7'-0"	1 3/4"	SC	ST	9/A15.1	6/A15.1	-	20 MIN	5	3, 5
105B	WAITING AREA	105	C	3'-0"	7'-0"	1 3/4"	SC	ST	9/A15.1	6/A15.1	-	20 MIN	7	3, 5
106A	ELEVATOR EQUIPMENT	106	C	3'-0"	7'-0"	1 3/4"	SC	ST	9/A15.1	6/A15.1	-	NR	6	
107A	CONFERENCE ROOM	107	C	2'-6"	7'-0"	1 3/4"	SC	ST	9/A15.1	6/A15.1	-	NR	8	3
107B	CONFERENCE ROOM	107	C	2'-6"	7'-0"	1 3/4"	SC	ST	9/A15.1	6/A15.1	-	NR	9	3
107C	CONFERENCE ROOM	107	C	2'-6"	7'-0"	1 3/4"	SC	ST	9/A15.1	6/A15.1	-	NR	9	3
107E	CONFERENCE ROOM	107	E	34'-0"	9'-0"	-	-	-	10/A15.1	-	-	NR	10	1, 7
110A	CORRIDOR	110	B	3'-0"	7'-0"	1 3/4"	SC	ST	9/A15.1	6/A15.1	8/A15.1	NR	12	
110B	CORRIDOR	110	C	2'-6"	7'-0"	1 3/4"	SC	ST	9/A15.1	6/A15.1	-	20 MIN	11	5, 6
110C	CORRIDOR	110	C	3'-0"	7'-0"	1 3/4"	SC	FNT	6/A15.2	6/A15.2	-	20 MIN	30	4, 5
111A	EXAMINATION ROOM	111	C	3'-0"	7'-0"	1 3/4"	SC	ST	9/A15.1	6/A15.1	8/A15.1	20 MIN	13	
112A	EXAMINATION ROOM	112	C	3'-0"	7'-0"	1 3/4"	SC	ST	9/A15.1	6/A15.1	8/A15.1	20 MIN	13	
113A	CORRIDOR	113	B	3'-0"	7'-0"	1 3/4"	SC	ST	9/A15.1	6/A15.1	-	NR	3	
113B	CORRIDOR	113	B	3'-0"	7'-0"	1 3/4"	SC	ST	9/A15.1	6/A15.1	-	NR	31	
114A	H.C. MANAGER'S OFFICE	114	C	3'-0"	7'-0"	1 3/4"	SC	ST	9/A15.1	6/A15.1	-	20 MIN	15	
115A	OFFICE	115	C	3'-0"	7'-0"	1 3/4"	SC	ST	9/A15.1	6/A15.1	-	20 MIN	15	
116B	OFFICE	116	C	3'-0"	7'-0"	1 3/4"	SC	ST	9/A15.1	6/A15.1	-	20 MIN	15	
116A	OFFICE	116	C	3'-0"	7'-0"	1 3/4"	SC	ST	9/A15.1	6/A15.1	-	20 MIN	15	
117A	OFFICE	117	C	3'-0"	7'-0"	1 3/4"	SC	ST	9/A15.1	6/A15.1	-	20 MIN	15	
117B	OFFICE	117	C	3'-0"	7'-0"	1 3/4"	SC	ST	9/A15.1	6/A15.1	-	20 MIN	15	
118A	OFFICE	118	C	3'-0"	7'-0"	1 3/4"	SC	ST	9/A15.1	6/A15.1	-	20 MIN	15	
119A	TEAM LEADER'S OFFICE	119	C	3'-0"	7'-0"	1 3/4"	SC	ST	9/A15.1	6/A15.1	-	20 MIN	15	
120A	EXAMINATION ROOM	120	C	3'-0"	7'-0"	1 3/4"	SC	ST	9/A15.1	6/A15.1	8/A15.1	20 MIN	13	
122A	EXAMINATION ROOM	122	C	3'-0"	7'-0"	1 3/4"	SC	ST	9/A15.1	6/A15.1	8/A15.1	20 MIN	16	
123A	EXAMINATION ROOM	123	C	3'-0"	7'-0"	1 3/4"	SC	ST	9/A15.1	6/A15.1	8/A15.1	20 MIN	13	
124A	EXAMINATION ROOM	124	C	3'-0"	7'-0"	1 3/4"	SC	ST	9/A15.1	6/A15.1	8/A15.1	20 MIN	16	
125A	CORRIDOR	125	B	3'-0"	7'-0"	1 3/4"	SC	ST	9/A15.1	6/A15.1	-	NR	14	
121A	SPUTUM	121	C	3'-0"	7'-0"	1 3/4"	SC	ST	9/A15.1	6/A15.1	8/A15.1	20 MIN	15	
128A	LABORATORY	128	C	3'-0"	7'-0"	1 3/4"	SC	ST	9/A15.1	6/A15.1	8/A15.1	20 MIN	17	6
129A	PHARMACY	129	C	3'-0"	7'-0"	1 3/4"	SC	ST	9/A15.1	6/A15.1	8/A15.1	20 MIN	18	6
130A	TOILET 3	130	C	3'-0"	7'-0"	1 3/4"	SC	ST	9/A15.1	6/A15.1	8/A15.1	20 MIN	19	
132A	RECEPTION AREA	132	C	3'-0"	7'-0"	1 3/4"	SC	ST	9/A15.1	6/A15.1	8/A15.1	20 MIN	20	6
132B	RECEPTION AREA	132	C	3'-0"	7'-0"	1 3/4"	SC	ST	9/A15.1	6/A15.1	8/A15.1	20 MIN	21	5
132C	RECEPTION AREA	132	C	3'-0"	7'-0"	1 3/4"	SC	ST	9/A15.1	6/A15.1	8/A15.1	20 MIN	21	5
132D	RECEPTION AREA	132	C	3'-0"	7'-0"	1 3/4"	SC	ST	9/A15.1	6/A15.1	8/A15.1	NR	22	
133A	MAIL/COPY ROOM	133	C	3'-0"	7'-0"	1 3/4"	SC	ST	9/A15.1	6/A15.1	8/A15.1	20 MIN	13	
134A	OFFICE	134	C	3'-0"	7'-0"	1 3/4"	SC	ST	9/A15.1	6/A15.1	-	20 MIN	22	
135A	CORRIDOR	135	B	3'-0"	7'-0"	1 3/4"	SC	ST	9/A15.1	6/A15.1	-	NR	20	
138A	JANITOR'S CLOSET	138	C	3'-0"	7'-0"	1 3/4"	SC	ST	9/A15.1	6/A15.1	8/A15.1	20 MIN	15	
139A	CHILD HEALTH SCREENING	139	C	3'-0"	7'-0"	1 3/4"	SC	ST	9/A15.1	6/A15.1	-	20 MIN	13	
140A	CORRIDOR	140	C	3'-0"	7'-0"	1 3/4"	SC	FNT	6/A15.2	6/A15.2	-	20 MIN	30	4, 5
141A	EXAMINATION ROOM	141	C	3'-0"	7'-0"	1 3/4"	SC	ST	9/A15.1	6/A15.1	8/A15.1	20 MIN	16	
142A	STORAGE	142	C	3'-0"	7'-0"	1 3/4"	SC	ST	9/A15.1	6/A15.1	8/A15.1	20 MIN	15	
143A	OFFICE	143	C	3'-0"	7'-0"	1 3/4"	SC	ST	9/A15.1	6/A15.1	8/A15.1	20 MIN	18	
144A	CORRIDOR	144	B	3'-0"	7'-0"	1 3/4"	SC	ST	9/A15.1	6/A15.1	-	NR	3	
145A	VESTIBULE 2	145	B	3'-0"	7'-0"	1 3/4"	SC	ST	9/A15.1	6/A15.1	8/A15.1	NR	23	
145B	VESTIBULE 2	145	D	3'-0"	7'-0"	1 3/4"	STL	FNT	3/A15.1	5/A15.1	4/A15.1	NR	24	
146A	VESTIBULE 4	146	B	3'-0"	7'-0"	1 3/4"	SC	ST	9/A15.1	6/A15.1	8/A15.1	NR	23	
146B	VESTIBULE 4	146	D	3'-0"	7'-0"	1 3/4"	STL	FNT	3/A15.1	5/A15.1	4/A15.1	NR	24	
147A	EXAMINATION ROOM	147	C	3'-0"	7'-0"	1 3/4"	SC	ST	9/A15.1	6/A15.1	8/A15.1	20 MIN	16	
148A	EXAMINATION ROOM	148	C	3'-0"	7'-0"	1 3/4"	SC	ST	9/A15.1	6/A15.1	8/A15.1	20 MIN	16	
149A	STORAGE	149	C	3'-0"	7'-0"	1 3/4"	SC	ST	9/A15.1	6/A15.1	8/A15.1	20 MIN	15	
149B	STORAGE	149	C	3'-0"	7'-0"	1 3/4"	SC	ST	9/A15.1	6/A15.1	8/A15.1	20 MIN	165	
150A	TOILET 2	150	C	3'-0"	7'-0"	1 3/4"	SC	ST	9/A15.1	6/A15.1	8/A15.1	2		



PROJECT NO. 115.00  
 DRAWN BY CYALS  
 CHECKED BY JBJA  
 DATE DECEMBER 9, 1992  
 REVISED

## RECORD DRAWING


TITLE

DOOR  
DETAILS

SHEET NO.

A15.1

F 3.0.059

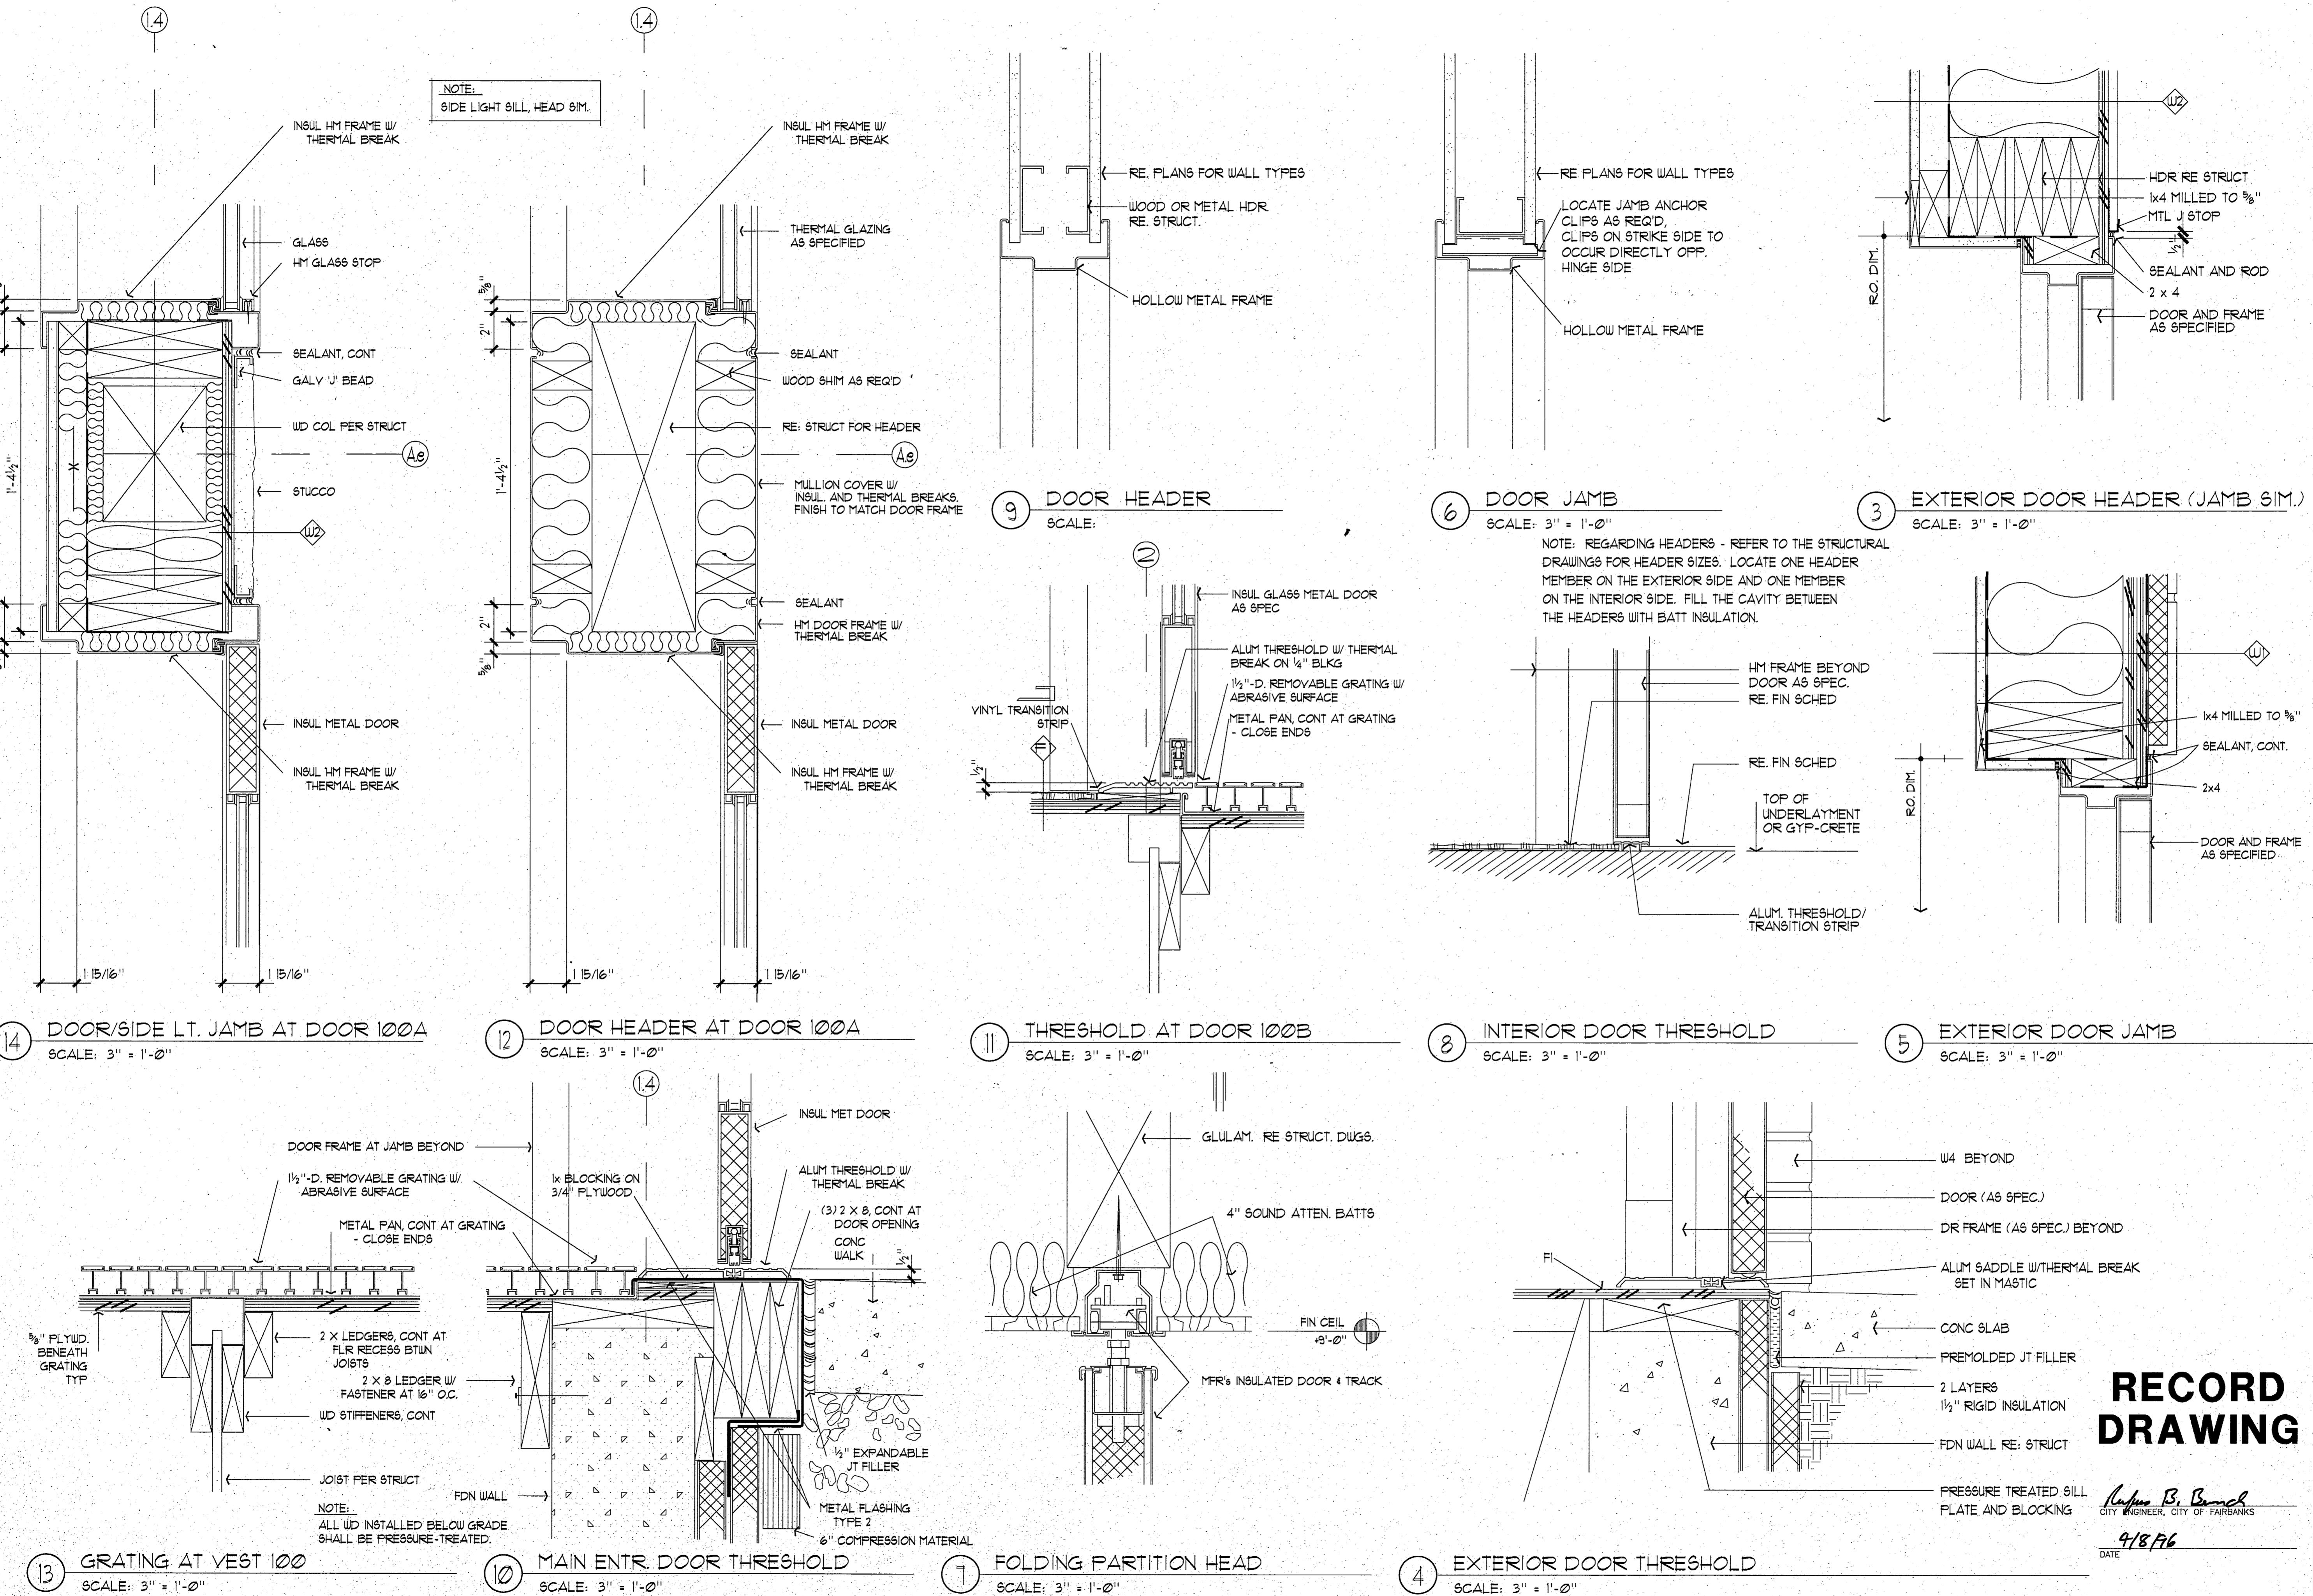

Fairbanks, Alaska  
FAIRBANKS HEALTH CENTER

**LIVINGSTON**  
STONE Architecture Engineering  
Interior Design Planning  
incorporated

3900 Arctic Blvd. Suite 301  
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City of Fairbanks





PROJECT NO. 115.00  
DRAWN BY CLARK  
CHECKED BY J.G.A.  
DATE DEC 9, 1992  
REVISED

TITLE  
DOOR DETAILS  
SHEET NO.

A15.2

## RECORD DRAWING

Rufus B. Borch  
CITY ENGINEER, CITY OF FAIRBANKS  
4/8/96

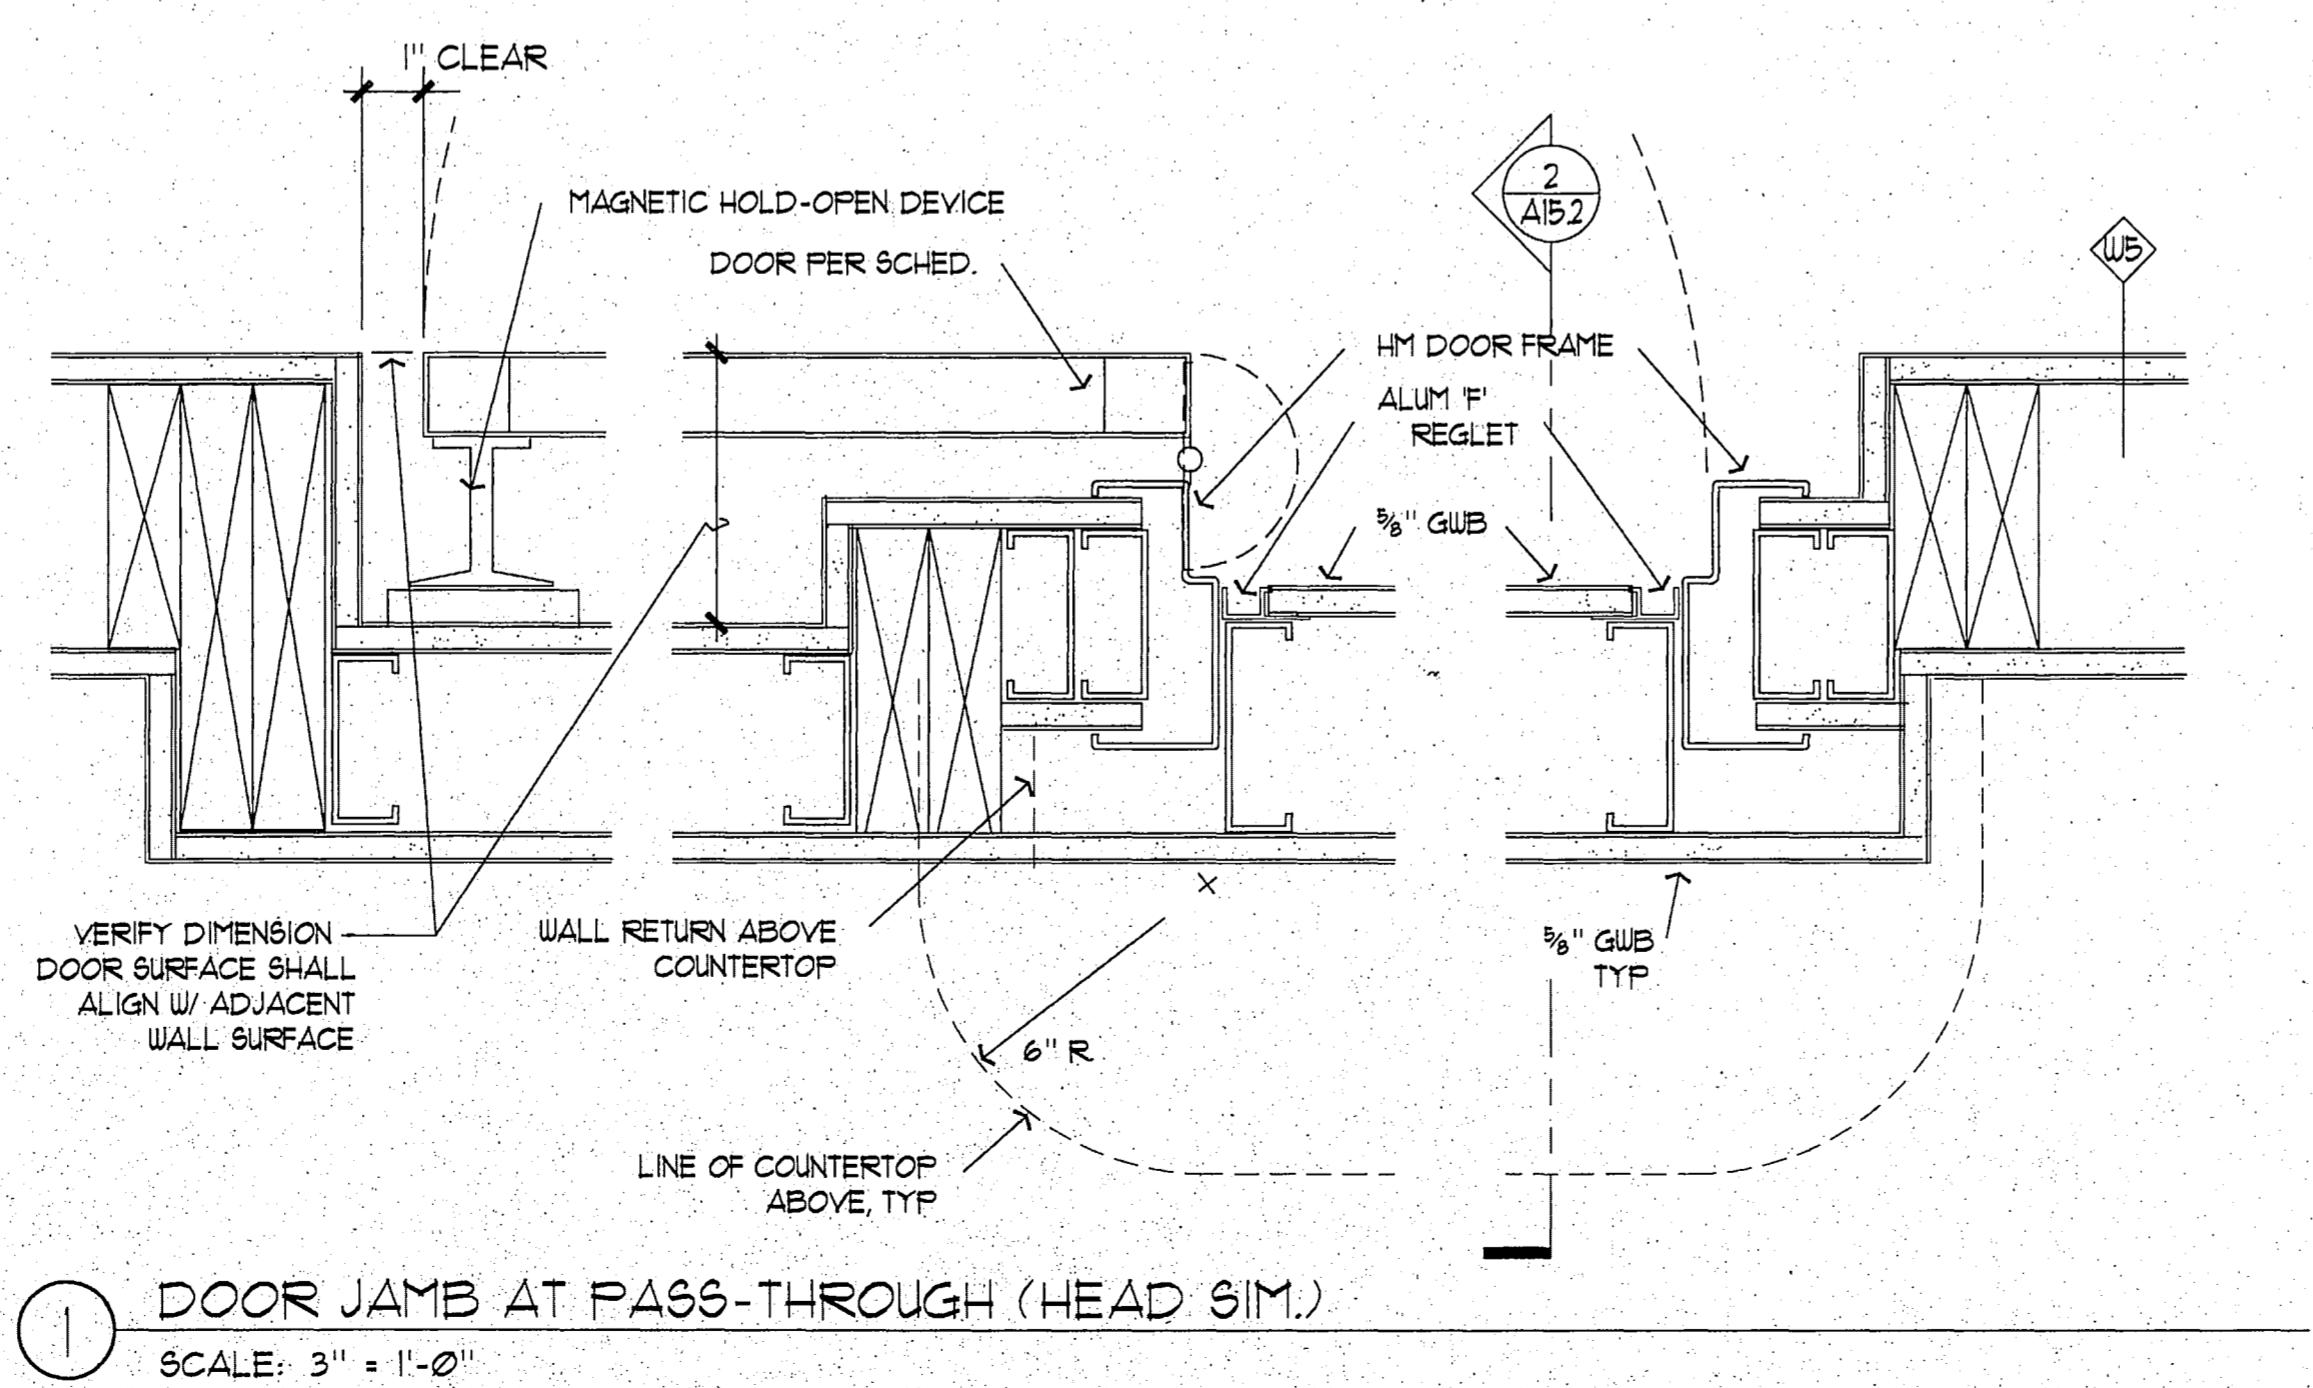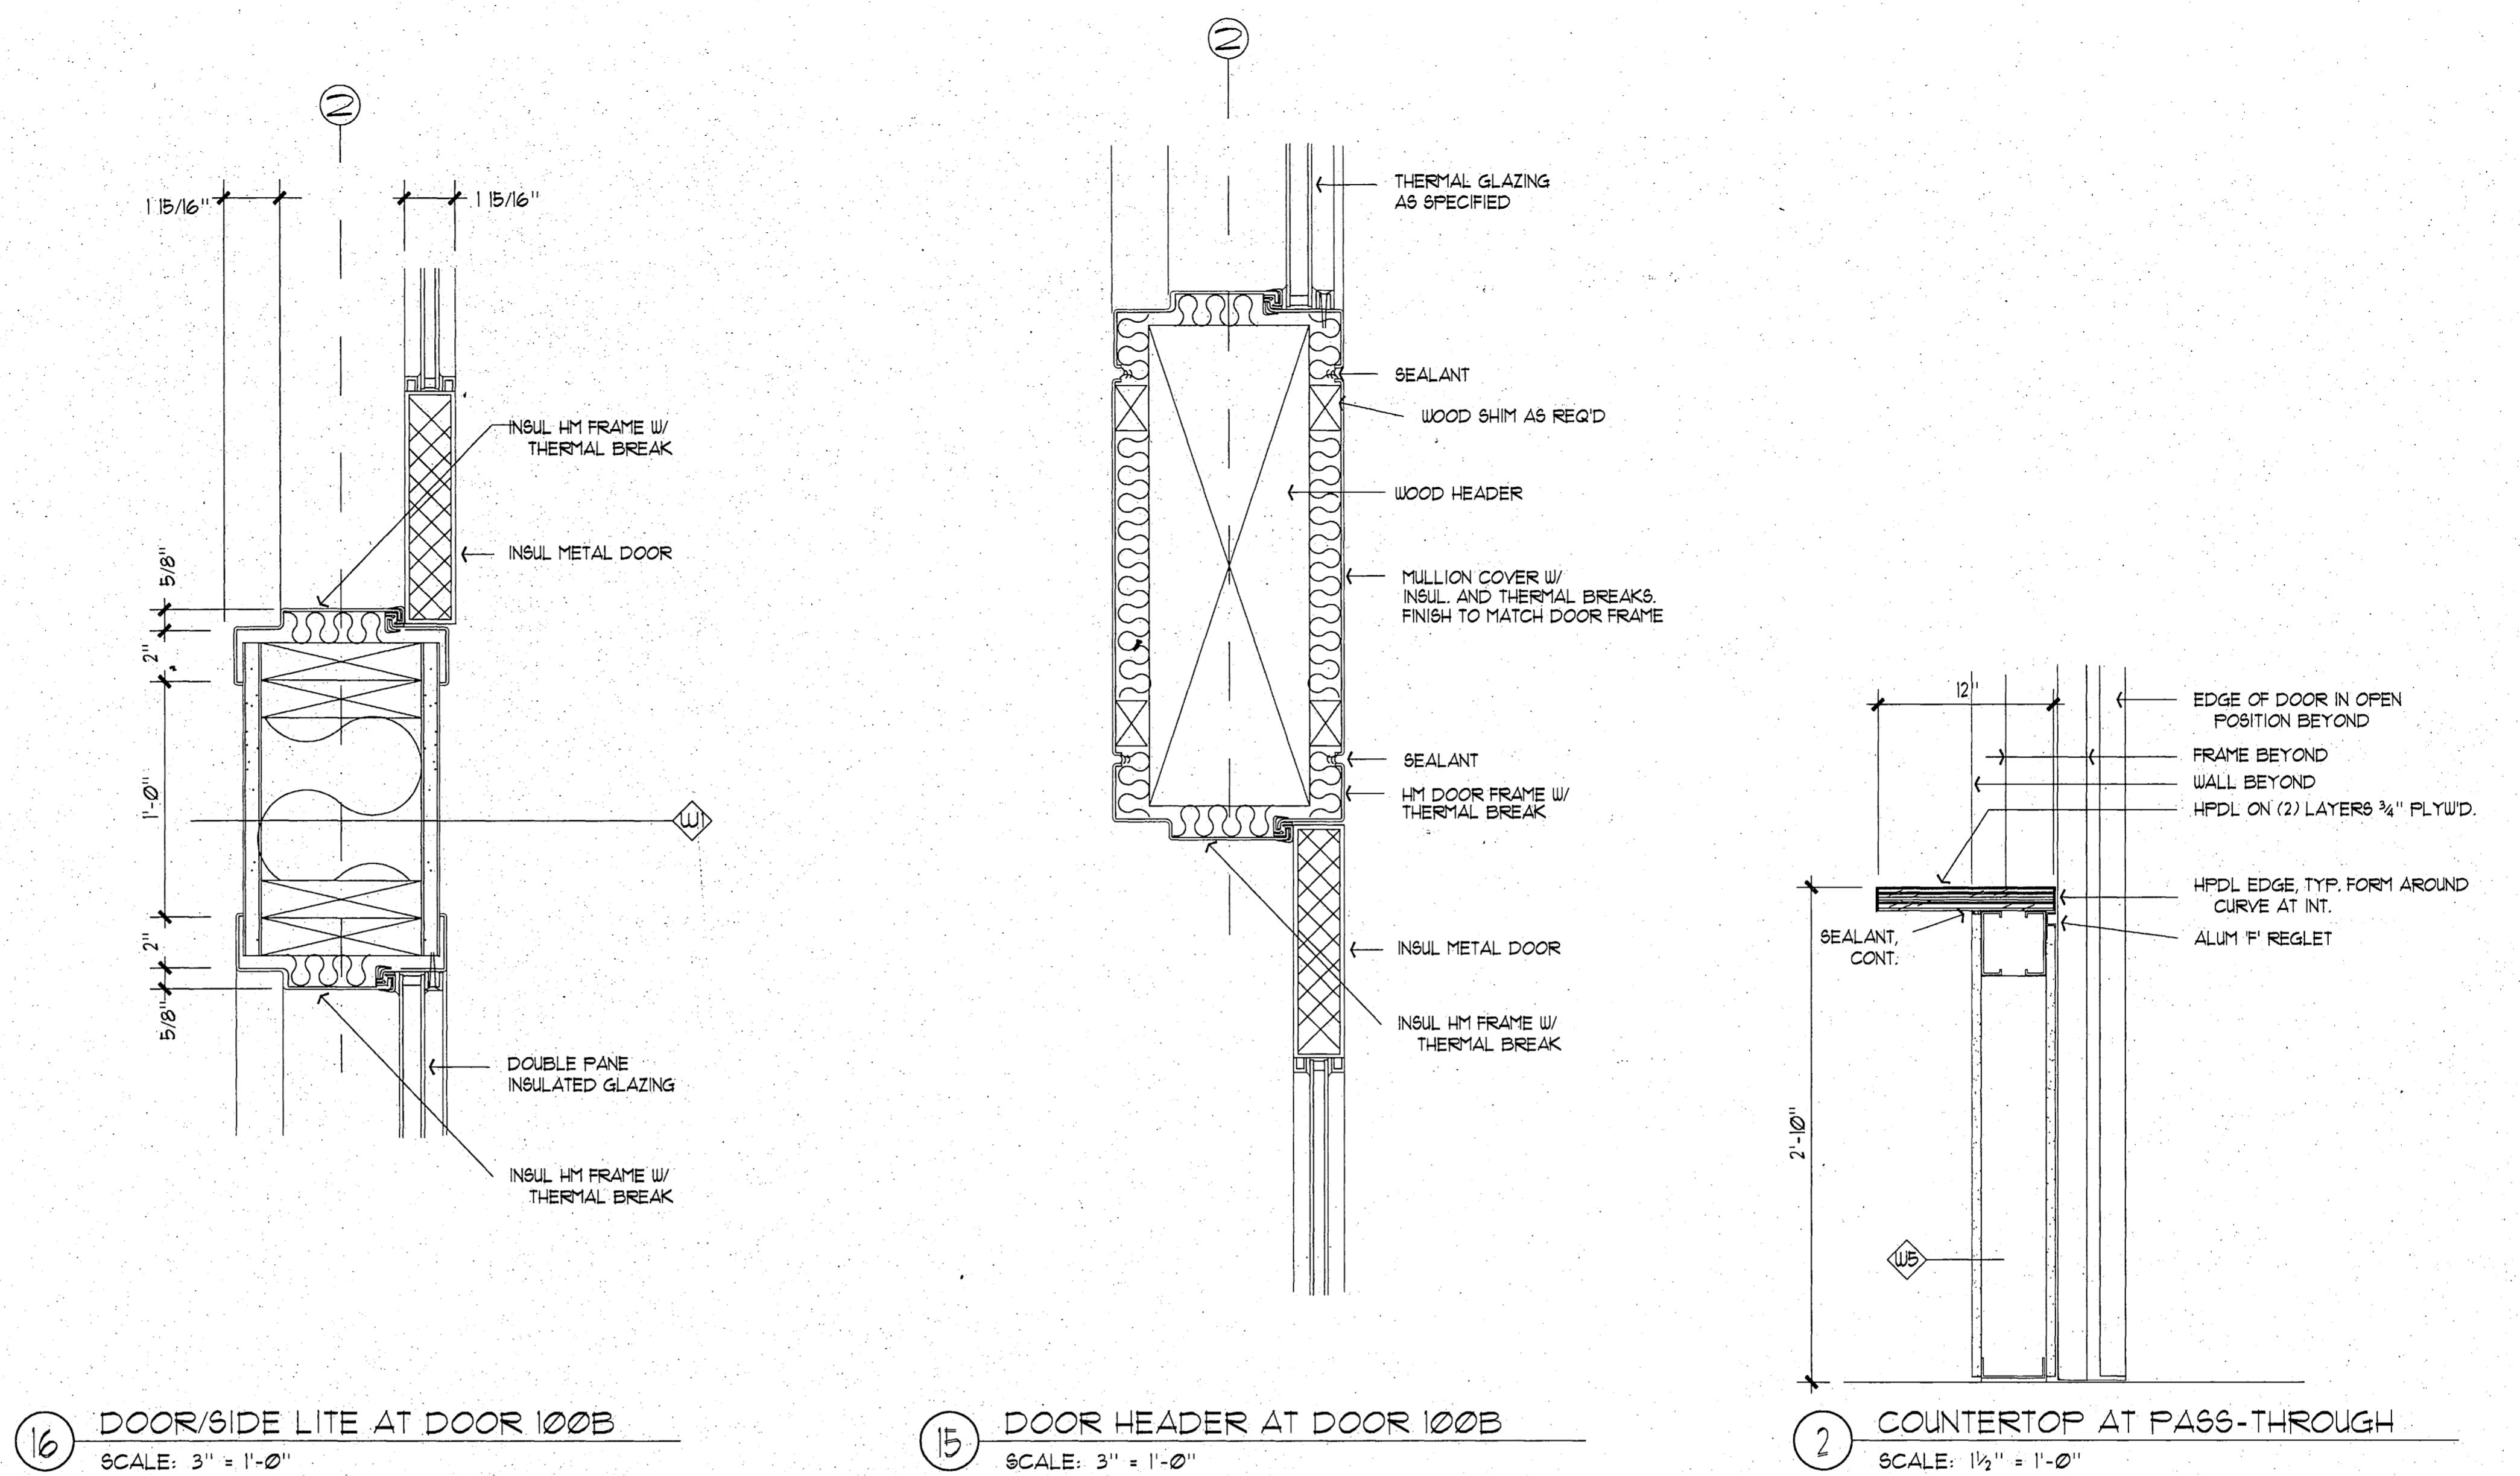

# ROOM FINISH SCHEDULE

NO.	NAME	FLOOR		BASE		WAINTSCOT		NORTH WALL		EAST WALL		SOUTH WALL		WEST WALL		CEILING 8'-0"		NOTES			
		MATERIAL	FINISH	MATERIAL	FINISH	MATERIAL	FINISH	MATERIAL	FINISH	MATERIAL	FINISH	MATERIAL	FINISH	MATERIAL	FINISH	MATERIAL	FINISH	HEIGHT	RM.	REFER TO SPECIFICATIONS FOR FURTHER MATERIAL, FINISH AND COLOR INFORMATION.	
100	VESTIBULE	TIREX		RB		GUB	PT	GUB	PT	GUB	PT	GUB	PT	GUB	PT	GUB	PT	8'-0"	100	RE. 1/A100 FOR VAULTED CEILING LOCATION	
101	LOBBY	CPT		RB		GUB	PT	GUB	PT	GUB	PT	GUB	PT	GUB	PT	GUB	PT	9'-0"	101	RE. 1/A100 FOR VAULTED CEILING LOCATION	
102	DRINKING FOUNTAIN	CPT		RB		GUB	PT	GUB	PT	GUB	PT	GUB	PT	GUB	PT	GUB	PT	8'-0"	102	RE. 1/A100 FOR CEILING LOCATION	
103	MEN'S TOILET	VINYL		RB		WR GUB	V WC	WR GUB	V WC	WR GUB	V WC	WR GUB	V WC	WR GUB	V WC	ACT	PT	8'-6"	103	VINYL WALL COVERING TO BE WASHABLE AND SCRUBBABLE	
104	WOMEN'S TOILET	VINYL		RB		WR GUB	V WC	WR GUB	V WC	WR GUB	V WC	WR GUB	V WC	WR GUB	V WC	ACT	PT	8'-6"	104	VINYL WALL COVERING TO BE WASHABLE AND SCRUBBABLE	
105	WAITING AREA	CPT		RB		GUB	PT	GUB	PT	GUB	PT	GUB	PT	GUB	PT	ACT	PT	8'-6"	105	RE. 1/A100 FOR SOFFIT LOCATION	
106	ELEVATOR EQUIPMENT	VINYL		RB		GUB	PT	GUB	PT	GUB	PT	GUB	PT	GUB	PT	GUB	PT	9'-0"	106		
107	CONF. ROOM	CPT		RB		GUB	PT	GUB	PT	GUB	PT	GUB	PT	GUB	PT	ACT	PT	9'-0"	107	RE. 1/A100 FOR SOFFIT LOCATION	
108	CONF. ROOM STORAGE	CPT		RB		GUB	PT	GUB	PT	GUB	PT	GUB	PT	GUB	PT	ACT	PT	8'-0"	108		
109	CHILD'S PLAY AREA	CPT		RB		GUB	PT	GUB	PT	GUB	PT	GUB	PT	GUB	PT	GUB	PT	8'-0"	109		
110	CORRIDOR	CPT		RB		GUB	V WC	GUB	V WC	GUB	V WC	GUB	V WC	GUB	V WC	ACT	PT	8'-4"	110		
111	EXAMINATION ROOM	VINYL	COVE			GUB	PT	GUB	PT	GUB	PT	GUB	PT	GUB	PT	ACT	PT	8'-6"	111	RE. DTL. 1/A160 FOR COVE BASE	
112	EXAMINATION ROOM	VINYL	COVE			GUB	PT	GUB	PT	GUB	PT	GUB	PT	GUB	PT	ACT	PT	8'-6"	112	RE. DTL. 1/A160 FOR COVE BASE	
113	CORRIDOR	CPT	RB			GUB	V WC	GUB	V WC	GUB	V WC	GUB	V WC	GUB	V WC	ACT	PT	8'-4"	113		
114	H.C. MANAGER OFFICE	CPT	RB			GUB	PT	GUB	PT	GUB	PT	GUB	PT	GUB	PT	ACT	PT	9'-0"	114		
115	OFFICE	CPT	RB			GUB	PT	GUB	PT	GUB	PT	GUB	PT	GUB	PT	ACT	PT	8'-6"	115		
116	OFFICE	CPT	RB			GUB	PT	GUB	PT	GUB	PT	GUB	PT	GUB	PT	ACT	PT	8'-6"	116		
117	OFFICE	CPT	RB			GUB	PT	GUB	PT	GUB	PT	GUB	PT	GUB	PT	ACT	PT	8'-6"	117		
118	OFFICE	CPT	RB			GUB	PT	GUB	PT	GUB	PT	GUB	PT	GUB	PT	ACT	PT	8'-6"	118		
119	TEAM LEADER'S OFFICE	CPT	RB			GUB	PT	GUB	PT	GUB	PT	GUB	PT	GUB	PT	ACT	PT	8'-6"	119		
120	EXAMINATION ROOM	VINYL	COVE			GUB	PT	GUB	PT	GUB	PT	GUB	PT	GUB	PT	ACT	PT	8'-0"	120	RE. DTL. 1/A160 FOR COVE BASE	
121	STAIR 2	CPT	RB			GUB	PT	GUB	PT	GUB	PT	GUB	PT	GUB	PT	GUB	PT	OPEN	121		
122	EXAMINATION ROOM	VINYL	COVE			GUB	PT	GUB	PT	GUB	PT	GUB	PT	GUB	PT	ACT	PT	8'-0"	122	RE. DTL. 1/A160 FOR COVE BASE	
123	EXAMINATION ROOM	VINYL	COVE			GUB	PT	GUB	PT	GUB	PT	GUB	PT	GUB	PT	ACT	PT	8'-0"	123	RE. DTL. 1/A160 FOR COVE BASE	
124	EXAMINATION ROOM	VINYL	COVE			GUB	PT	GUB	PT	GUB	PT	GUB	PT	GUB	PT	ACT	PT	8'-0"	124	RE. DTL. 1/A160 FOR COVE BASE	
125	CORRIDOR	CPT	RB			GUB	V WC	GUB	V WC	GUB	V WC	GUB	V WC	GUB	V WC	ACT	PT	8'-4"	125		
126	CORRIDOR	CPT	RB			GUB	V WC	GUB	V WC	GUB	V WC	GUB	V WC	GUB	V WC	ACT	PT	8'-4"	126		
127	SPUTUM	VINYL	RB			GUB	PT	GUB	PT	GUB	PT	GUB	PT	GUB	PT	ACT	PT	8'-0"	127		
128	LABORATORY	VINYL	RB			GUB	PT	GUB	PT	GUB	PT	GUB	PT	GUB	PT	ACT	PT	8'-0"	128		
129	PHARMACY	VINYL	RB			GUB	PT	GUB	PT	GUB	PT	GUB	PT	GUB	PT	ACT	PT	8'-0"	129		
130	TOILET 3	VINYL	RB			WR GUB	PT	WR GUB	PT	WR GUB	PT	WR GUB	PT	WR GUB	PT	ACT	PT	8'-0"	130		
131	RECORD'S AREA	VINYL	RB			GUB	PT	GUB	PT	GUB	PT	GUB	PT	GUB	PT	ACT	PT	8'-6"	131		
132	RECEPTION AREA	CPT	RB			GUB	PT	GUB	PT	GUB	PT	GUB	PT	GUB	PT	ACT	PT	8'-6"	132	RE. 1/A100 FOR SOFFIT LOCATION	
133	MAIL/COPY ROOM	VINYL	RB			GUB	PT	GUB	PT	GUB	PT	GUB	PT	GUB	PT	ACT	PT	8'-4"	133		
134	OFFICE	CPT	RB			GUB	PT	GUB	PT	GUB	PT	GUB	PT	GUB	PT	ACT	PT	8'-4"	134		
135	CORRIDOR	CPT	RB			GUB	V WC	GUB	V WC	GUB	V WC	GUB	V WC	GUB	V WC	ACT	PT	8'-4"	135		
136	ELEVATOR	CONC	NONE			GUB	NONE	GUB	NONE	GUB	NONE	GUB	NONE	GUB	NONE	ACT	PT	OPEN	136		
137	STAIR 1	CPT	RB			GUB	PT	GUB	PT	GUB	PT	GUB	PT	GUB	PT	GUB	PT	OPEN	137		
138	JANITOR	VINYL	RB			WR GUB	PT	GUB	PT	GUB	PT	GUB	PT	GUB	PT	GUB	PT	9'-0"	138		
139	CHILD HEALTH SCREENING	CPT	RB			GUB	PT	GUB	PT	GUB	PT	GUB	PT	GUB	PT	ACT	PT	8'-6"	139		
140	CORRIDOR	CPT	RB			GUB	V WC	GUB	V WC	GUB	V WC	GUB	V WC	GUB	V WC	ACT	PT	8'-4"	140	RE. DTL. 1/A160 FOR COVE BASE	
141	EXAMINATION ROOM	VINYL	COVE			GUB	PT	GUB	PT	GUB	PT	GUB	PT	GUB	PT	ACT	PT	8'-0"	141	RE. DTL. 1/A160 FOR COVE BASE	
142	STORAGE	VINYL	RB			GUB	PT	GUB	PT	GUB	PT	GUB	PT	GUB	PT	ACT	PT	8'-6"	142		
143	OFFICE	CPT	RB			GUB	PT	GUB													

# ROOM FINISH SCHEDULE



RM NO.	NAME	FLOOR		BASE		WAINGSCOT		NORTH WALL			EAST WALL			SOUTH WALL			WEST WALL			CEILING			NOTES
		MATERIAL	FINISH	MATERIAL	FINISH	MATERIAL	FINISH	HEIGHT	COLOR	MATERIAL	FINISH	COLOR	MATERIAL	FINISH	COLOR	MATERIAL	FINISH	COLOR	MATERIAL	FINISH	HEIGHT	ROOM NO.	
201	CORRIDOR	CPT		RB		GUB	V WC		GUB	V WC		GUB	V WC		GUB	V WC		ACT	PT	8'-4"	201		
202	RECEPTION/WAITING AREA	CPT		RB		GUB	PT		GUB	PT		GUB	PT		GUB	PT		ACT	PT	8'-4"	202		
203	OFFICE	CPT		RB		GUB	PT		GUB	PT		GUB	PT		GUB	PT		ACT	PT	8'-4"	203		
204	ACCT. TRAVEL	CPT		RB		GUB	PT		GUB	PT		GUB	PT		GUB	PT		ACT	PT	8'-6"	204		
205	OFFICE	CPT		RB		GUB	PT		GUB	PT		GUB	PT		GUB	PT		ACT	PT	8'-6"	205		
206	NOT USED	--	--	--	--	--	--	--	--	--	--	--	--	--	--	--	--	--	--	--	206		
207	TOILET 6/SHOWER	VINYL		RB		WR GUB	PT		WR GUB	PT		WR GUB	PT		WR GUB	PT		WR GUB	PT	8'-0"	207		
208	JANITOR	VINYL		RB		WR GUB	PT		WR GUB	PT		WR GUB	PT		WR GUB	PT		ACT	PT	8'-0"	208		
209	STAIR 1	CPT		RB		GUB	PT		GUB	PT		GUB	PT		GUB	PT		GUB	PT	9'-0"	209		
210	OFFICE	CPT		RB		GUB	PT		GUB	PT		GUB	PT		GUB	PT		ACT	PT	8'-4"	210		
211	OFFICE	CPT		RB		GUB	PT		GUB	PT		GUB	PT		GUB	PT		ACT	PT	8'-6"	211		
212	CORRIDOR	CPT		RB		GUB	V WC		GUB	V WC		GUB	V WC		GUB	V WC		ACT	PT	8'-4"	212		
213	Mechanical Room	VINYL		RB		WR GUB	PT		WR GUB	PT		WR GUB	PT		WR GUB	PT		GUB	PT	12'-6"	213	APPLY. CONT. ACCOUNT. SEALANT AT ALL WALLS, CEILING, FLOORS AND PENETRATIONS	
214	LIGHT WELL	NONE	NONE			GUB	PT		GUB	PT		GUB	PT		GUB	PT		GUB	PT	9'-3"	214		
215	DATA ENTRY/RFGMS	CPT		RB		GUB	PT		GUB	PT		GUB	PT		GUB	PT		ACT	PT	8'-6"	215		
216	LIGHT WELL	NONE	NONE			GUB	PT		GUB	PT		GUB	PT		GUB	PT		GUB	PT	9'-3"	216		
217	OFFICE	CPT		RB		GUB	PT		GUB	PT		GUB	PT		GUB	PT		ACT	PT	8'-6"	217		
218	CORRIDOR	CPT		RB		GUB	V WC		GUB	V WC		GUB	V WC		GUB	V WC		ACT	PT	8'-4"	218		
219	CONFERENCE ROOM	CPT		RB		GUB	PT		GUB	PT		GUB	PT		GUB	PT		ACT	PT	8'-6"	219		
220	LIGHT WELL	NONE	NONE			GUB	PT		GUB	PT		GUB	PT		GUB	PT		GUB	PT	9'-3"	220		
221	CORRIDOR	CPT		RB		GUB	V WC		GUB	V WC		GUB	V WC		GUB	V WC		ACT	PT	8'-4"	221		
222	TOILET 1	VINYL		RB		WR GUB	PT		WR GUB	PT		WR GUB	PT		WR GUB	PT		ACT	PT	8'-0"	222		
223	LIGHT WELL	NONE	NONE			GUB	PT		GUB	PT		GUB	PT		GUB	PT		GUB	PT	9'-3"	223		
224	REGIONAL MANAGER'S OFFICE	CPT		RB		GUB	PT		GUB	PT		GUB	PT		GUB	PT		ACT	PT	8'-6"	224		
225	ADMIN. ASSISTANT'S OFFICE	CPT		RB		GUB	PT		GUB	PT		GUB	PT		GUB	PT		ACT	PT	8'-6"	225		
226	RESOURCE ROOM	CPT		RB		GUB	PT		GUB	PT		GUB	PT		GUB	PT		ACT	PT	8'-6"	226	COORDINATE CEILING HEIGHT WITH MECHANICAL	
227	COPY ROOM	CPT		RB		GUB	PT		GUB	PT		GUB	PT		GUB	PT		ACT	PT	8'-4"	227		
228	STAIR 2	CPT		RB		GUB	PT		GUB	PT		GUB	PT		GUB	PT		ACT	PT	9'-0"	228		

REFER TO SPECIFICATIONS FOR FURTHER MATERIAL, FINISH AND COLOR INFORMATION.

City of Fairbanks

FAIRBANKS HEALTH CENTER

Fairbanks, Alaska

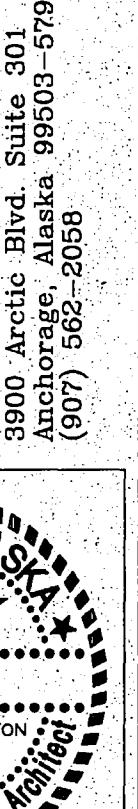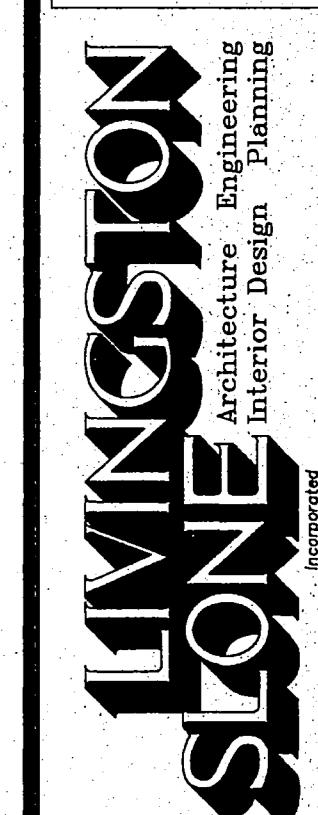

PROJECT NO. 115.00

DRAWN BY OM

CHECKED BY JB JA

DATE DEC 9, 1992

REVISED

TITLE  
ROOM  
FINISH  
SCHEDULE  
SHEET NO.

RECORD  
DRAWING

Rufus B. Beach


CITY ENGINEER, CITY OF FAIRBANKS

4/18/92

A15.4

F 3.0.056

# RECORD DRAWING

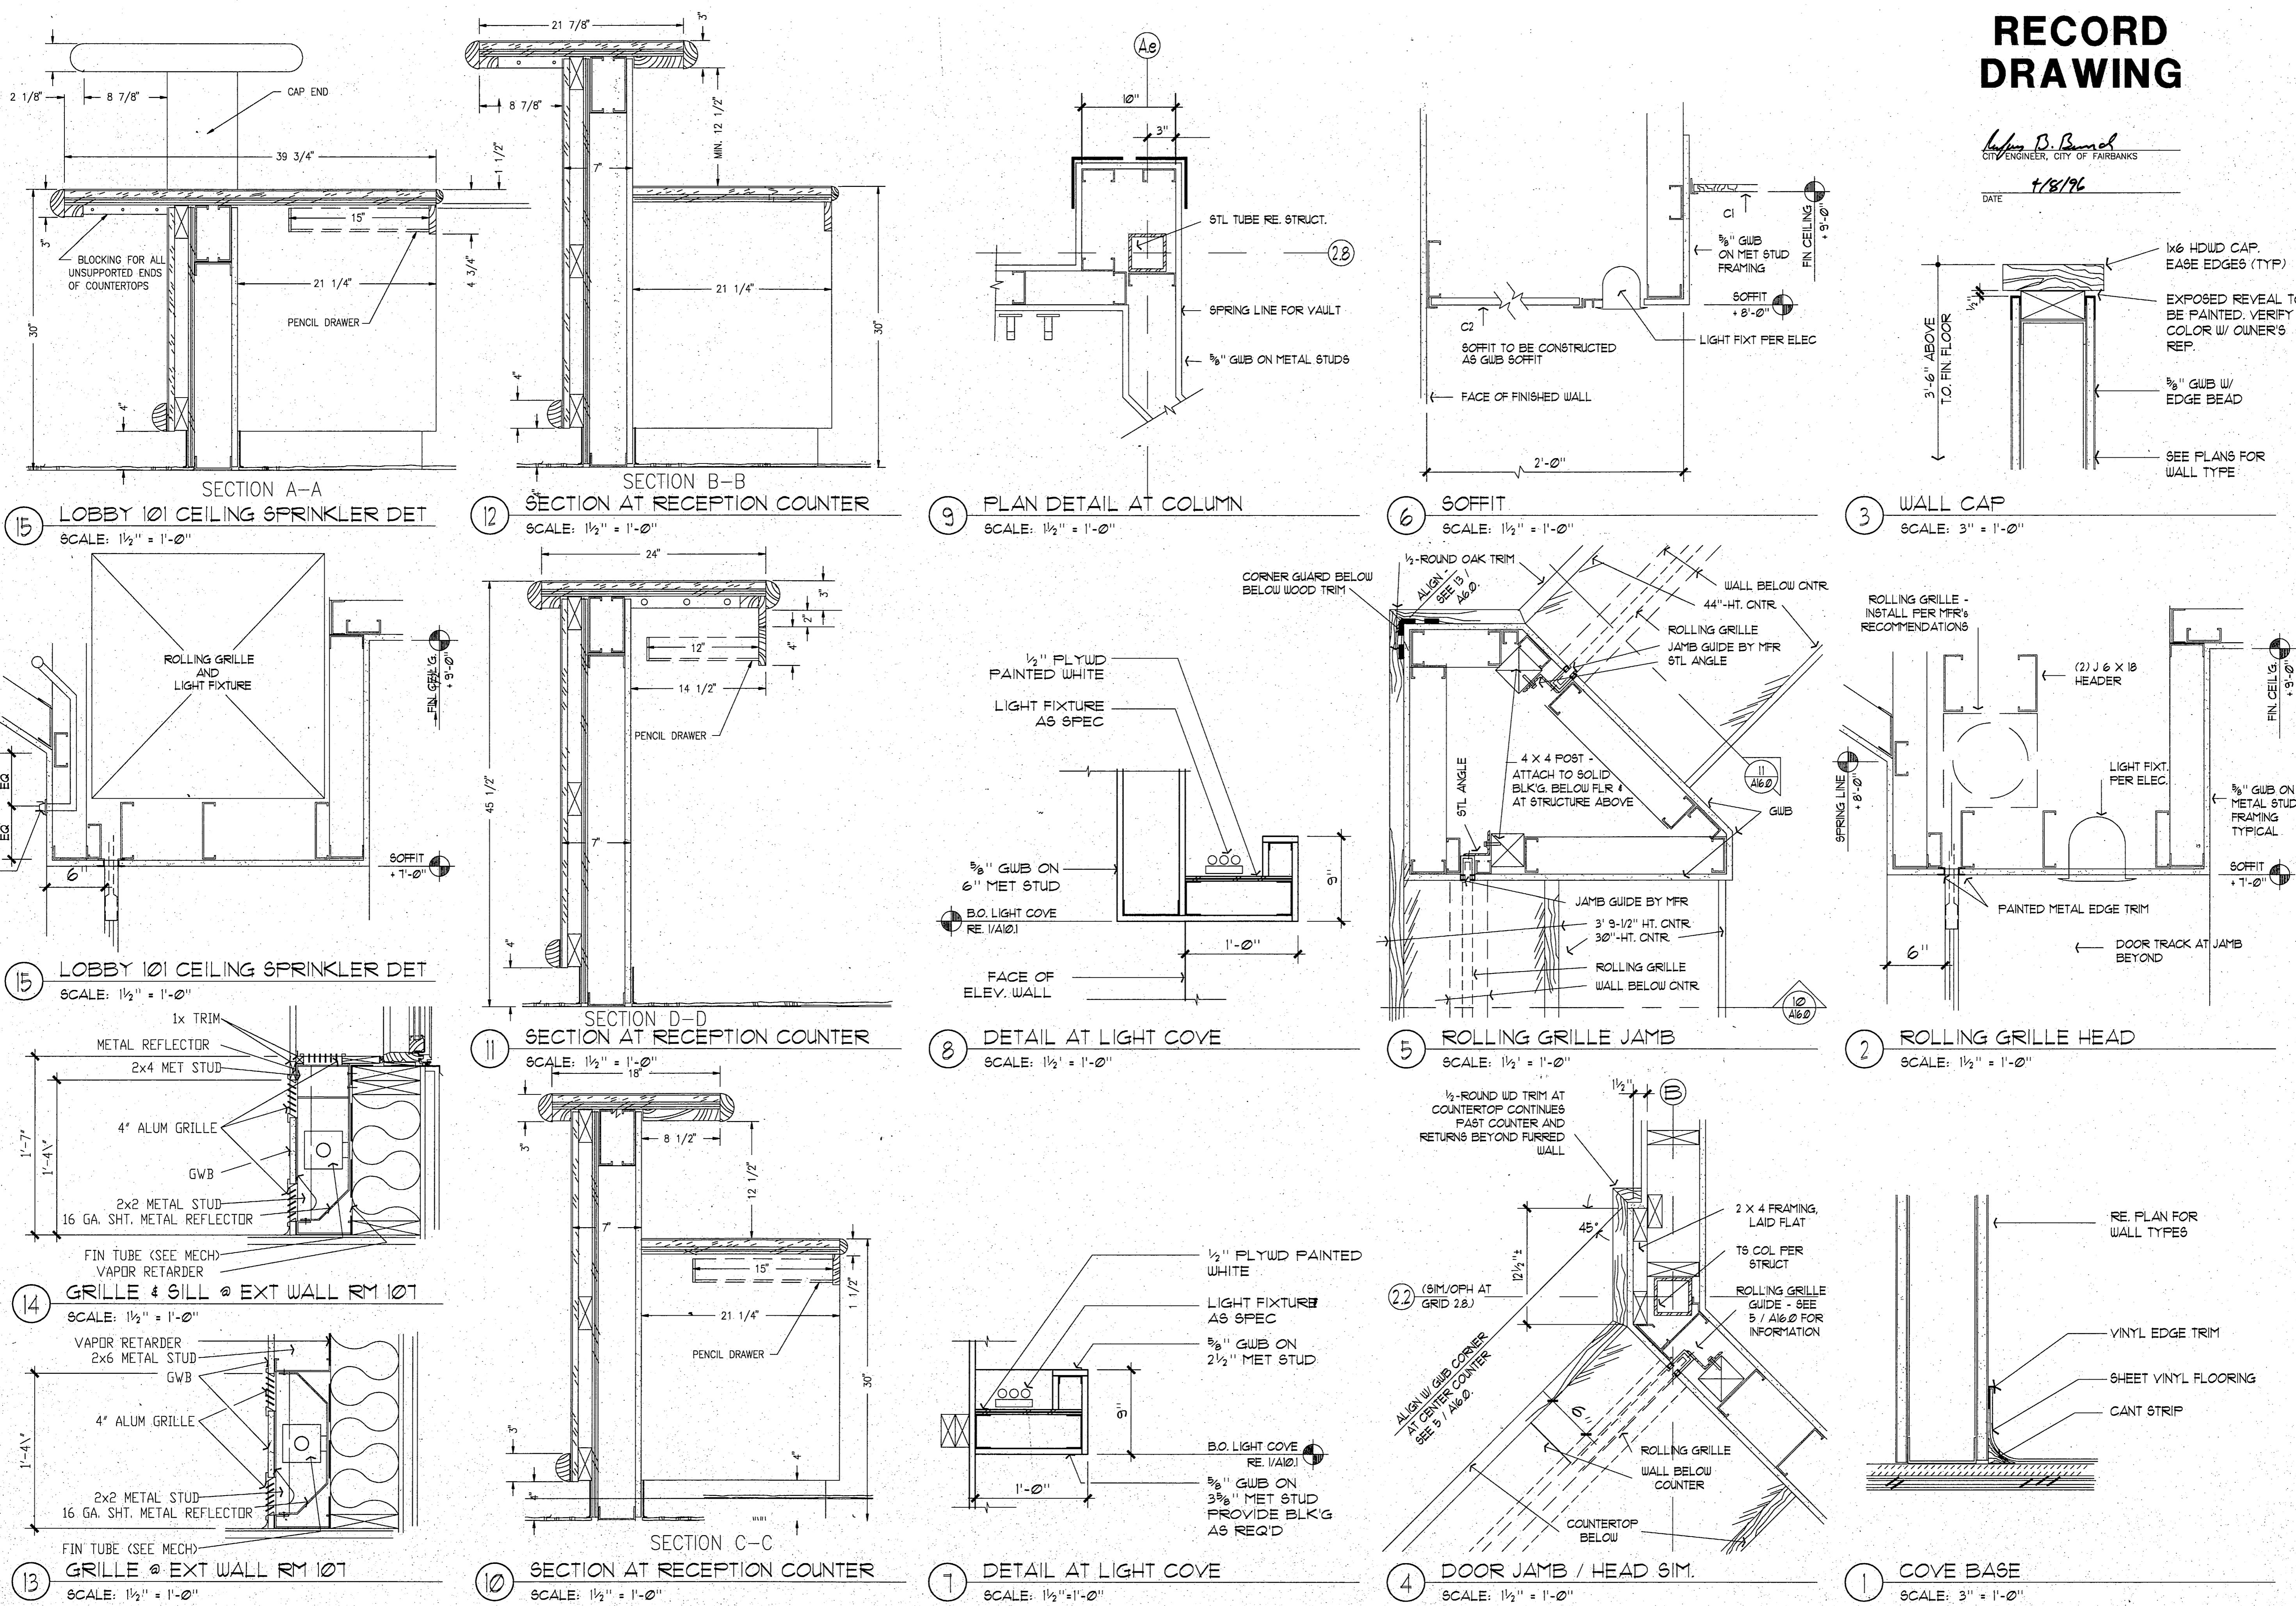

**LIVINGSTON STONE**  
Architecture Engineering Interior Design Planning


3900 Arctic Blvd. Suite 301  
Anchorage, Alaska 99503-5790

(907) 563-2058

Fairbanks  
City of Fairbanks  
FAIRBANKS HEALTH CENTER  
Fairbanks, Alaska

City of Fairbanks  
Fairbanks, Alaska

Fairbanks, Alaska

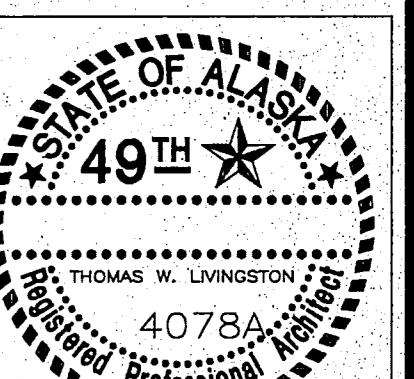

PROJECT NO. 115.00

DRAWN BY AS, CY

CHECKED BY J.G.A.

DATE DEC 9, 1992

REVISED

TITLE  
INTERIOR DETAILS


SHEET NO.

A16.0

# RECORD DRAWING

*W. F. Bemoch*  
W. F. BEMOCH  
ENGINEER, CITY OF FAIRBANKS

418/96

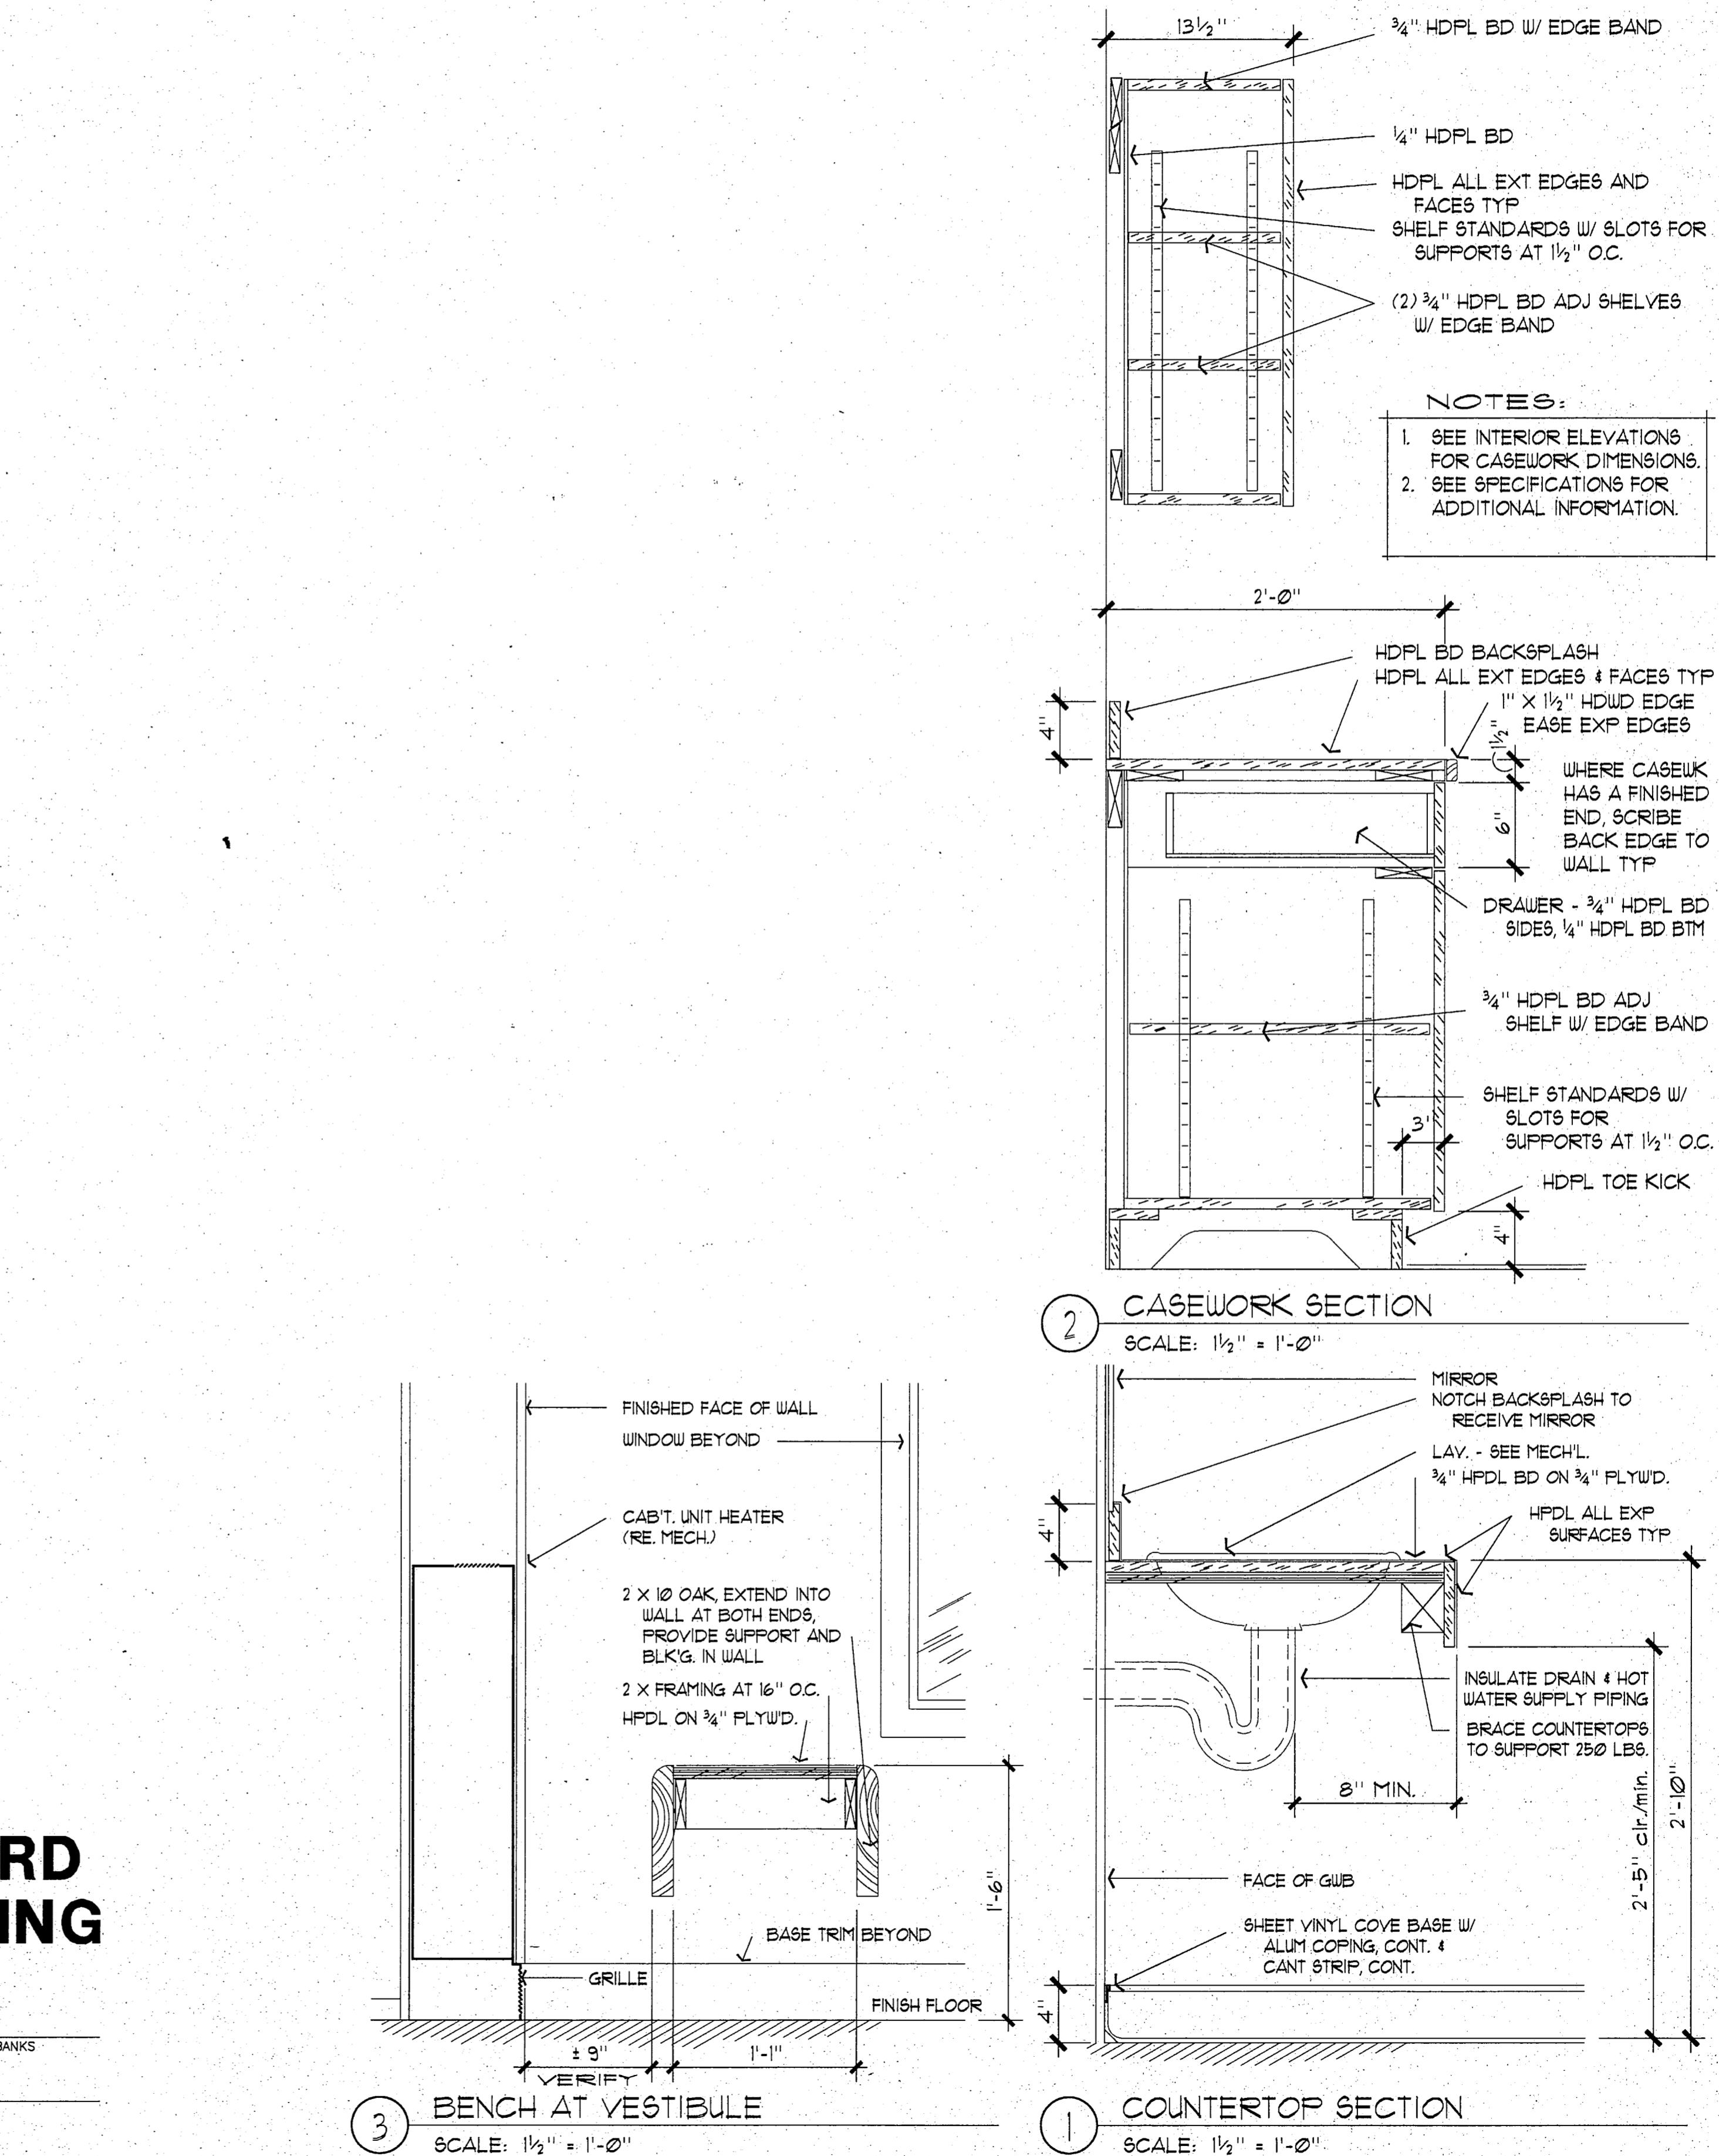


A16.1

3.0.054

# FAIRBANKS HEALTH CENTER

301 Civic Blvd. Suite 301  
Incorporated

Fairbanks, Alaska

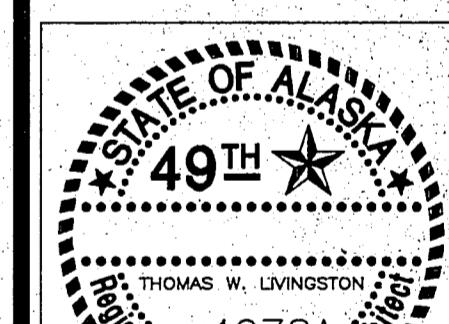

PROJECT NO. 115-00

DRAWN BY CLARK

**CHECKED BY** J.G.A.

**DATE** DEC 9, 199

**REVISED**

10. The following table gives the number of hours per week spent by students in various activities.

# TITLE INTERIOR DETAILS


**SHEET NO.**

19. *Leucosia* *leucostoma* *leucostoma* *leucostoma* *leucostoma*

3.0.054

**FAIRBANKS HEALTH CENTER**


Fairbanks, Alaska

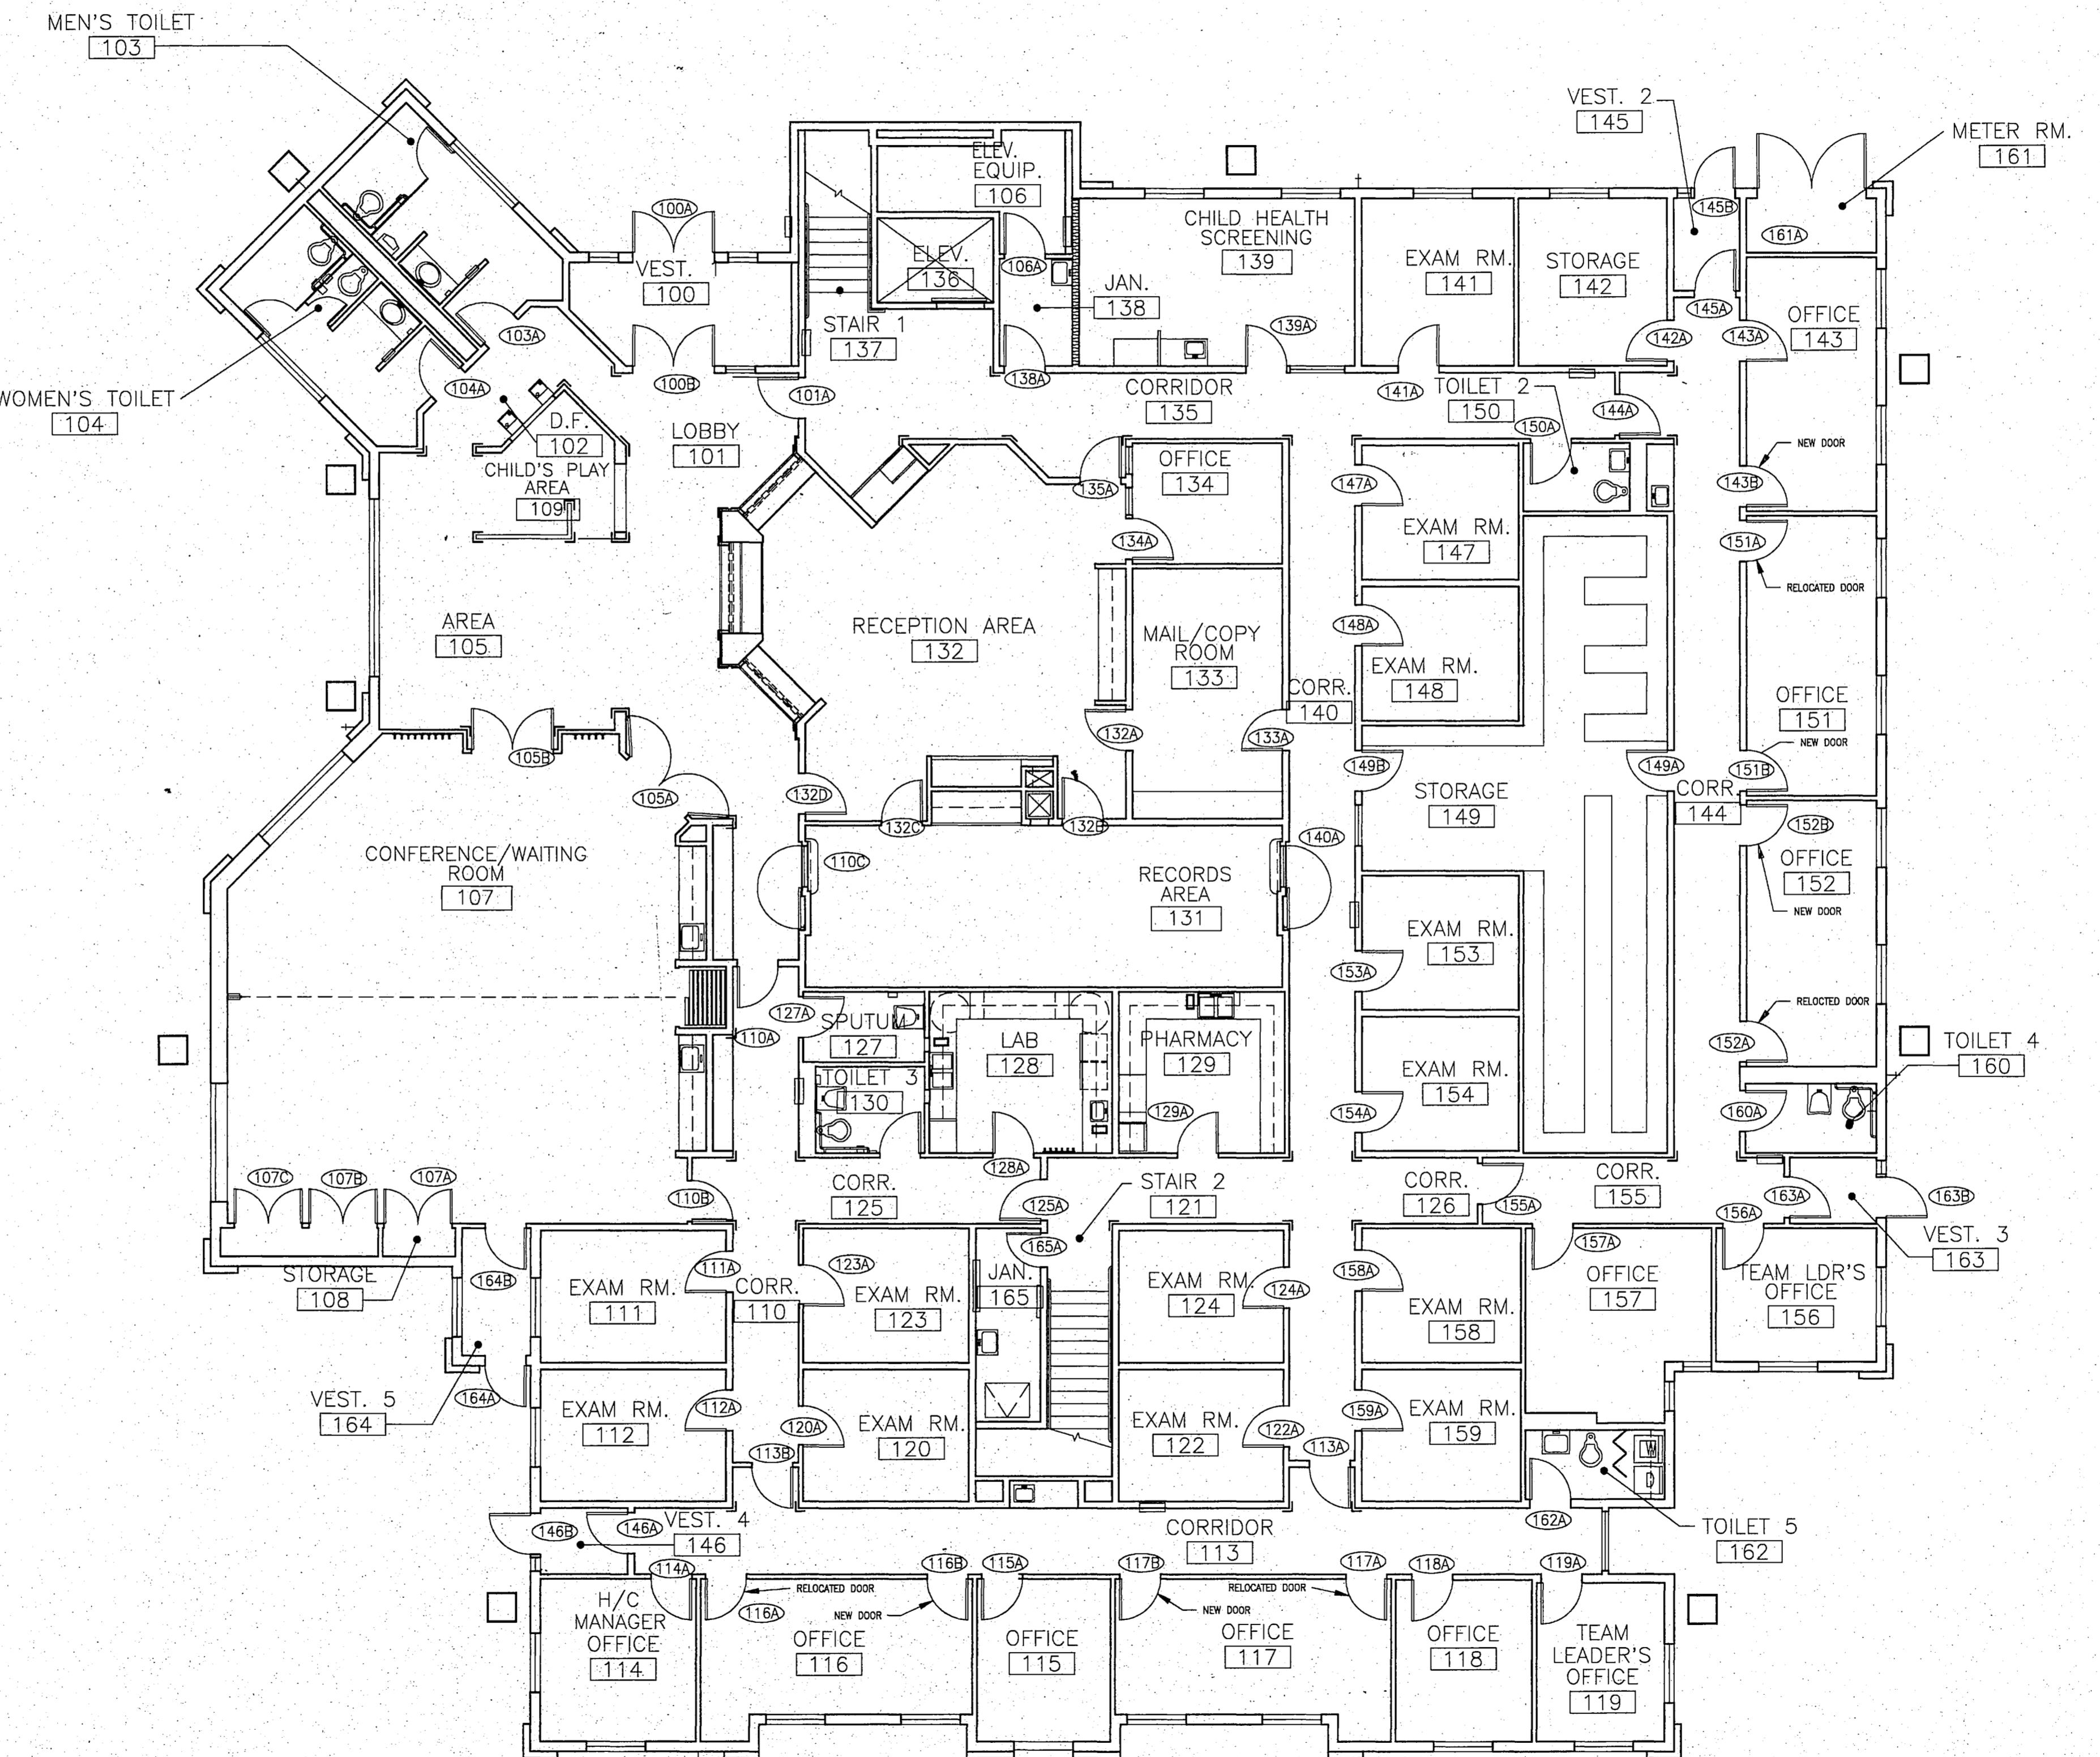

**FAIRBANKS HEALTH CENTER**

City of Fairbanks

Fairbanks, Alaska

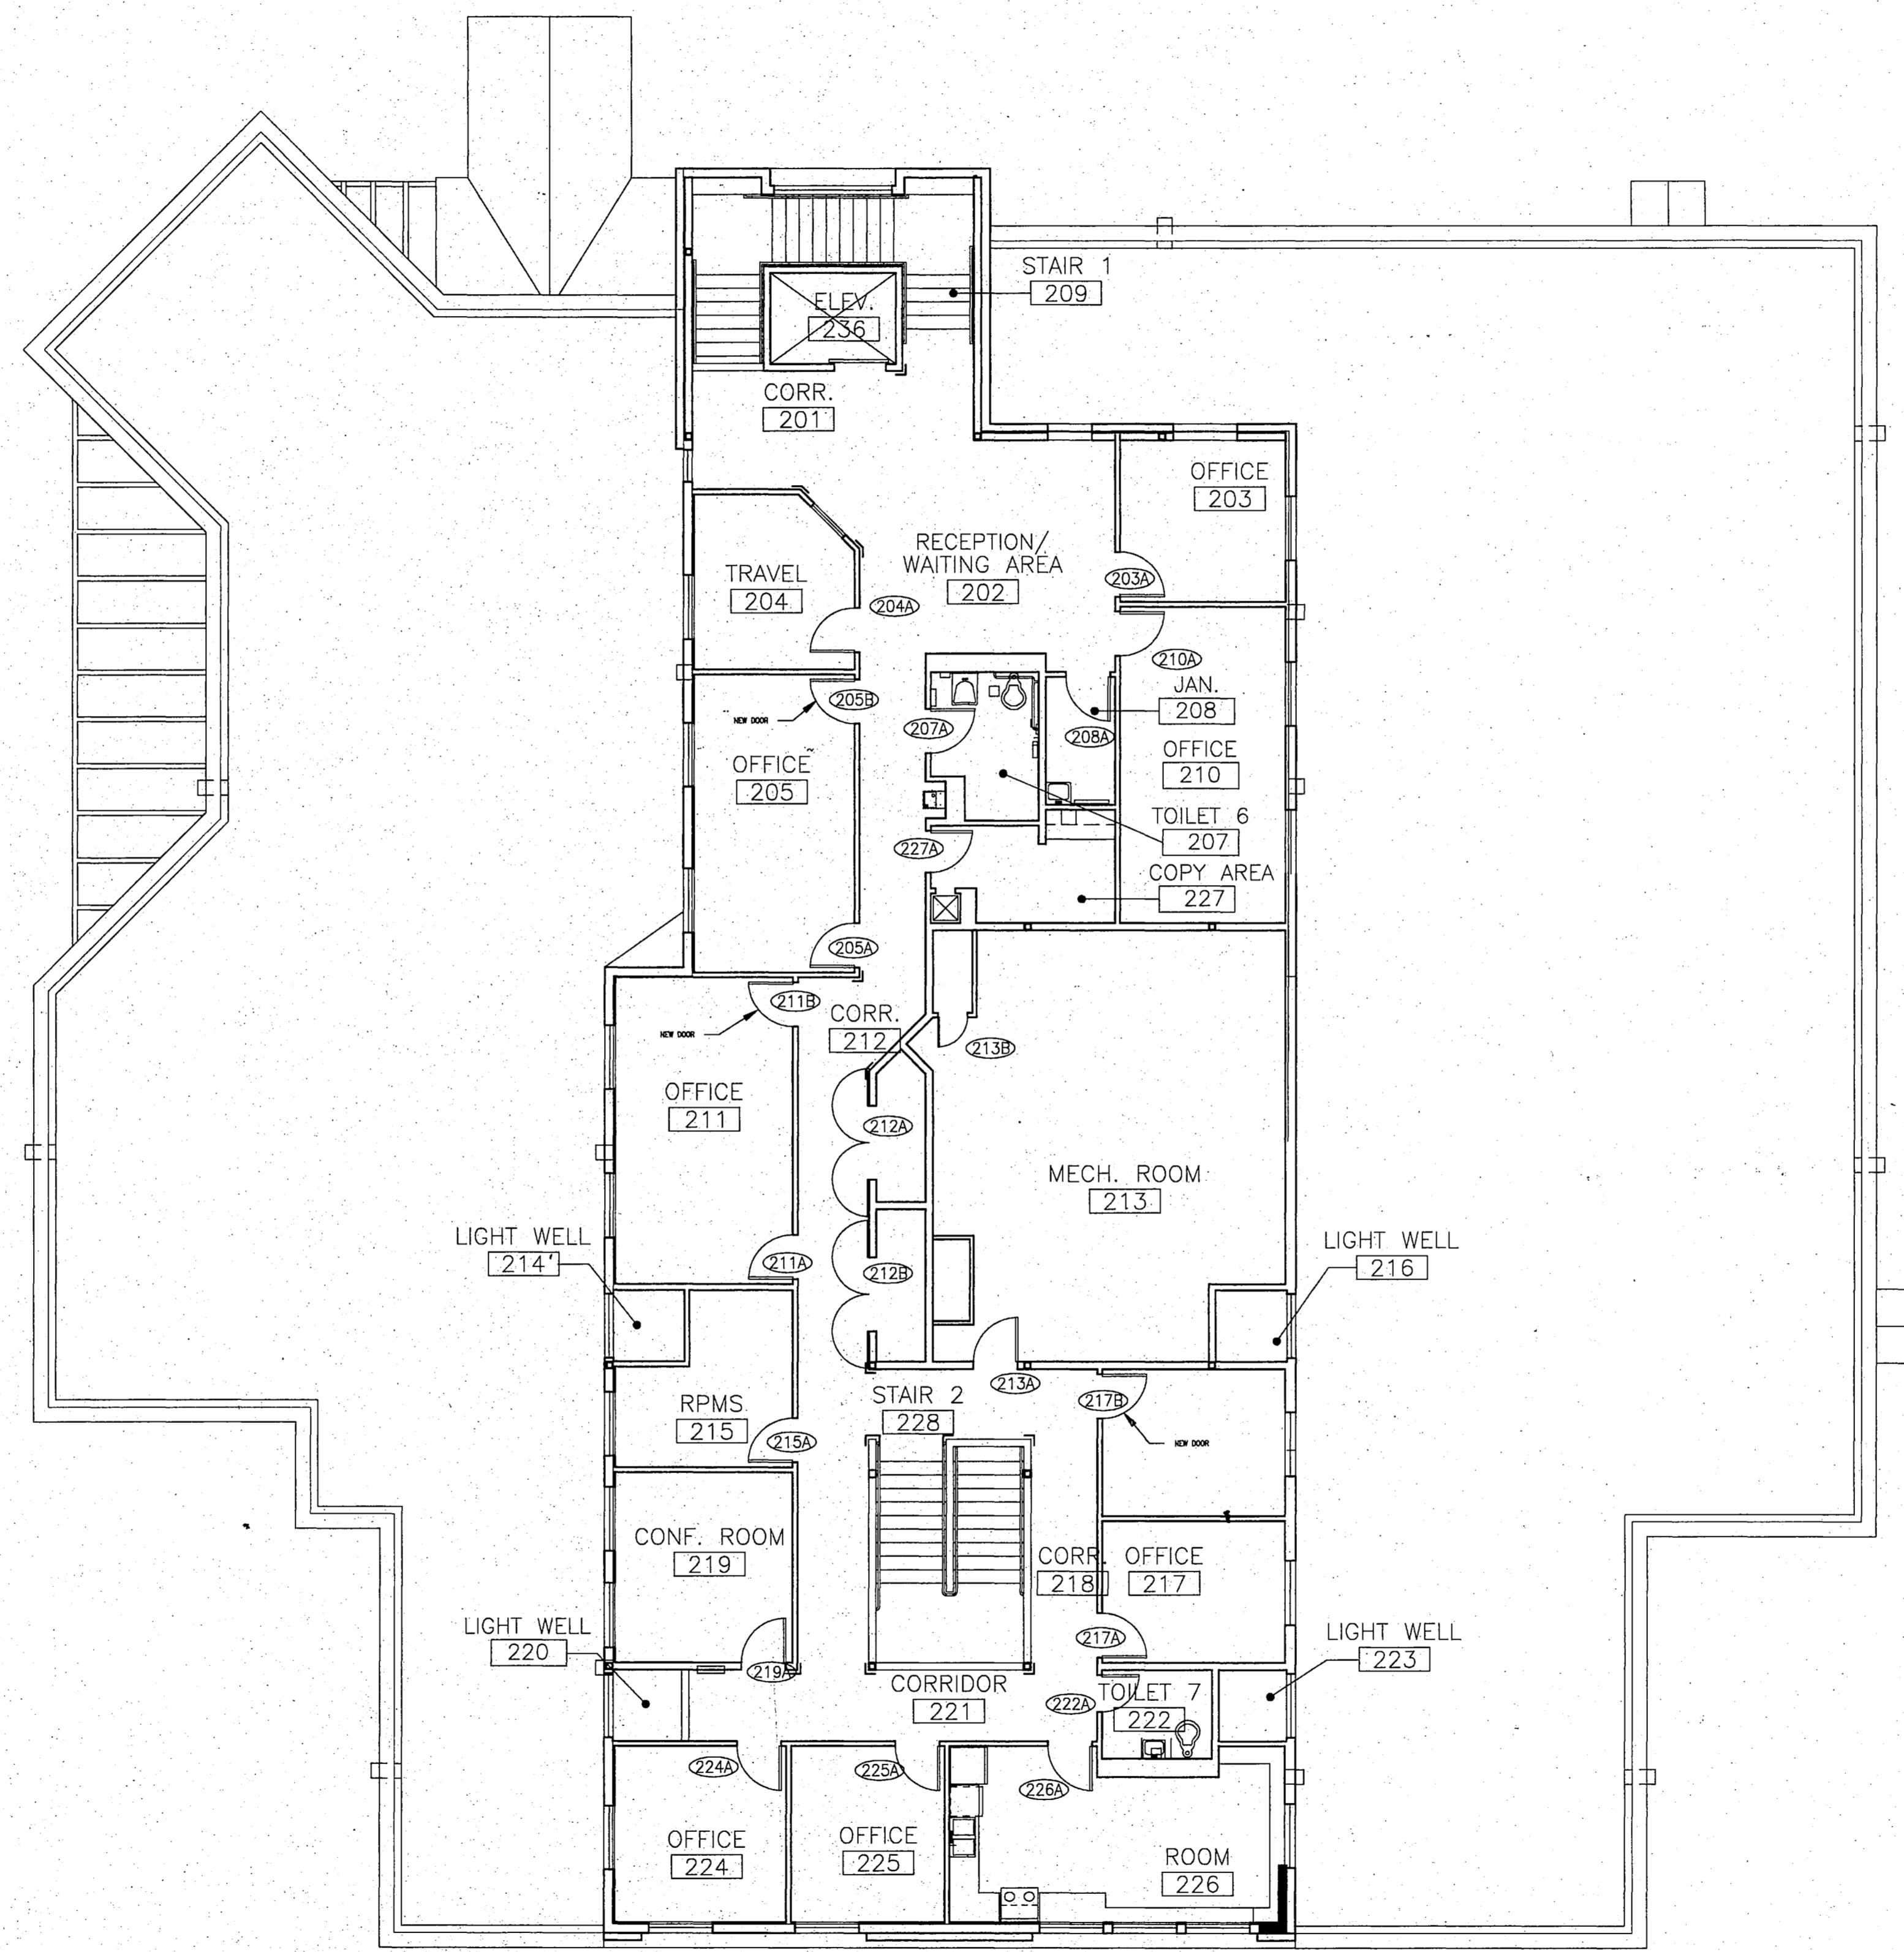

1 SECOND FLOOR PLAN – DOOR PLAN  
SCALE: 1/8" = 1'-0"



**RECORD  
DRAWING**

*R. B. Bend*  
CITY ENGINEER, CITY OF FAIRBANKS  
4/8/96  
DATE

**A 17.1**


PROJECT NO. 115.00  
DRAWN BY RGB  
CHECKED BY RGB  
DATE JAN 1994

TITLE  
**SECOND LEVEL  
DOOR  
PLAN**  
SHEET NO.

# FAIRBANKS HEALTH CENTER

Fairbanks, Alaska


City of Fairbanks

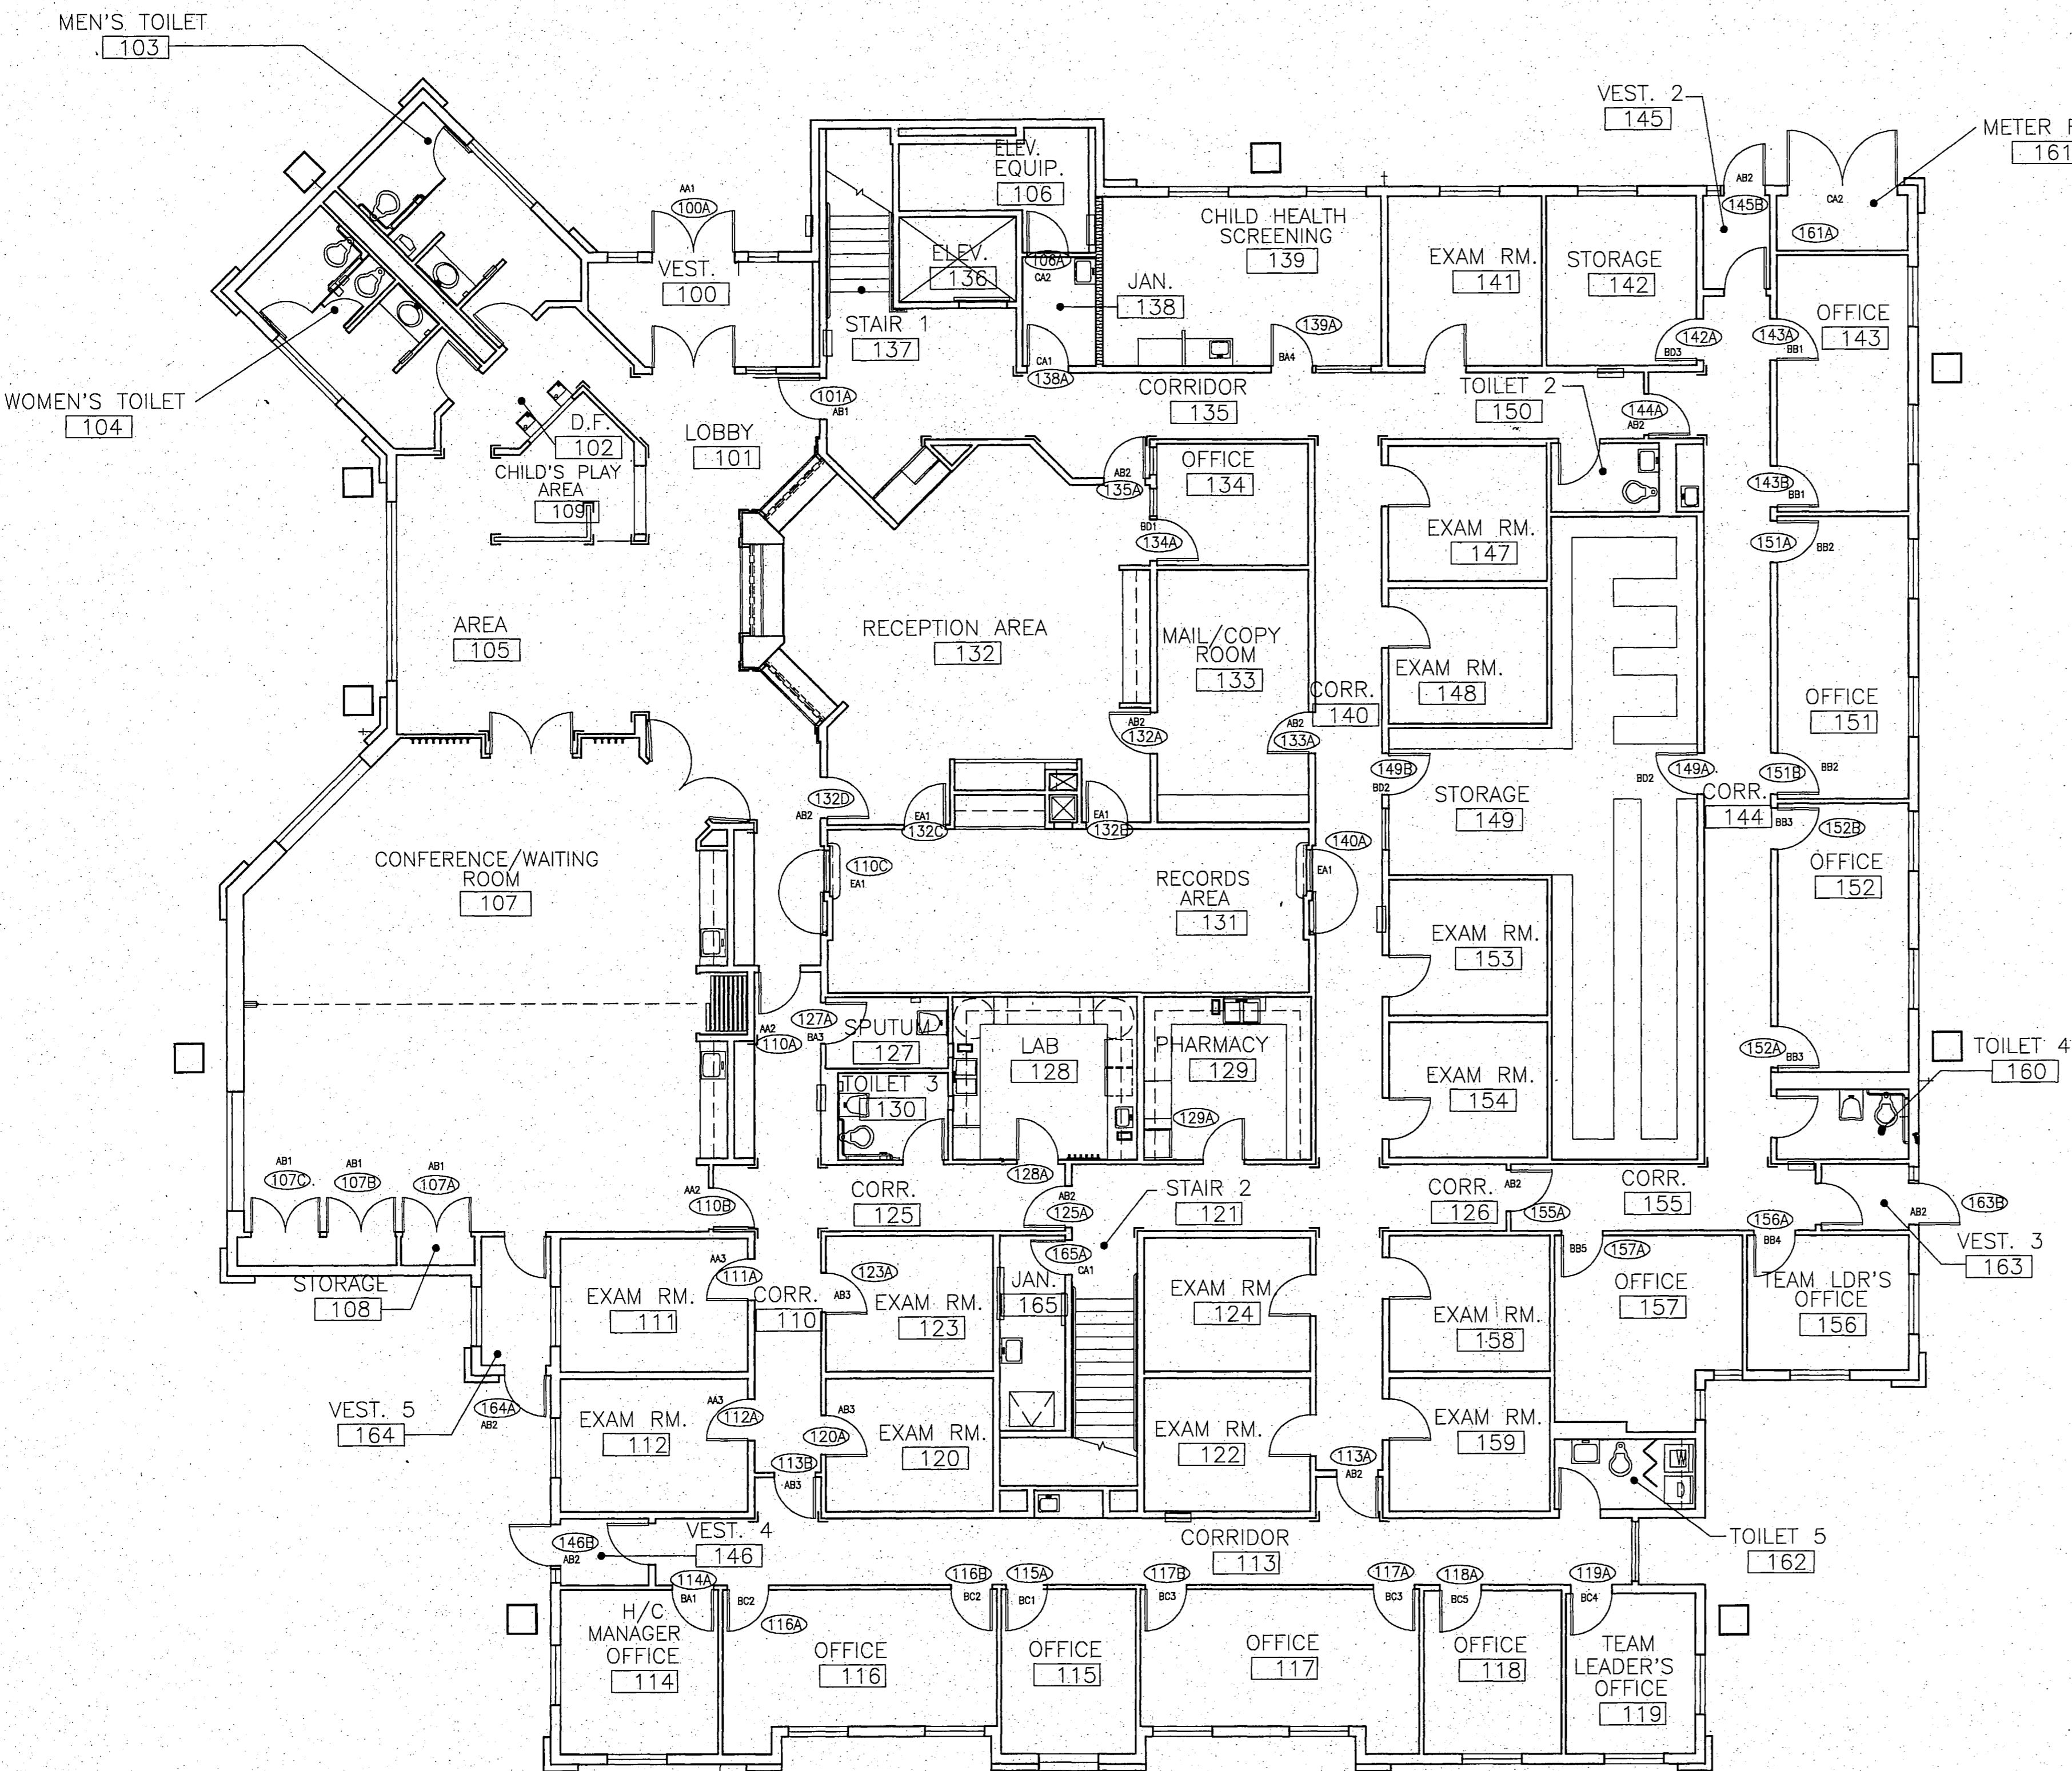

Fairbanks, Alaska

**FAIRBANKS HEALTH CENTER**

City of Fairbanks

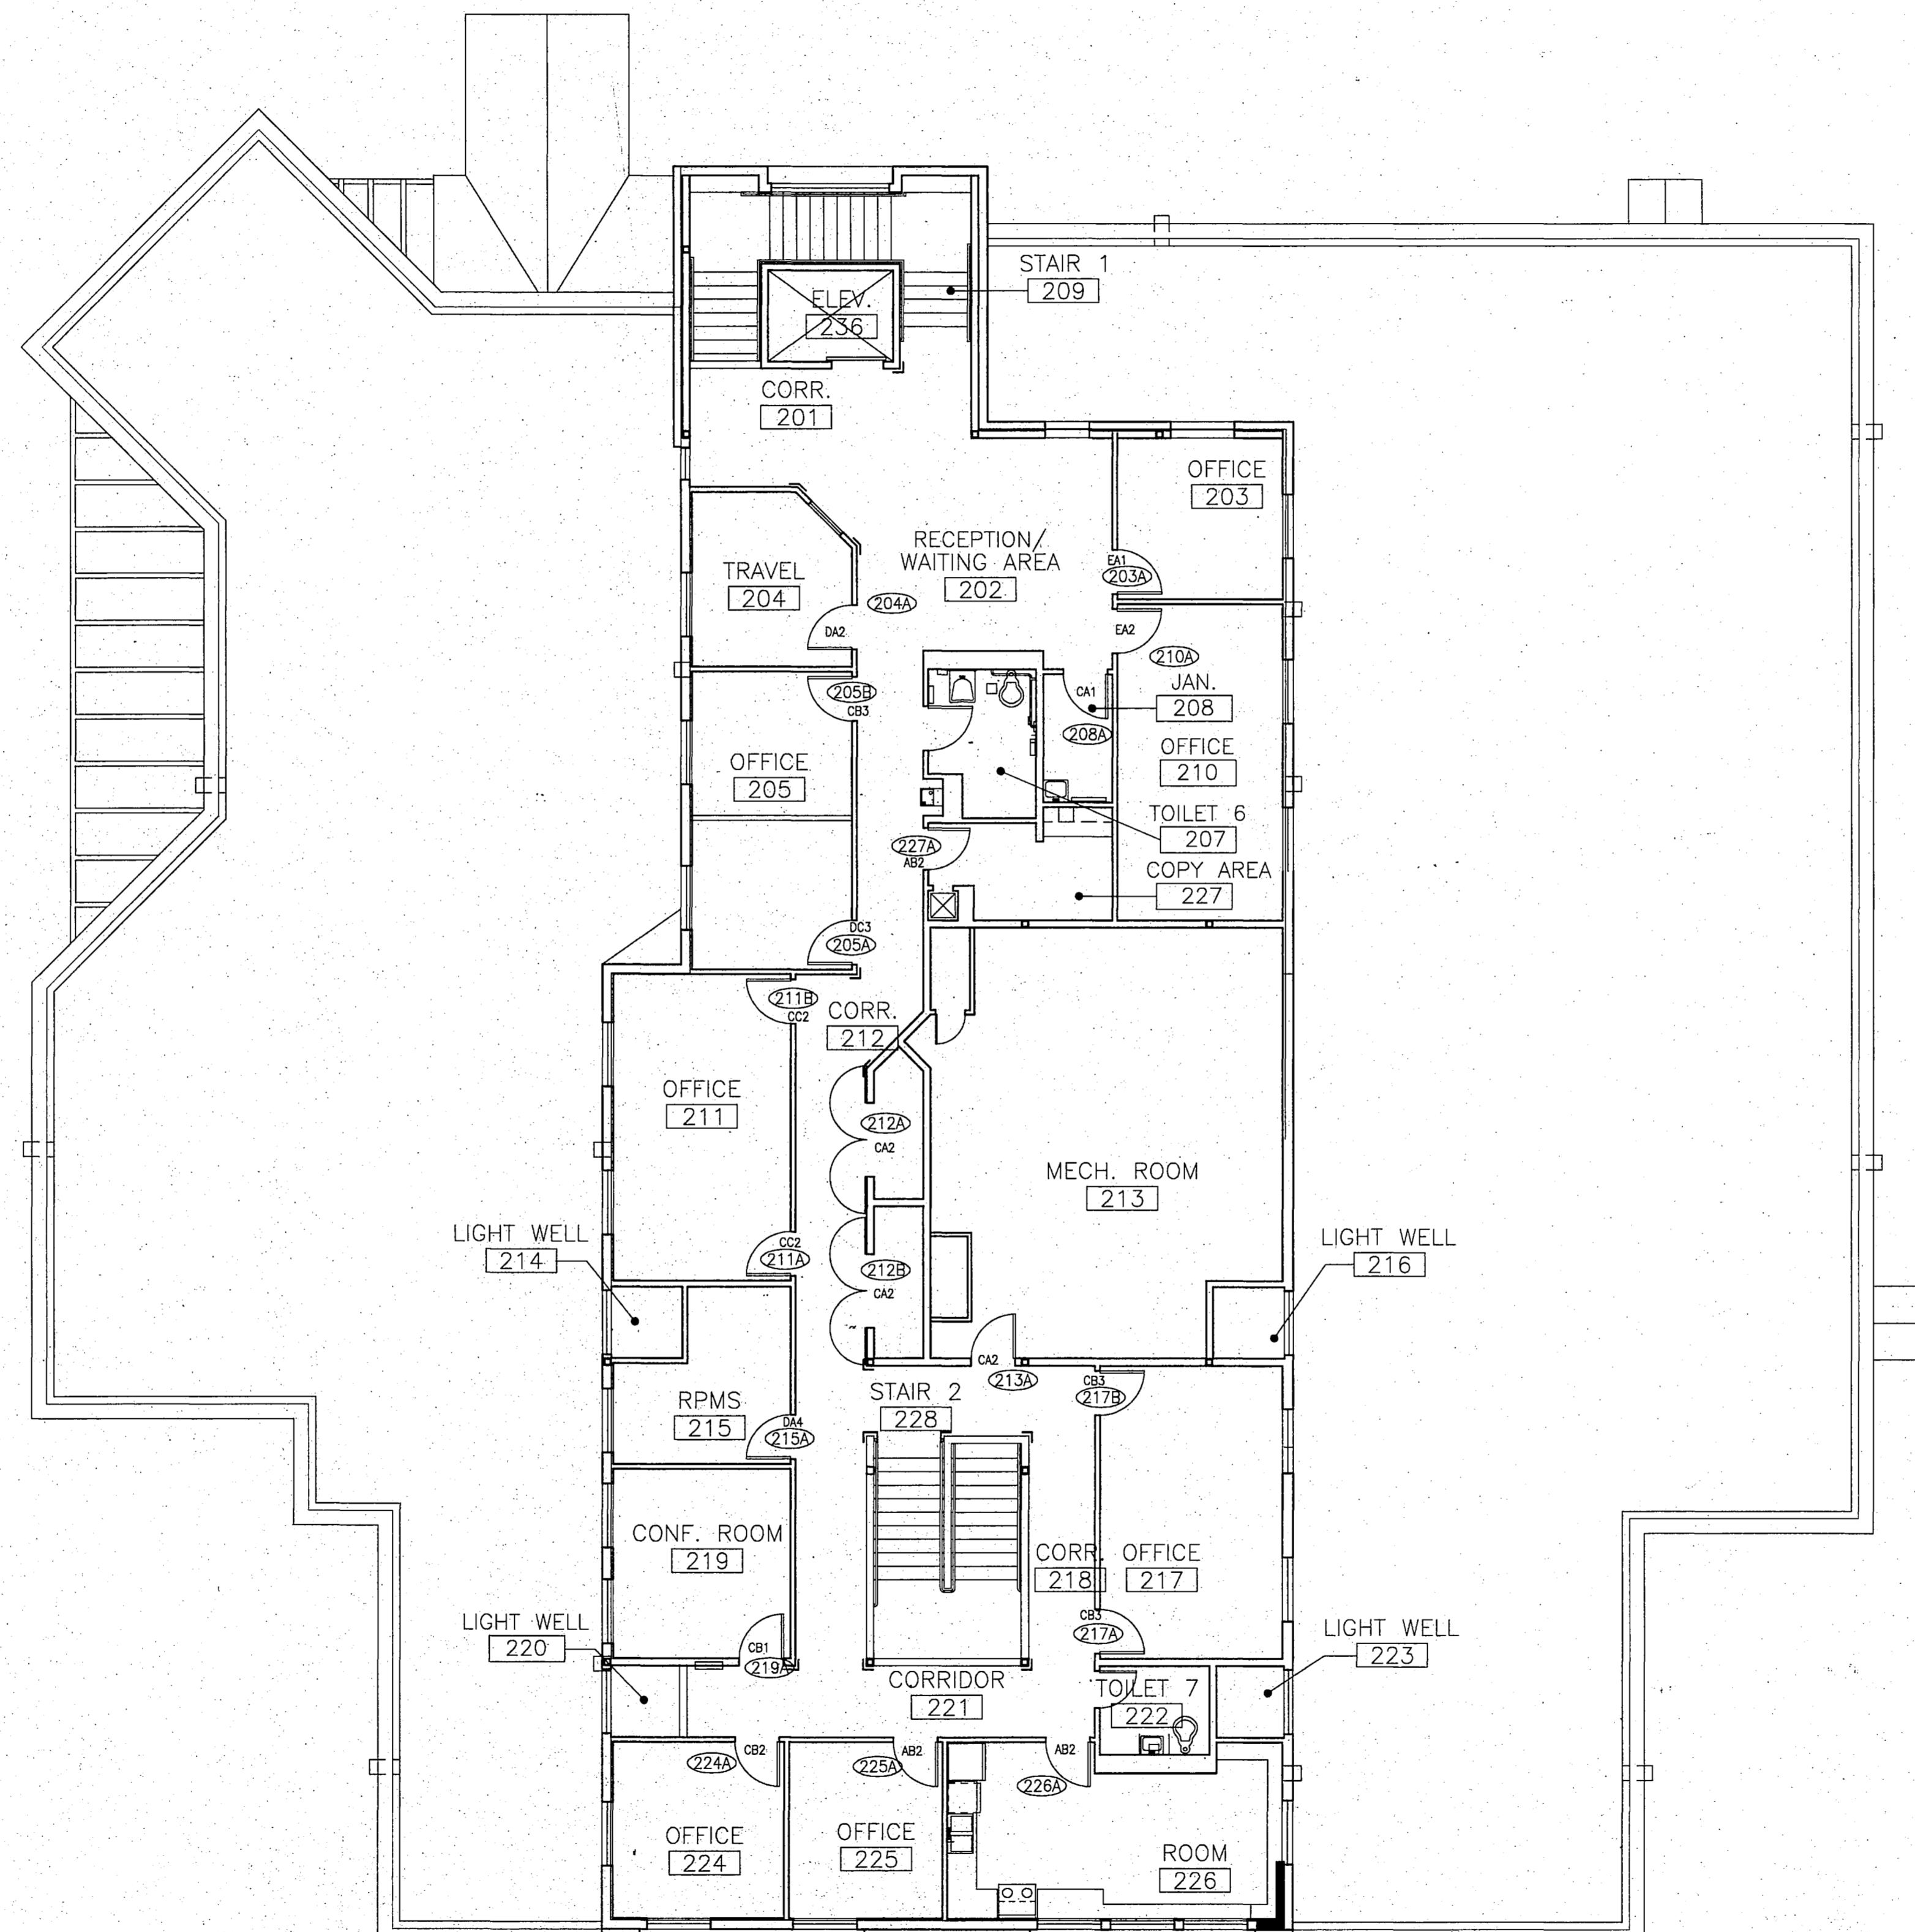


1 SECOND FLOOR PLAN - KEYING PLAN  
SCALE: 1/8" = 1'-0"

**RECORD  
DRAWING**

PROJECT NO. 115.00  
DRAWN BY RBB  
CHECKED BY RBB  
DATE JAN 1994


TITLE  
**SECOND LEVEL  
KEYING  
PLAN**  
SHEET NO.

*Ruben D. Beaudet*  
CITY ENGINEER, CITY OF FAIRBANKS  
4/8/96  
DATE

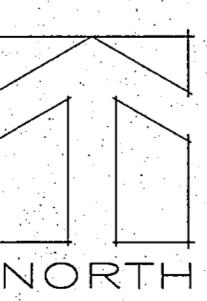

**A 18.1**

F 3.0.050

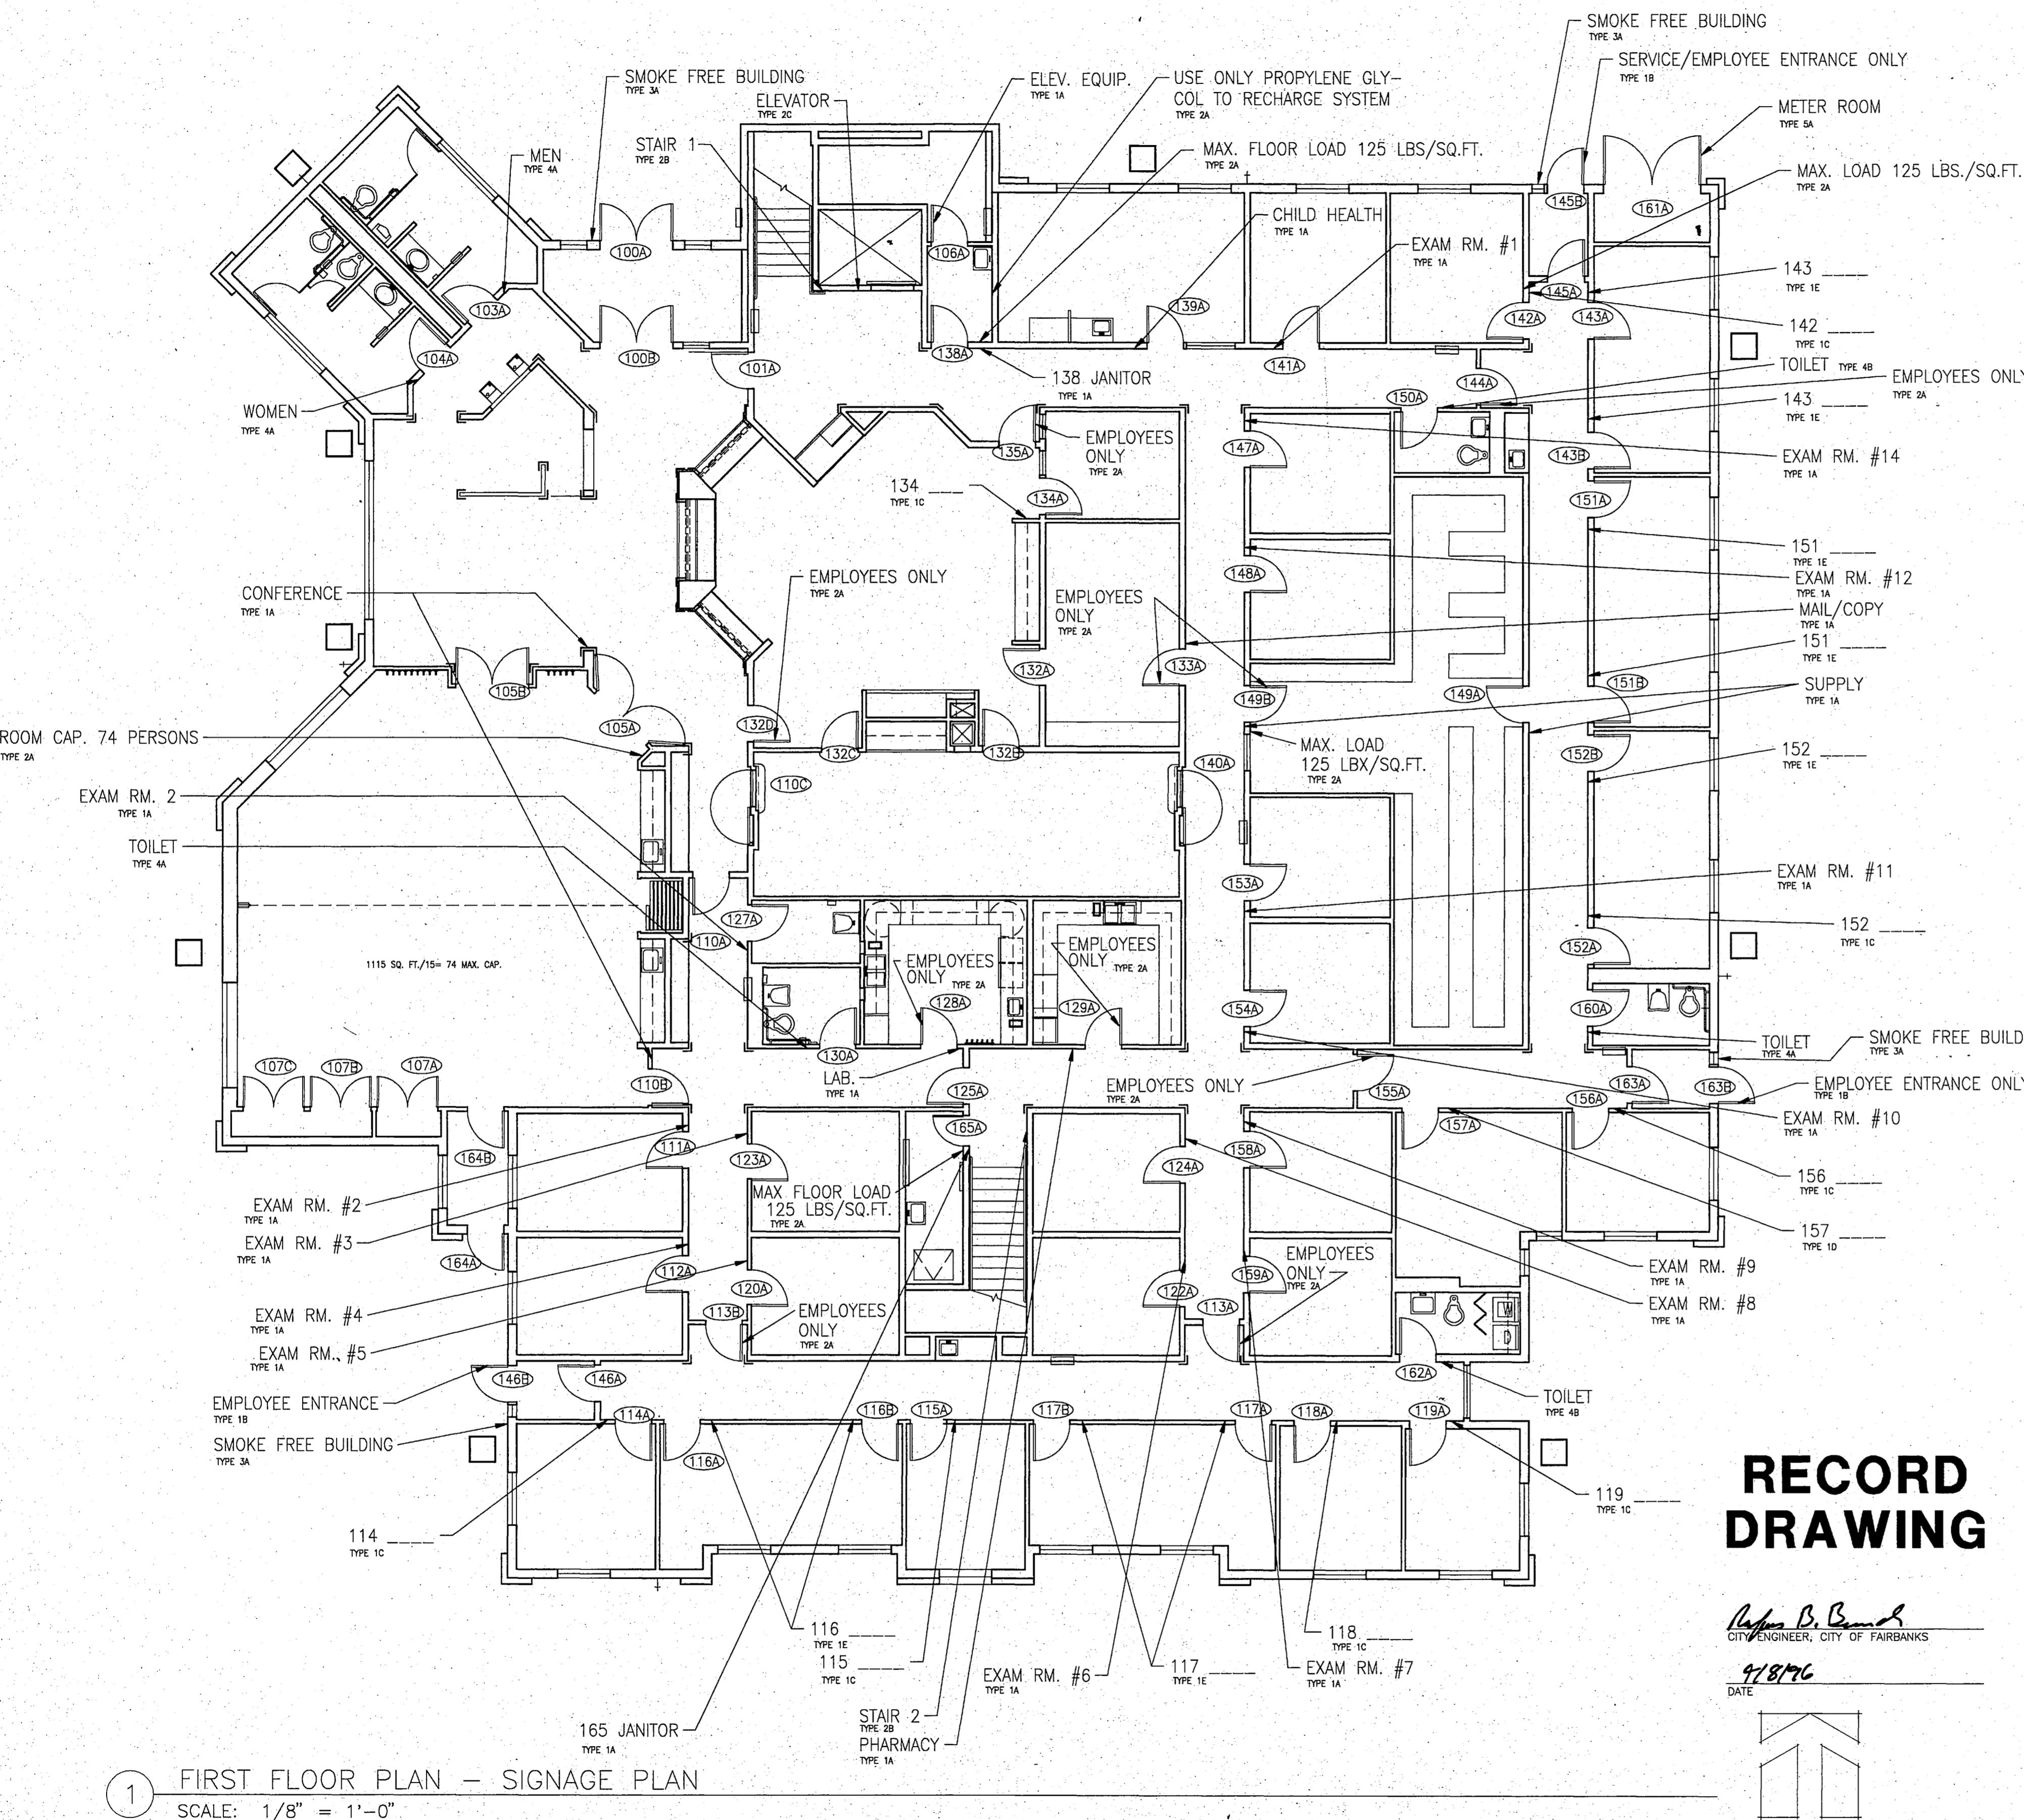

SIGNAGE SCHEDULE			
TYPE	ROOM NO.	QUANT.	SIGN TEXT
1A	105	2	CONFERENCE
106	1	ELEV. EQUIP.	
111	1	EXAM RM. #2	
112	1	EXAM RM. #4	
120	1	EXAM RM. #5	
122	1	EXAM RM. #6	
123	1	EXAM RM. #3	
124	1	EXAM RM. #8	
127	1	EXAM RM. #1	
128	1	LAB	
129	1	PHARMACY	
133	1	MAIL/COPY	
138	1	138 JANITOR	
139	1	CHILD HEALTH	
141	1	EXAM RM. #15	
147	1	EXAM RM. #14	
148	1	EXAM RM. #12	
149	2	SUPPLY	
153	1	EXAM RM. #11	
154	1	EXAM RM. #10	
158	1	EXAM RM. #9	
159	1	EXAM RM. #7	
165	1	165 JANITOR	
208	1	208 JANITOR	
212	1	TELEPHONE	
212	1	ELECTRICAL	
213	1	MECHANICAL	
213	1	DAY TANK	
226	1	RESOURCE	
227	1	COPY	
1B	145	1	EMPLOYEE/SERVICE ENTRANCE ONLY
146	1	EMPLOYEE ENTRANCE ONLY	
163	1	EMPLOYEE ENTRANCE ONLY	
1C	114	1	114
115	1	115	
118	1	118	
119	1	119	
134	1	134	
142	1	142	
156	1	156	
203	1	203	
204	1	204	
205	1	205	
206	1	206	
210	1	210	
215	1	215	
224	1	224	
225	1	225	
1D	157	1	157
219	1	219	
1E	116	2	116
117	2	117	
143	2	143	
151	2	151	
152	2	152	
211	2	211	
217	2	217	
2A	105	1	ROOM CAP. 74 PERSONS
113	2	EMPLOYEES ONLY	
128	1	EMPLOYEES ONLY	
129	1	EMPLOYEES ONLY	
132	2	EMPLOYEES ONLY	
133	1	EMPLOYEES ONLY	
138	1	USE ONLY PROPYLENE GLYCOL TO RECHARGE SYSTEM	
138	1	MAX. FLOOR LOAD 125 LBS/SQ.FT.	
142	1	MAX. FLOOR LOAD 125 LBS/SQ.FT.	
149	1	EMPLOYEES ONLY	
149	1	MAX. FLOOR LOAD 125 LBS/SQ.FT.	
155	1	EMPLOYEES ONLY	
156	1	EMPLOYEES ONLY	
157	1	EMPLOYEE ENTRANCE ONLY	
158	1	EXAM RM. #10	
159	1	EXAM RM. #9	
160	1	EXAM RM. #8	
161	1	EXAM RM. #7	
162	1	TOILET	
163	1	TOILET	
164	1	TOILET	
165	1	TOILET	
166	1	TOILET	
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197	1	TOILET	
198	1	TOILET	
199	1	TOILET	
200	1	TOILET	
201	2	STAIR 1	
202	2	STAIR 2	
3A	100	1	SMOKE FREE BUILDING
145	1	SMOKE FREE BUILDING	
146	1	SMOKE FREE BUILDING	
163	1	SMOKE FREE BUILDING	
4A	103	1	MEN
104	1	WOMEN	
130	1	TOILET	
160	1	TOILET	
207	1	TOILET	
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4B	150	1	TOILET
162	1	TOILET	
5A	161	1	METER ROOM

TYPE DESCRIPTIONS:


- 1A - 4"X9" WITH 3/4" TEXT AND SIMILAR TO TYPE 1 ON SHEET 2 OF 3
- 1B - SAME AS 1A EXCEPT TO BE MOUNTED ON EXTERIOR
- 1C - 4"X9" WITH 3/4" TEXT, PROVIDE INSERT FOR ONE NAME
- 1D - 4"X9" WITH 3/4" TEXT, PROVIDE TWO INSERTS FOR NAMES
- 1E - 5"X9" WITH 3/4" TEXT, PROVIDE THREE INSERTS FOR NAMES
- 2A - 6"X9" WITH 3/4" TEXT, CENTERED MULTIPLE LINES ARE PERMITTED
- 2B - 9"X9" W/ 3/4" TEXT AND INCLUDE STAIR SYMBOL
- 2C - 9"X9" W/ 3/4" TEXT AND INCLUDE ELEVATOR SYMBOL
- 3A - 9"X6" W/ 3/4" TEXT & SYMBOL, SIM. TO TYPE 3 ON SHEET 2 OF 3, MOUNTED ON EXTERIOR
- 4A - 9"X9" W/ 3/4" TEXT & SYMBOL INDICATED PLUS ACCESS SYMBOL
- 4B - 9"X9" W/ 3/4" TEXT & SYMBOL INDICATED (NO ACCESS SYMBOL REQUIRED)
- 5A - 2"X9" W/ 1" TEXT, MOUNTED ON EXTERIOR

PROJECT NO. 115.00  
DRAWN BY RBB  
CHECKED BY RBB  
DATE MAR 1994  
  
TITLE FIRST LEVEL SIGNAGE PLAN  
SHEET NO. A 19.0

## HARIBANKS HEALTH CENTER

卷之三

## City of Fairbanks

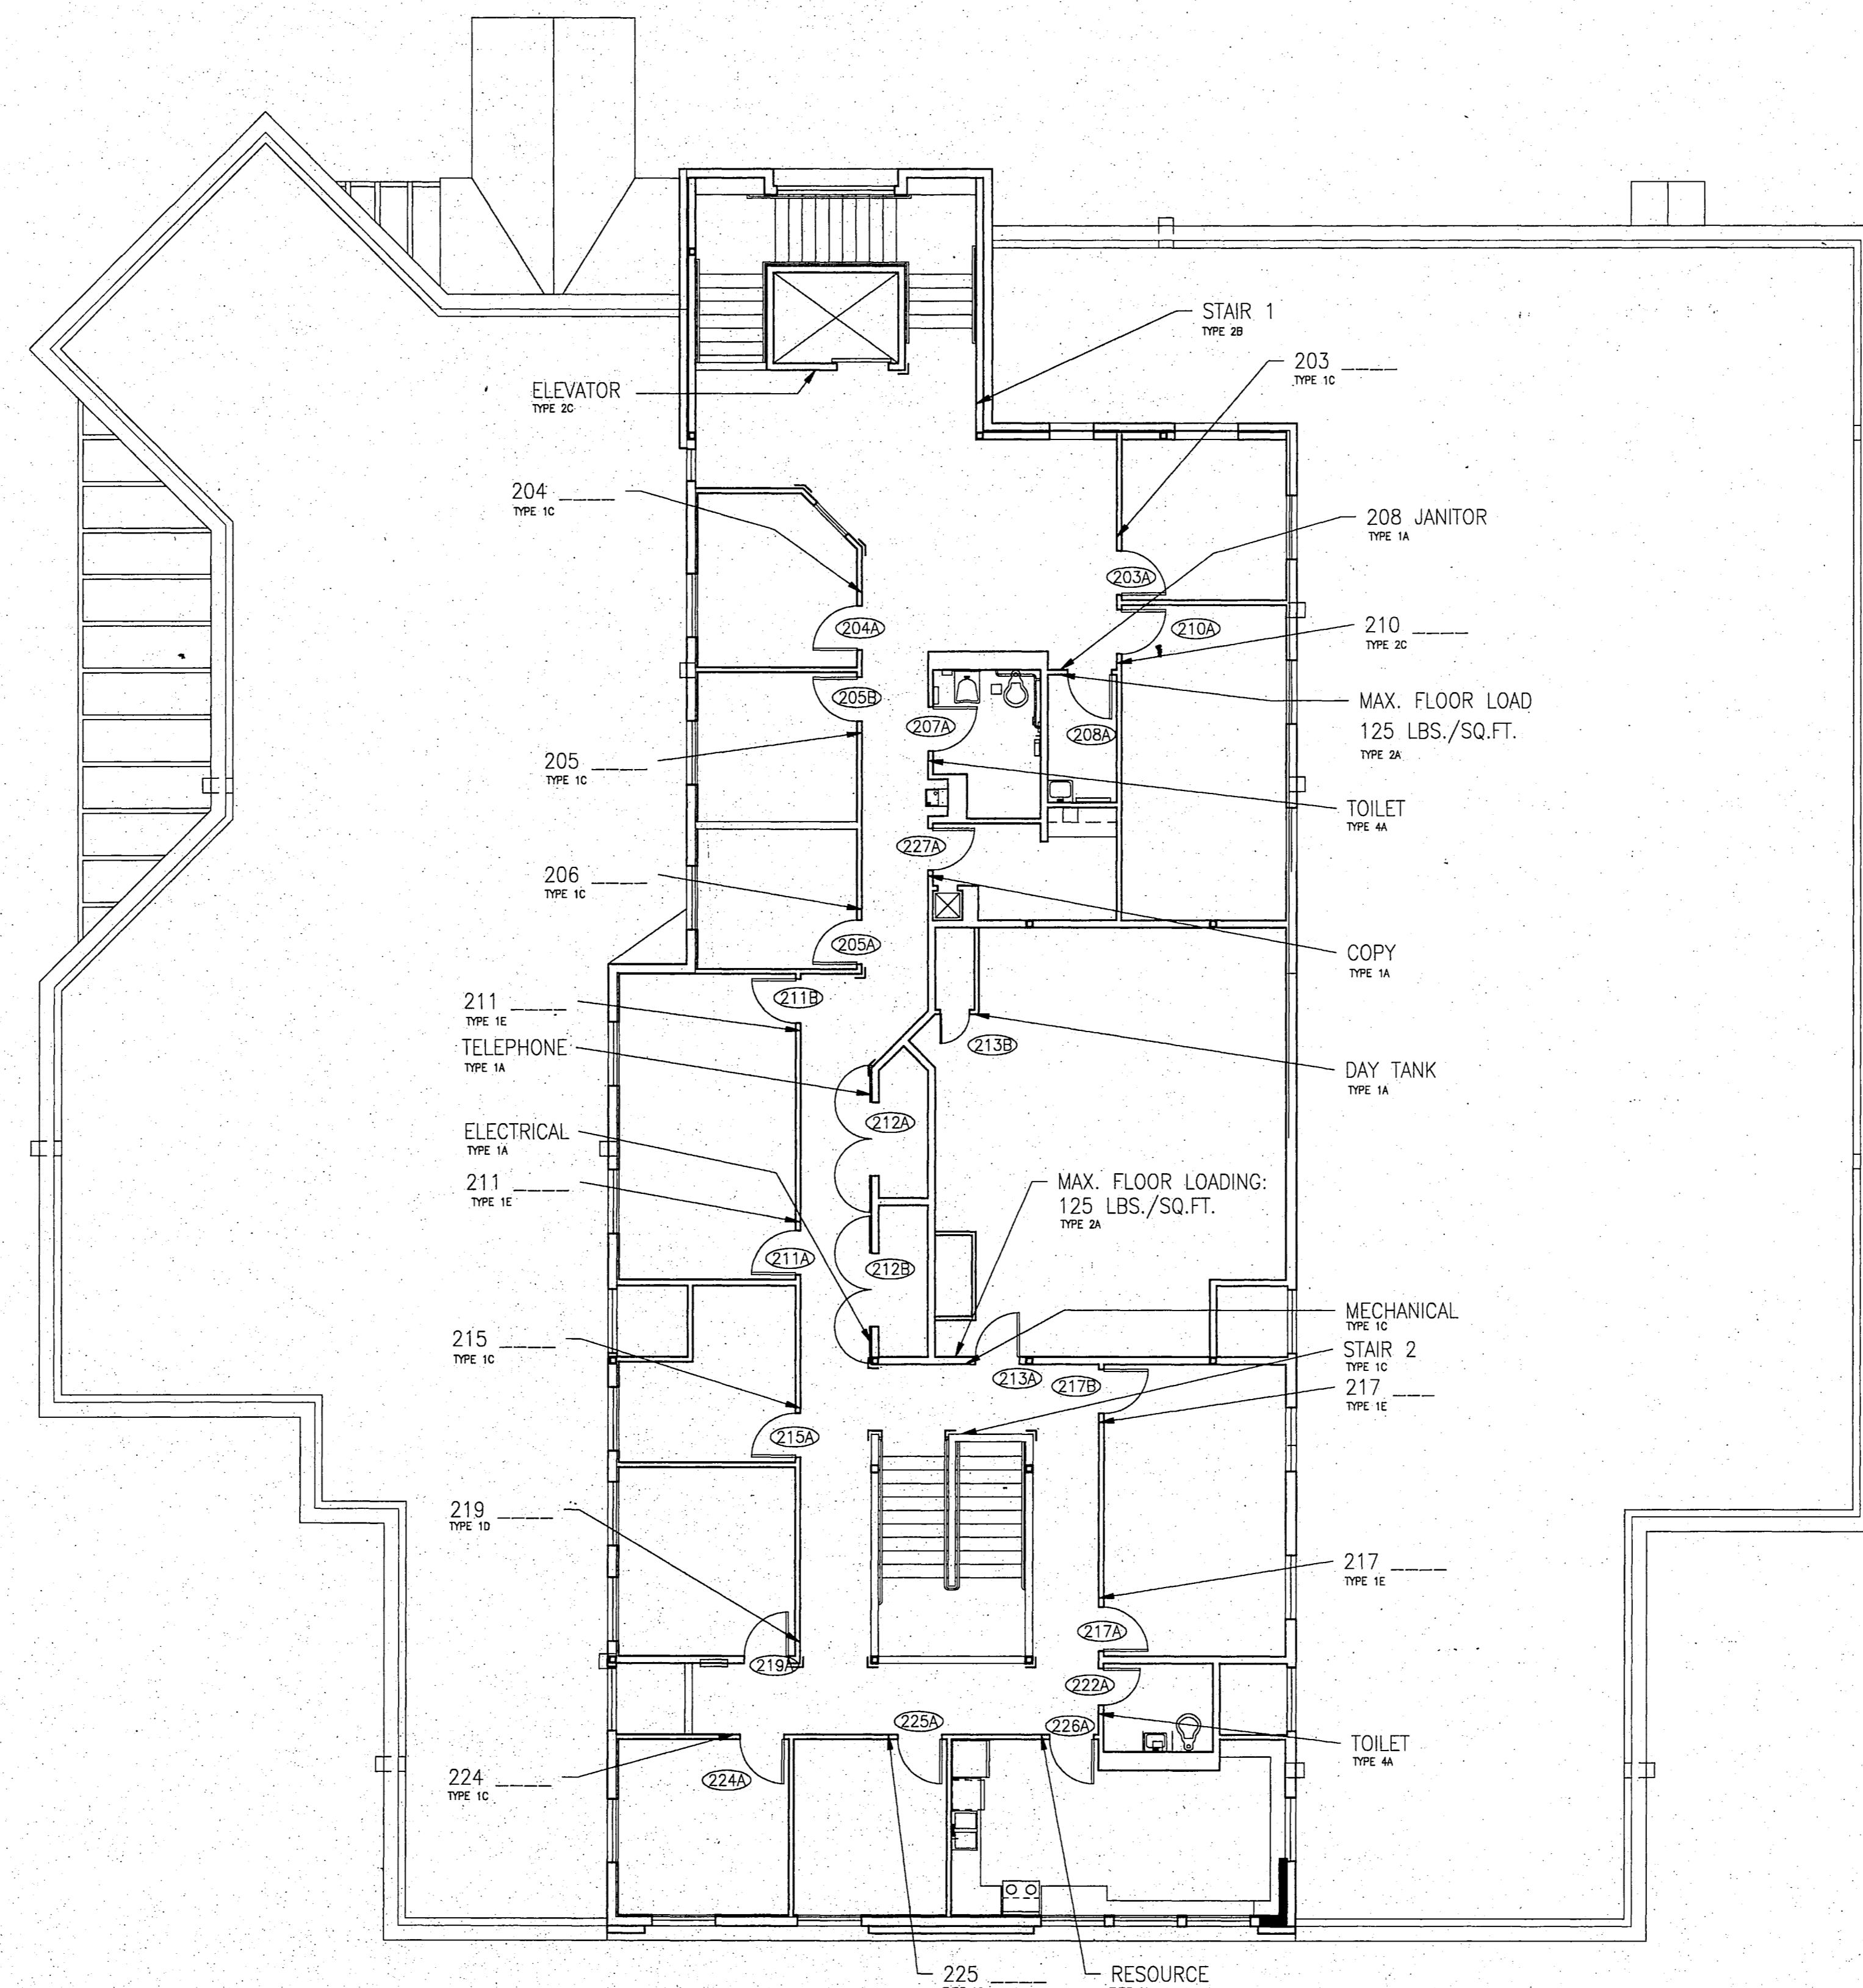

1 SECOND FLOOR PLAN - SIGNAGE PLAN  
SCALE: 1/8" = 1'-0"

SCALE: 1/8" = 1'-0"

# **RECORD DRAWING**

Rufus B. Brundage  
CITY ENGINEER, CITY OF FAIRBANKS  
4/8/96  
DATE

A compass rose diagram consisting of two intersecting lines forming a cross. The vertical line has an arrowhead pointing upwards, and the horizontal line has an arrowhead pointing to the left. Below the intersection, the word "NORTH" is printed in capital letters.

**PROJECT NO.** 115.00  
**DRAWN BY** RBB  
**CHECKED BY** RBB  
**DATE** MAR 1004

# **SECOND FLOOR SIGNAGE PLAN**


SHEET NO.

A 19.1

# FAIRBANKS HEALTH CENTER

Fairbanks, Alaska

City of Fairbanks

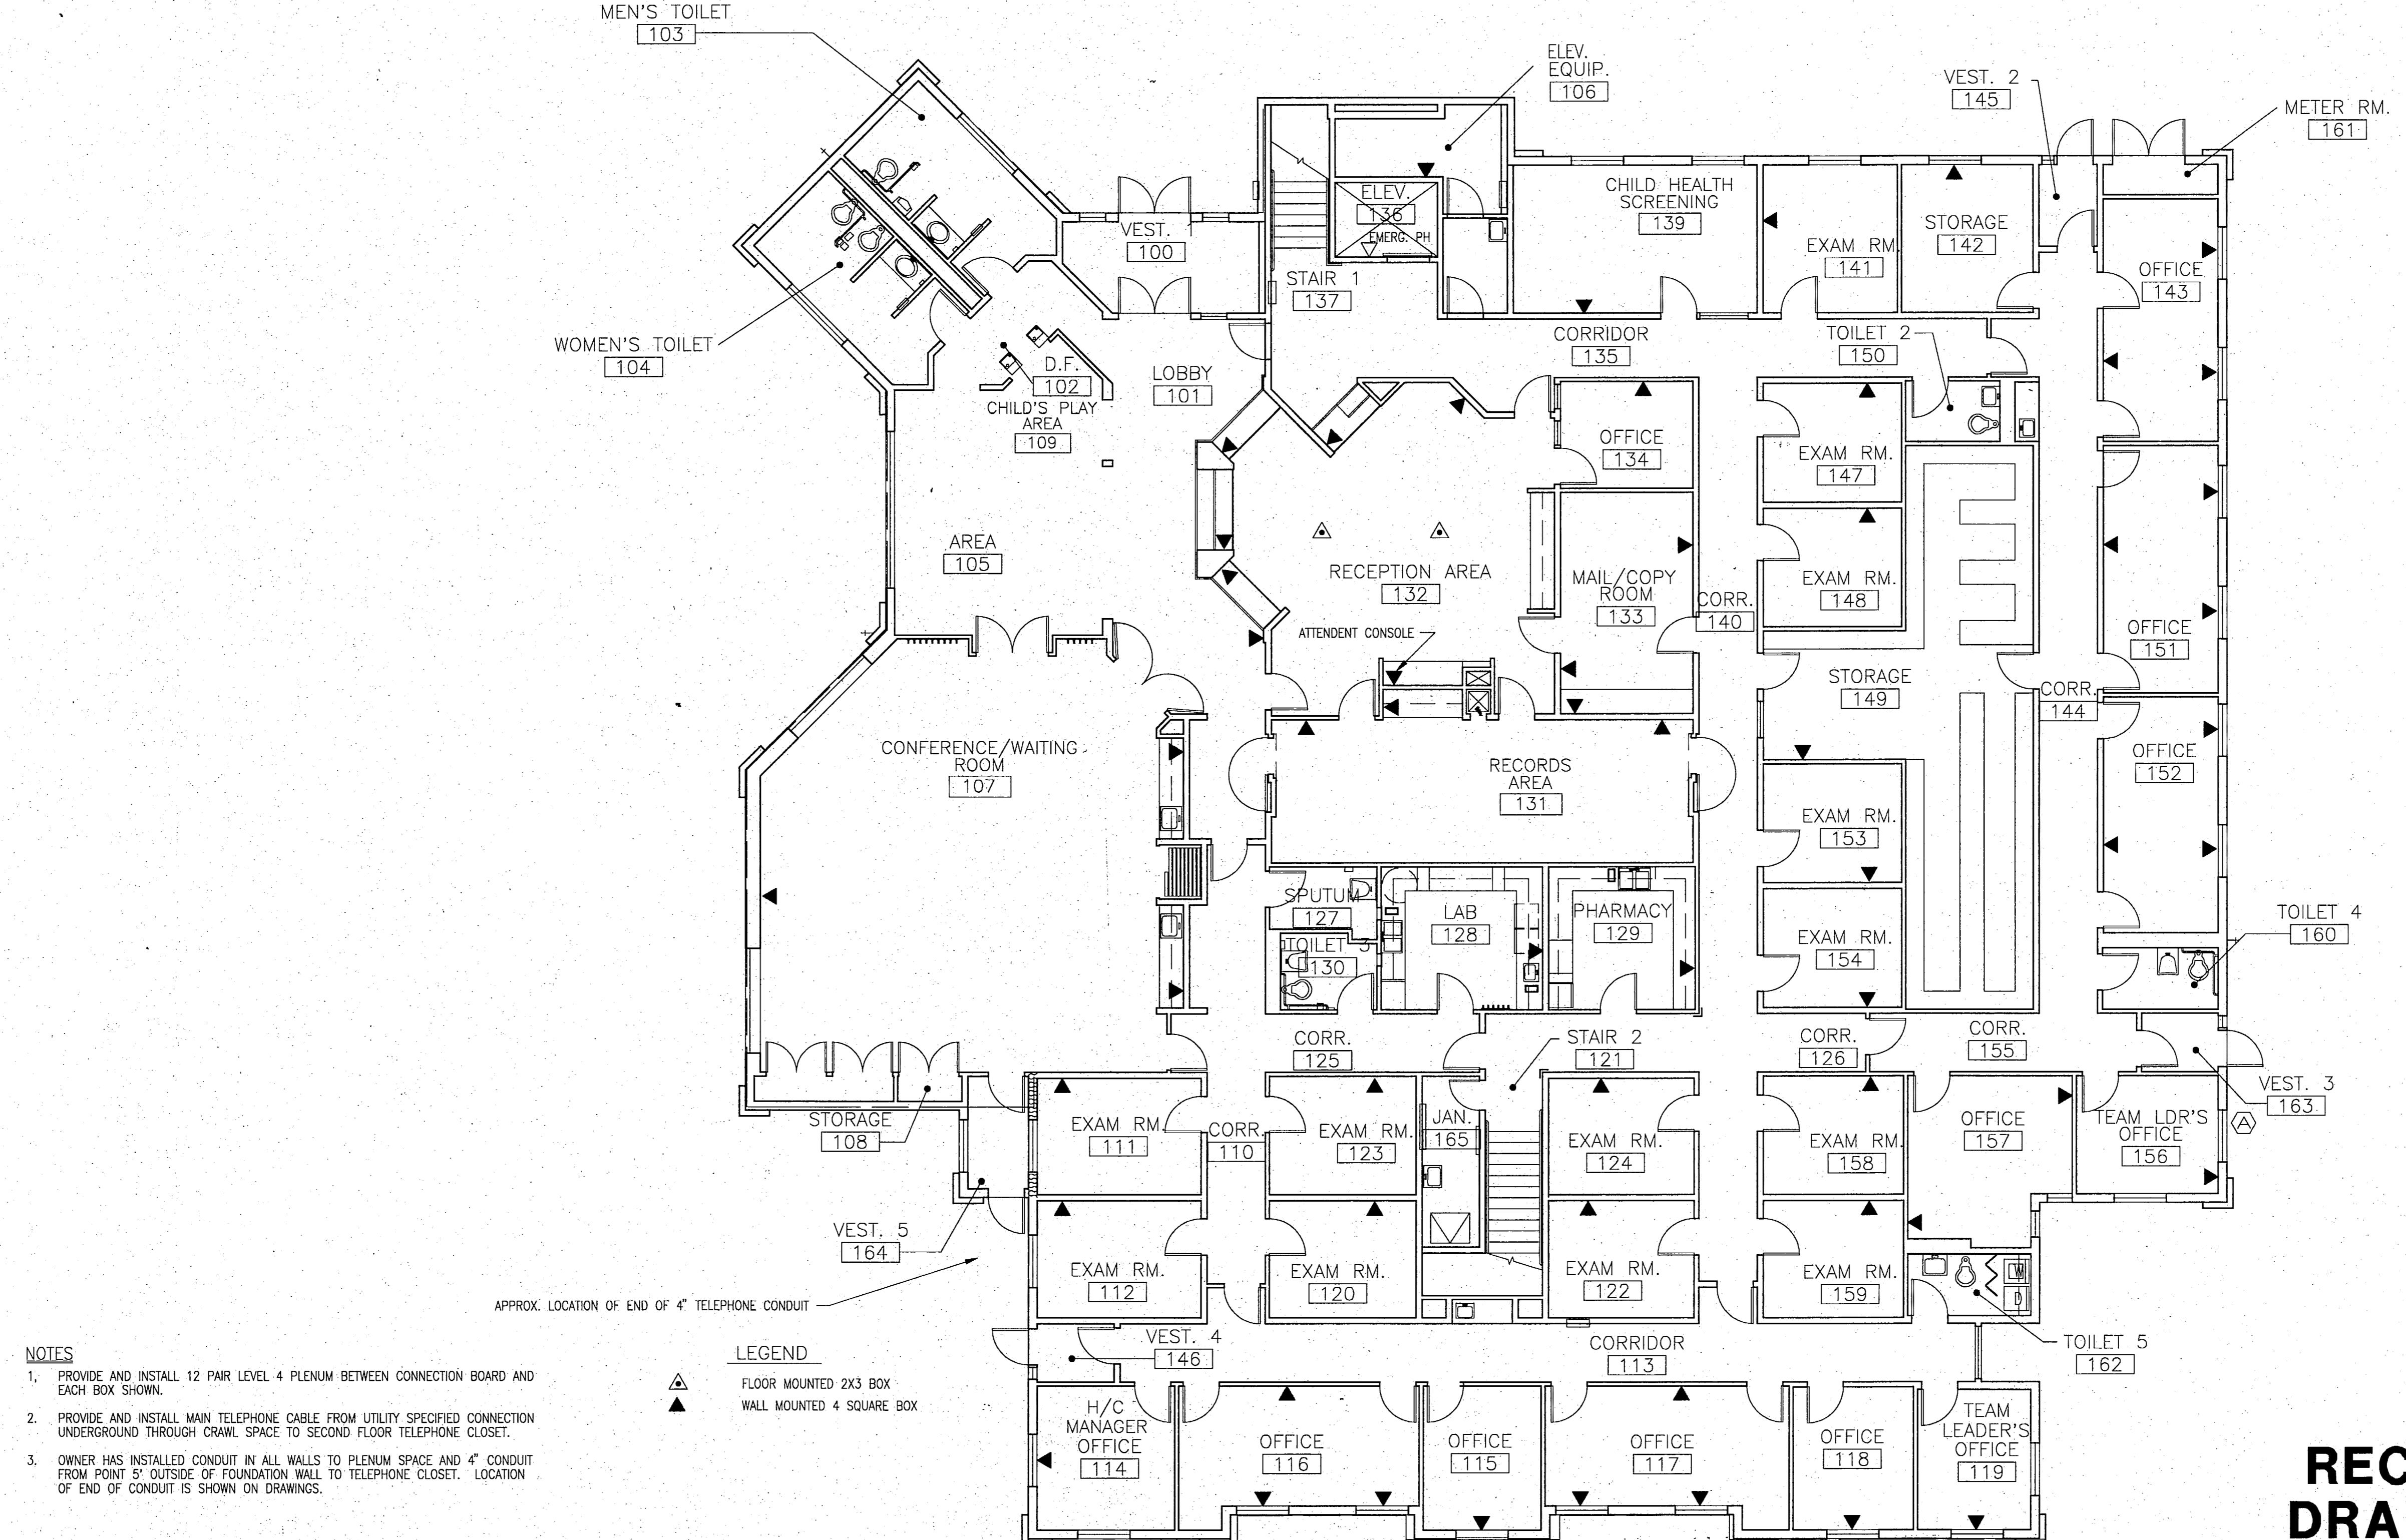

1 FIRST FLOOR PLAN - TELEPHONE  
SCALE: 1/8" = 1'-0"

**RECORD  
DRAWING**

*Charles B. Bond*  
CITY ENGINEER, CITY OF FAIRBANKS  
4/18/96  
DATE

