
Boney Courthouse Generator Replacement

303 K Street Anchorage, Alaska 99501

CONSTRUCTION DOCUMENTS

03/06/2024

PROJECT LOCATION MAP

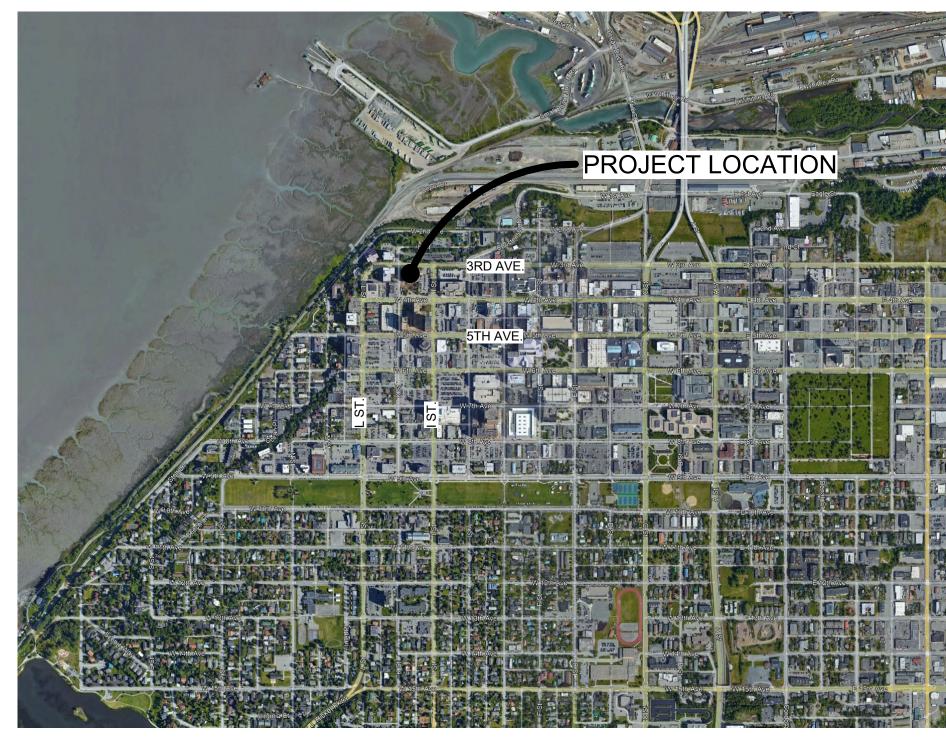


CODE ANALYSIS

CODE ANALYSIS
ORIGINAL CONSTRUCTION: 1972

EGRESS PATH: NO MODIFICATIONS



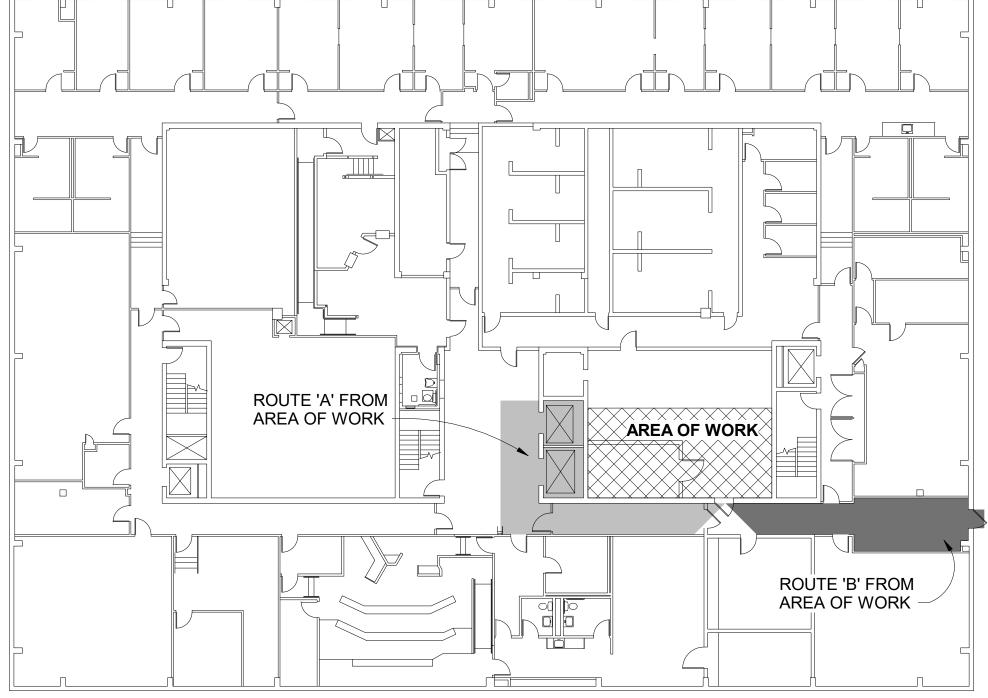

REFERENCE FLOOR PLAN - BASEMENT

CONTRACTOR SEQUENCING / STAGING INFORMATION

REFER TO 01 1400 WORK RESTRICTIONS FOR POSSIBLE ON-SITE PARKING SPACES THAT MAY BE PROVIDED FOR CONTRACTOR'S USE AT OWNER'S DISCRETION. CONTRACTOR SHALL SECURE ALL NECESSARY STORAGE AND STAGING AREAS AS REQUIRED FOR THE PROJECT.

CONTRACTOR SHALL COORDINATE BUILDING ACCESS WITH OWNER AND AS STIPULATED UNDER DIVISION 00 AND 01. THE EAST ENTRANCE, WHICH IS THE EMPLOYEE ENTRANCE MAY BE USED WITH PROPER APPROVAL AND COORDINATION WITH OWNER, BUT CANNOT BE BLOCKED OR OTHERWISE IMPEDE FROM USE ON A REGULAR AND DAILY BASIS BY EMPLOYEES. CONTRACTOR SHALL NOTE THAT THIS FACILITY PROVIDES SERVICES ON A 24/7 BASIS.

CONTRACTOR MAY ELECT TO MOVE MATERIALS IN TO THE AREA OF WORK THROUGH TWO ROUTES: ROUTE 'A' IS THROUGH THE MAIN OR EAST ENTRANCE DOORS OF THE BONEY COURTHOUSE AND VIA THE EXISTING ELEVATORS DOWN TO THE BASEMENT LEVEL. EXISTING ELEVATORS HAVE A POSTED WEIGHT CAPACITY OF 3,500 LBS.

ROUTE 'B' IS THROUGH THE ADJACENT FACILITY, NESBETT COURTHOUSE, THROUGH THE MAIN ENTRANCE DOORS, OR AS COORDINATED WITH OWNER, AND VIA EXISTING ELEVATORS DOWN TO THE BASEMENT LEVEL. THE EXISTING ELEVATORS HAVE A POSTED WEIGHT CAPACITY OF 4,000 LBS. THE CONTRACTOR WILL BE REQUIRED TO MOVE MATERIALS THROUGH THE CONNECTING CORRIDOR AT THE BASEMENT LEVEL, AND SHALL COORDINATE ACCESS THROUGH CONTROLLED DOORS AT THE CONNECTING

INDEX OF DRAWINGS

GENERAL

G001 COVER SHEET, PROJECT LOCATION MAP, CODE ANALYSIS, DRAWING INDEX

MECHANICAL

MECHANICAL LEGENDS, ABBREVIATIONS AND SCHEDULES

BASEMENT CORRIDOR 1ST FLOOR HVAC REMODEL

EGEND, ONE-LINE DIAGRAMS, AND LOAD CALCULATIONS

ELECTRICAL DEMOLITION PLAN

E201 ELECTRICAL REMODEL PLANS E301 PANEL SCHEDULES

PROJECT TEAM



421 W. 1st Avenue, Suite 300 Anchorage, Alaska 99501 907.563.8474 > exploredesign.com



191 E. Swanson Avenue, Suite 101 2522 Arctic Boulevard, Suite 200 Anchorage, AK 99503 (907) 276-0521 Wasilla, Alaska 99654 (907) 357-1521

FOR: SUBMITTAL PRICING

> **COVER SHEET** PROJECT **LOCATION MAP** CODE ANALYSIS. DRAWING INDEX

SHEET NO.

G001

RADIATOR SCHEDULE

		7——																							
						CIRCUIT 1						CIRCUIT 2						FAN							
							BTU/MIN		EGT	LGT	WPD		BTU/MIN		EGT	LGT	WPD								
SYMBOL	MANUFACTURER	MODEL	SERVES	SERVICE	ORIENTATION	MEDIUM	REMOVED	GPM	DEG F	DEG F	FD HD	MEDIUM	REMOVED	GPM	DEG F	DEG F	FD HD	CFM	HP	POWER	DRIVE	RPM REMARKS			
RAD-1	YOUNGTOUCHSTONE	VM04F512331H233	GEN	JACKET WATER	HORIZONTAL	50% E.G.	3,435	45	210.0	199.7	5.8	50% E.G.	1,083	50	127.0	124.0	8.8	4,002	1.5	460/60/3	DIRECT	1,160 3" NPT CIF	RCUIT 1, 2" NPT CIRCUIT 2.	•	!

REMOTE CHARGE AIR COOLER SCHEDULE

1 1210		/ III (000EEI (
						COLD SID	E				HOT SIDE	-				
					BTU/MIN			EGT	LGT	WPD			EAT	LAT	WPD	
SYMBOL	MANUFACTURER	MODEL	SERVES	SERVICE	REMOVED	MEDIUM	GPM	DEG F	DEG F	FT HD	MEDIUM	SCFM	DEG F	DEG F	FT HD	REMARKS
CAC-1	YOUNGTOUCHSTONE	RCAC15ABT1784	GEN-1	AFTER COOLER	1,083	50% E.G.	50	124	127	4.2	AIR	311	328.0	134.6	2.3	4" FLANGED AIR CIRCUIT, 2-1/2" FLANGED 50% E.G. CIRCUIT.

SUPPLEMENTAL EXPANSION, DEAERATION & DRAWDOWN TANK SCHEDULE

TANK VOLUME							
SYMBOL MANUFACTURER	LOCATION	MEDIUM	MATERIAL	ECS/ECR TANK	ACCS/ACCR TANK	JW TANK	REMARKS
SEDD-1 YOUNGTOUCHSTONE	RAD-1	50% E.G.	STEEL	7.1 GAL	5.5 GAL		75/25 SPLIT TANK. ECS/ECR TO GO TO LARGER PORTION OF TANK, ACCS/ACCR TO GO TO SMALLER PORTION OF TANK, COORDINATE SIZE AND DIMENSIONS OF TANK W/ GENERATOR & RADIATOR SUPPLIER.
SEDD-2 YOUNGTOUCHSTONE	GEN-1	50% E.G.	STEEL			3.7 GAL	TANK TO BE MOUNTED ON OR NEAR GENERATOR. TO PROVIDE EXPANSION CAPABILITY FOR ENGINE JW LOOP, COORDINATE SIZE AND DIMENSIONS OF TANK W/ GENERATOR & RADIATOR SUPPLIER.

HEAT EXCHANGER SCHEDULE

· · / `															
			HOT SIDE	-				COLD SIDE							
						FLOW	WPD	E.G.T.	L.G.T.		FLOW	WPD	E.G.T.	L.G.T.	
SYMBOL	MANUFACTURER	MODEL	TYPE	FUNCTION	MEDIUM	(GPM)	(FT HD)	DEG F	DEG F	MEDIUM	(GPM)	(FT HD)	DEG F	DEG F	REMARKS
HX-1	ALFA LAVAL	CB110-90H	BRAZED PLATE	GENERATOR COOLING	50% E.G	. 45	2.0	210.0	199.7	50% E.G.	45	2.3	195	205	2" NPT CONNECTIONS.

PUMP SCHEDULE

ı Olvii O									
				PUMPED			MOTOR	DATA	
SYMBOL	MFGR	MODEL	FUNCTION	MEDIUM	GPM	HEAD F	T WATTS	POWER	REMARKS
CP-RAD-1	GRUNDFOS	UPS 40-160 F	GENERATOR ENGINE COOLANT	50% E.G.	45	37	770	460/60/3	2 SPEED PUMP SET TO SPEED 2.
CP-RAD-2	GRUNDFOS	UPS 50-160 F	GENERATOR CHARGE AIR COOLANT	50% P.G.	50	42	1,300	460/60/3	2 SPEED PUMP SET TO SPEED 2.

LOUVER SCHEDULE

SYMBOL	MANUFACTURER	MODEL	FUNCTION	MATERIAL	FINISH	CFM	FACE SIZE (H X W) (IN.)	NC REMARKS
L-1	RUSKIN	ELF6375DX	RAD-1 O/A	ALUMINUM	PAINT TO MATCH EXISTING LOUVERS	4,002	72" X 60"	<25 PROVIDE WITH 3/4" BIRDSCREEN AND HARDWARE FOR MASONRY WALL INSTALLATION
L-2	RUSKIN	ELF6375DX	RAD-1 E/A	ALUMINUM	PAINT TO MATCH EXISTING LOUVERS	4,002	72" X 60"	<25 PROVIDE WITH 3/4" BIRDSCREEN AND HARDWARE FOR MASONRY WALL INSTALLATION

GLYCOL TANK SCHEDULE

						TANK	CAPACITY	PUMP		ELECTRICA	L	
SYMBOL	MANUFACTURER	MODEL	FUNCTION	MEDIUM	MATERIAL	GAL	DIMENSIONS	GPM	PSI	HP	POWER	REMARKS
EGT-1	WESSELS	GMPD-23050	GENERATOR COOLANT	50% E.G.	POLYETHYLENE	50	34" DIA X 56" H	1.8 @	70 PSI	1/3 (2)	120/60/1	PACKAGED DUPLEX GLYCOL CHARGING SYSTEM, CORD AND PLUG CONNECTION. SERVES BOTH ENGINE COOLANT, ECS/ECR, AND CHARGE AIR COOLANT, ACCS/ACCR.

SUBMITTAL PRICING

> RSA ENGINEERING, INC. 670 W. FIREWEED, SUITE 200 ANCHORAGE, AK 99503 PHONE: 907-276-0521 FAX: 907-276-1751 CORPORATE NO: AECC542



Alaska Court System

Boney Courthouse Generator Replacement

303 K Street Anchorage, Alaska 99501

CONSTRUCTION DOCUMENTS

JOB NO.	M3152
DATE:	03/06/24
PROJ MGR.:	MRB
DRAWN BY:	MRB
REVIEWED BY:	BPP
REVISIONS:	

MECHANICAL LEGENDS, **ABBREVIATIONS** AND SCHEDULES

SHEET NO.

M001



Alaska Court System

Boney Courthouse Generator Replacement

303 K Street Anchorage, Alaska 99501

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REVIEWED BY:	ВРР


GENERATOR ROOM HVAC DEMOLITION

AREA OF

BASEMENT - KEY PLAN

SHEET NO.

M101

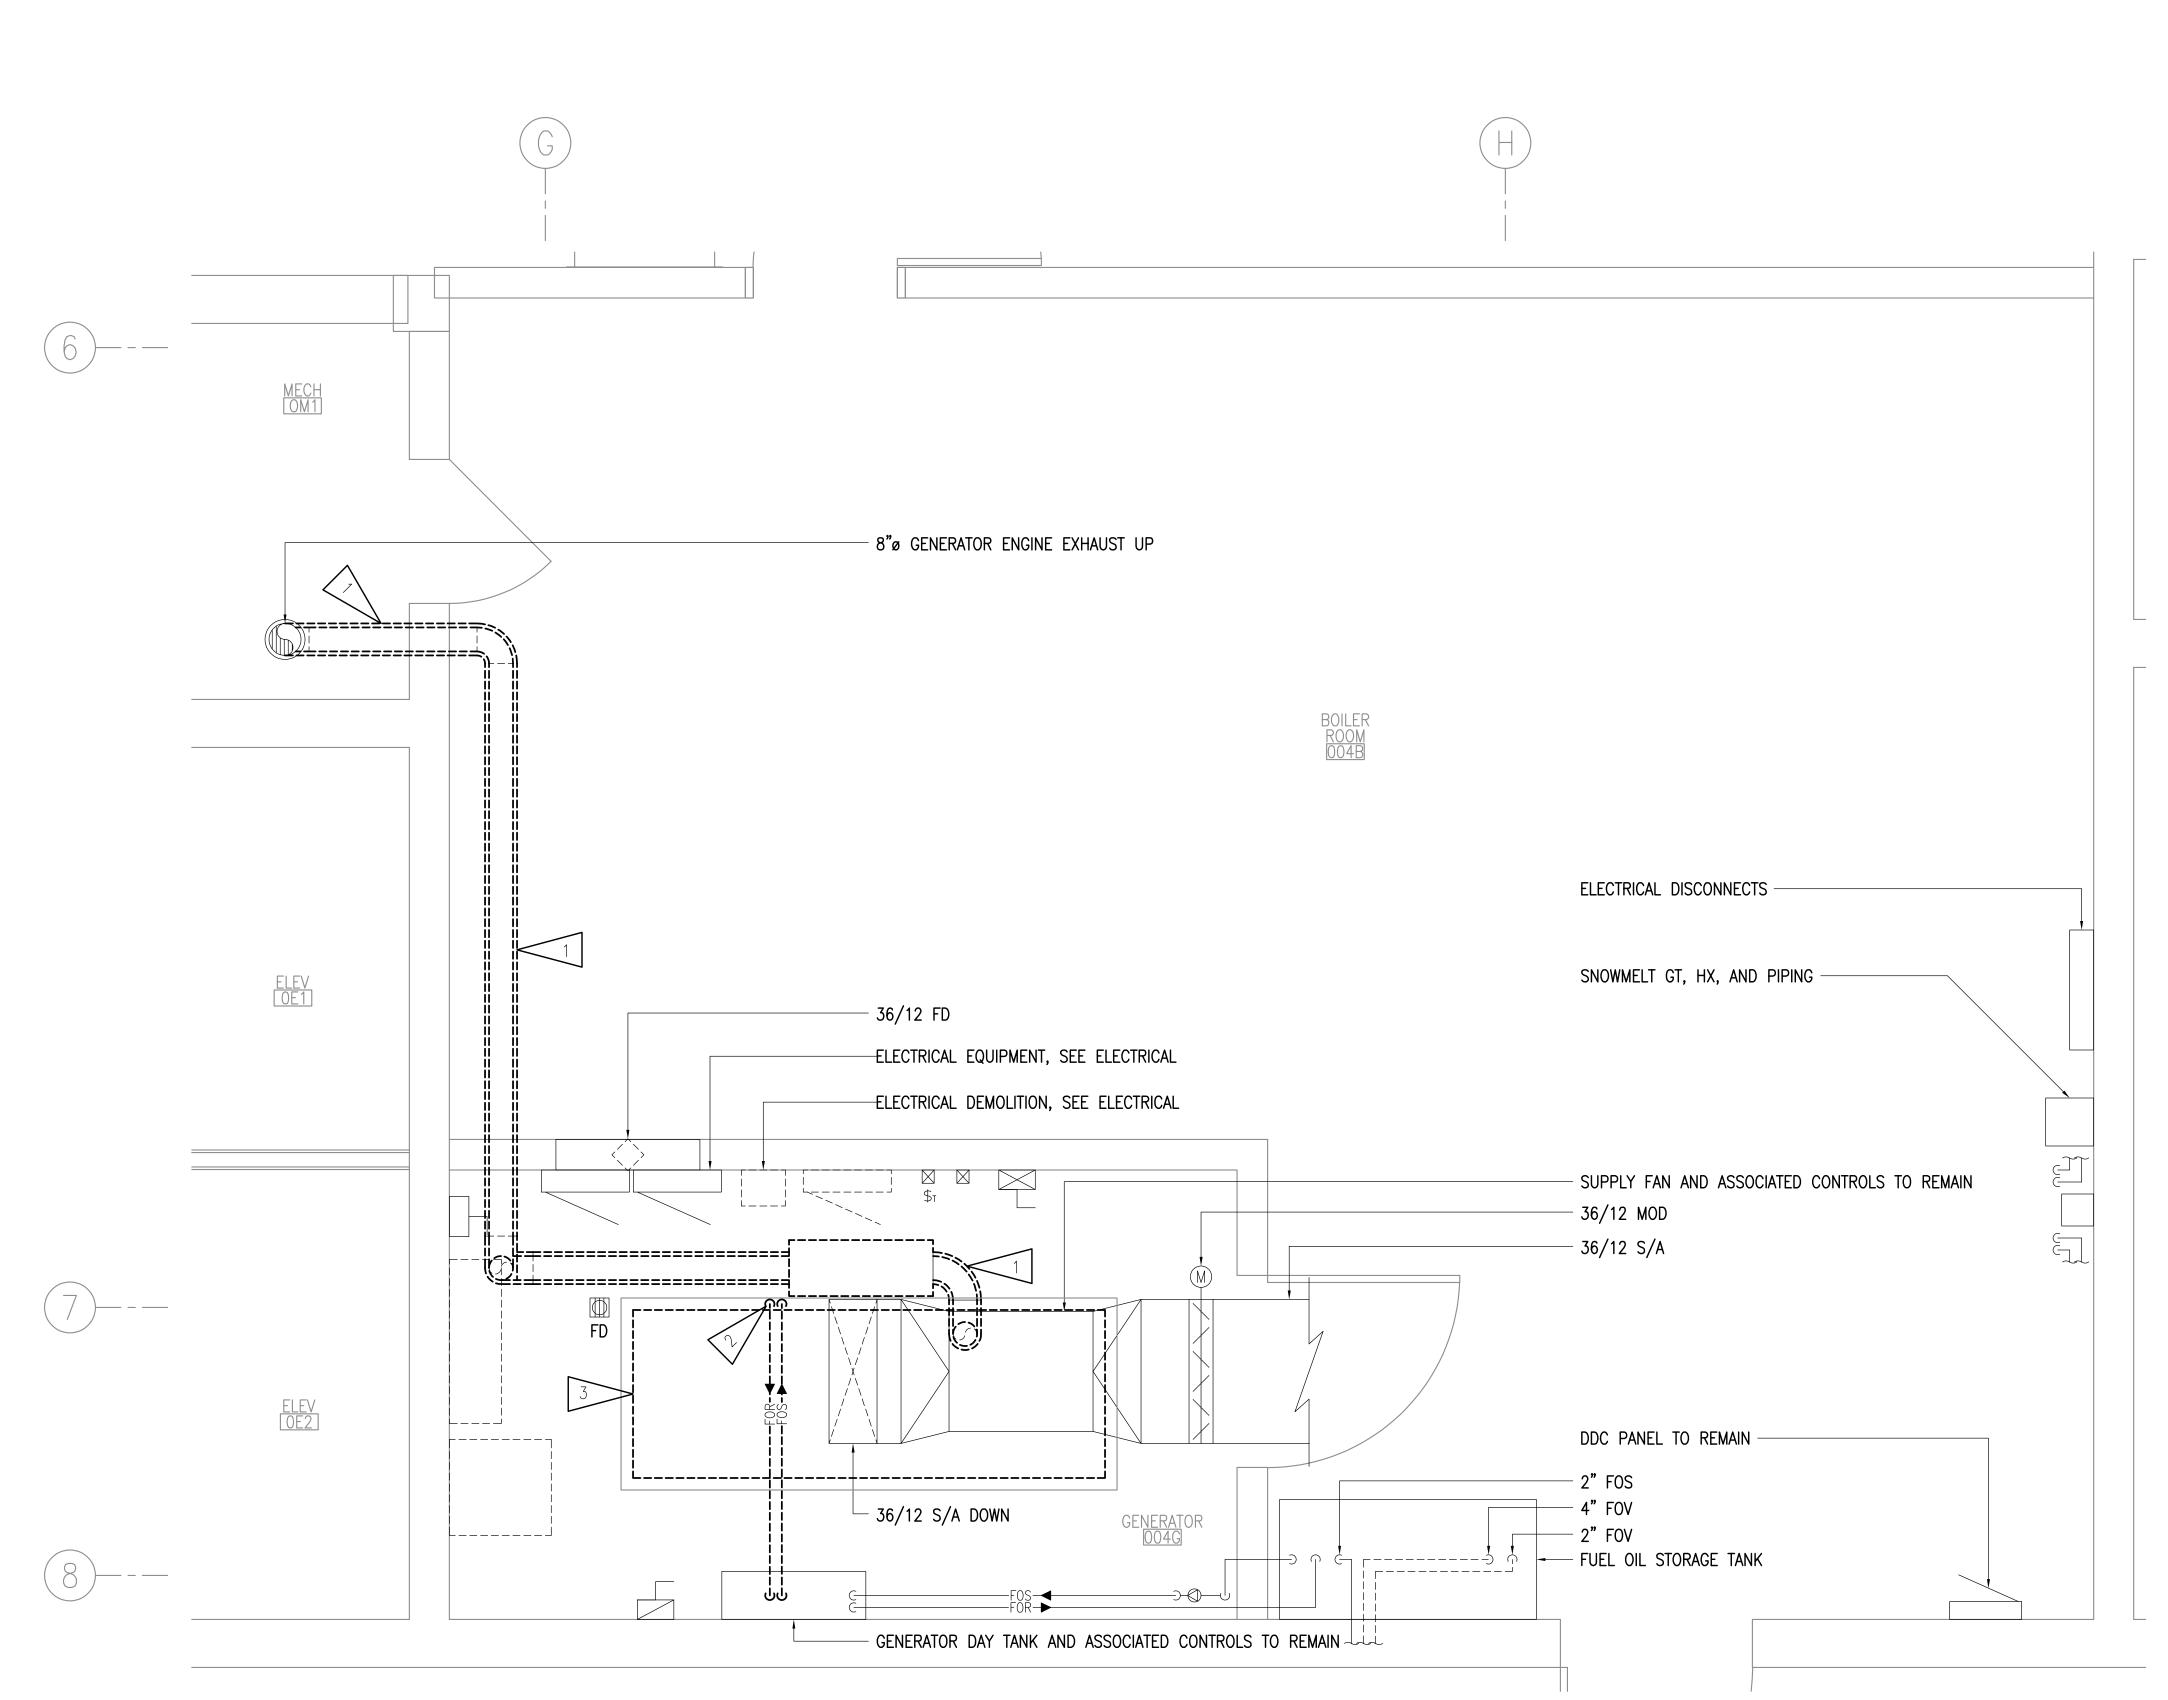

GENERATOR ROOM - HVAC DEMOLITION PLAN

1/2" = 1'-0"

GENERAL NOTES

- A. THE INFORMATION SHOWN ON THIS DRAWING IS TAKEN FROM AS BUILT DRAWINGS AND A NON-DESTRUCTIVE WALK THROUGH OF THE FACILITY. THERE IS NO WARRANTY OR GUARANTEE AS TO THE ACCURACY OF THE INFORMATION SHOWN HERE-IN. THE CONTRACTOR SHALL FIELD VERIFY ALL ITEMS SCHEDULED FOR DEMOLITION PRIOR TO START OF WORK.
- B. THE OWNER SHALL HAVE FIRST RIGHT OF REFUSAL ON ALL SALVAGEABLE MATERIALS THE CONTRACTOR SHALL DELIVER SALVAGED MATERIALS TO A LOCATION AS DIRECTED BY THE OWNER IN ACCORDANCE WITH THE CONTRACT DOCUMENTS.
- C. DASHED OR DOTTED BOLD LINES INDICATE ITEMS TO BE REMOVED. UN-BOLDED LINES INDICATE EXISTING ITEMS TO REMAIN.

SHEET NOTES

- DEMOLISH SILENCER AND ASSOCIATED INSULATED 6"Ø GENERATOR ENGINE ENGINE EXHAUST BACK TO TRANSITION TO 8"Ø GENERATOR ENGINE EHXUAST IN MECHANICAL SHAFT.
- DEMOLISH 1/2" FOR/FOS FROM GENERATOR DAY TANK TO GENERATOR IN ITS ENTIRETY.
 - DEMOLISH GENERATOR IN ITS ENTIRETY. SEE ELECTRICAL FOR ADDITIONAL INFORMATION. DEMOLISH EXISTING GENERATOR DDC CONTROLS TO EXTENT NECESSARY TO ACCOMMODATE NEW WORK.



SHEET NOTES

GENERAL NOTES

INFORMATION SHOWN HERE-IN.

 \rightarrow PROVIDE SEISMIC RESTRAINT FOR <u>EGT-1</u>.

2 PROVIDE FLEXIBLE PIPING CONNECTION FOR FOS/FOS TO GENERATOR.

A. THE INFORMATION SHOWN ON THIS DRAWING IS TAKEN FROM AS BUILT DRAWINGS AND A NON-DESTRUCTIVE WALK THROUGH OF THE FACILITY. THERE IS NO WARRANTY OR GUARANTEE AS TO THE ACCURACY OF THE

B. MECHANICAL CONTRACTOR TO PROVIDE FIELD INSTALLATION FOR ALL GENERATOR COMPONENTS SHIPPED LOOSE FOR FIELD INSTALLATION.



Alaska Court System

Boney Courthouse Generator Replacement


303 K Street Anchorage, Alaska 99501


CONSTRUCTION DOCUMENTS

).	M3152
	03/06/24
MGR.:	MRB
I BY:	MRB
VED BY:	BPP
ONS:	

GENERATOR ROOM HVAC REMODEL

SHEET NO.
M201

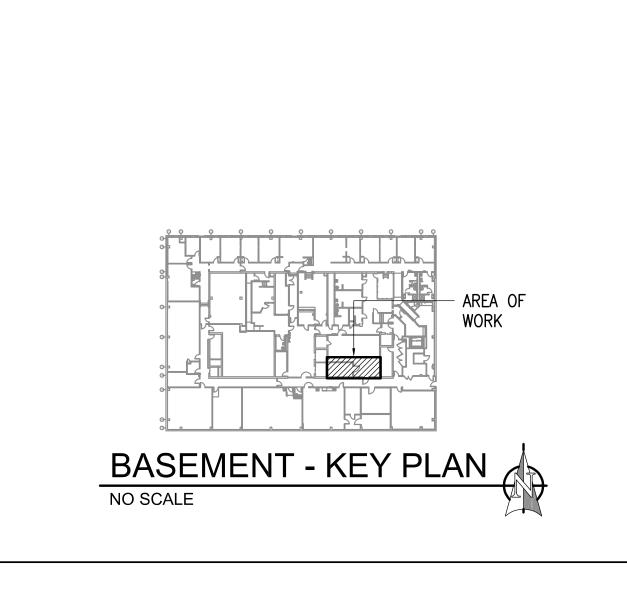

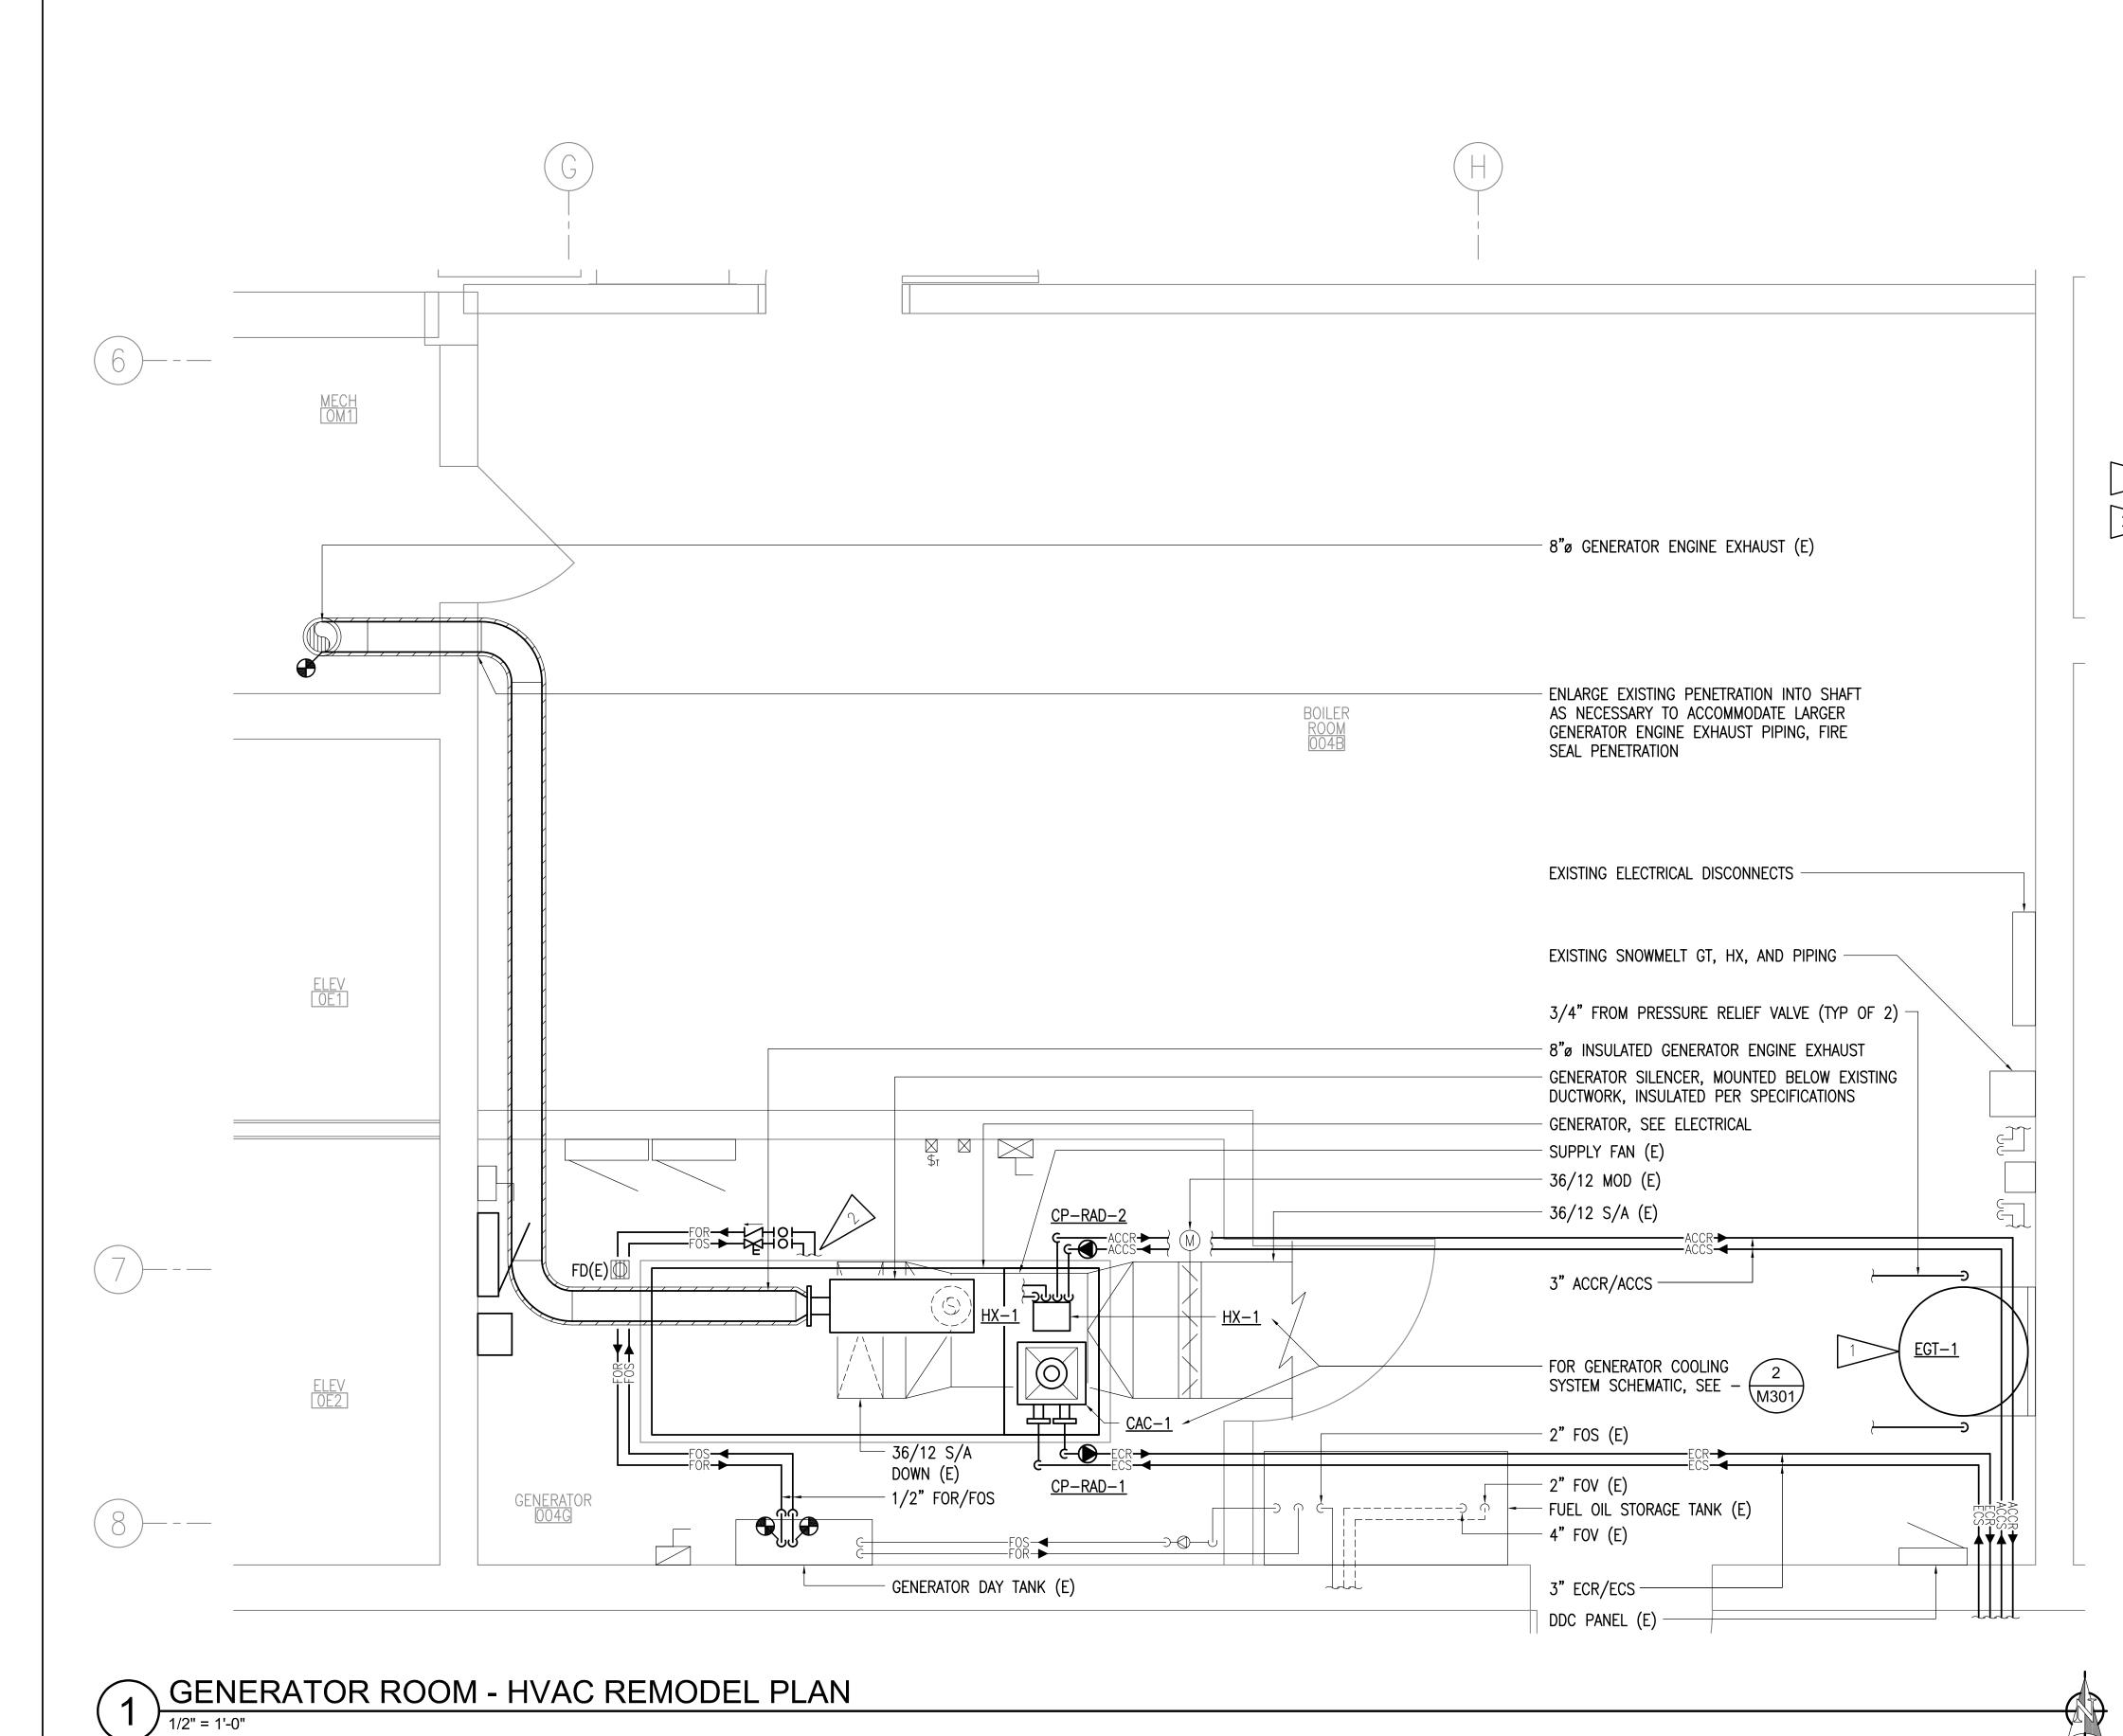

GENERATOR COMPONENTS SHIPPED LOOSE FOR FIELD INSTALLATION.



Alaska Court System

Boney Courthouse Generator Replacement

303 K Street Anchorage, Alaska


CONSTRUCTION DOCUMENTS

JOB NO.	M3152
DATE:	03/06/24
PROJ. MGR.:	MRB
DRAWN BY:	MRB
REVIEWED BY:	BPP
REVISIONS:	


BASEMENT CORRIDOR 1ST FLOOR HVAC REMODEL

M202

SHEET NO.

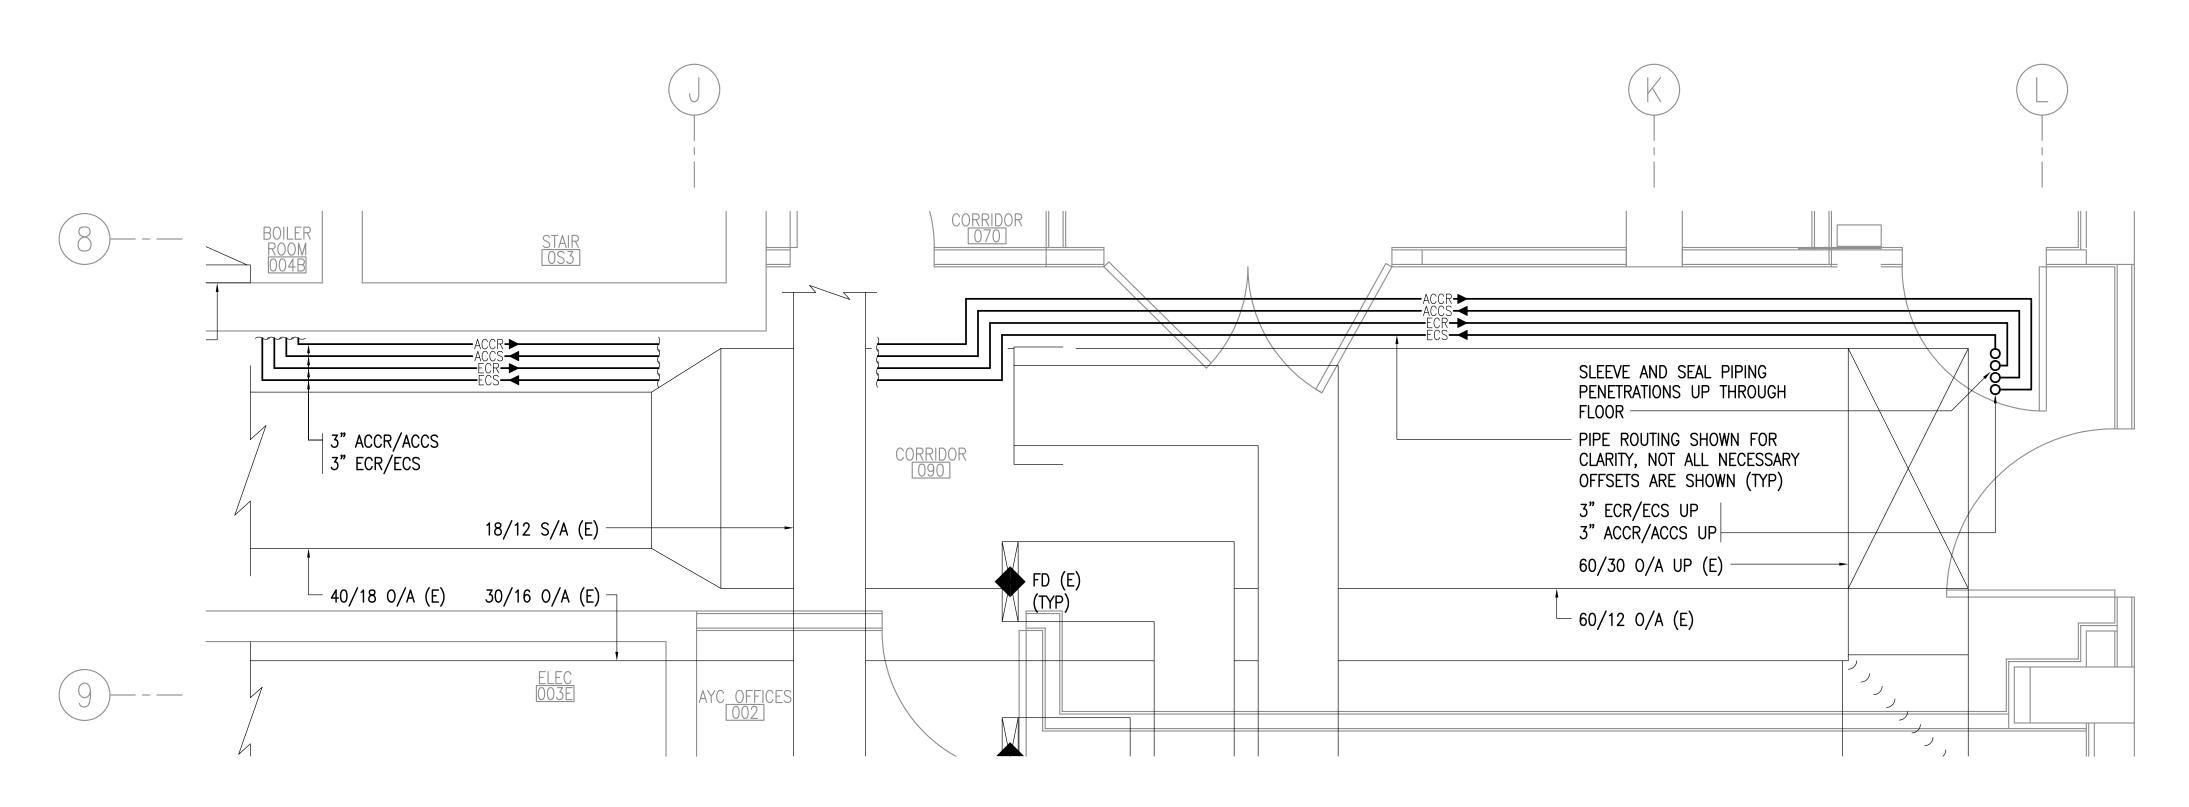

BASEMENT CORRIDOR - HVAC REMODEL PLAN

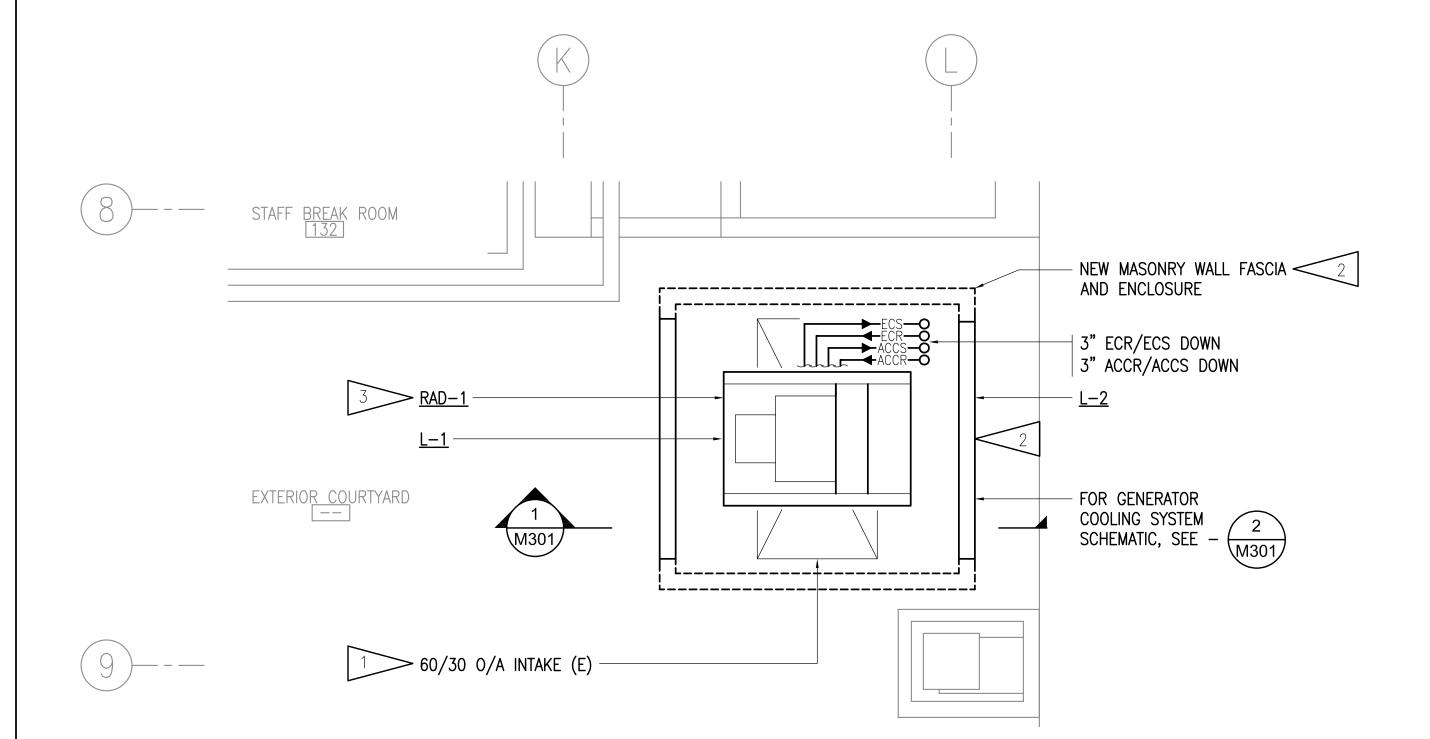


1ST FLOOR - HVAC REMODEL PLAN

1ST FLOOR - KEY PLAN

GENERAL NOTES

A. THE INFORMATION SHOWN ON THIS DRAWING IS TAKEN FROM AS BUILT DRAWINGS AND A NON-DESTRUCTIVE WALK THROUGH OF THE FACILITY. THERE IS NO WARRANTY OR GUARANTEE AS TO THE ACCURACY OF THE INFORMATION SHOWN HERE-IN.

MECHANICAL CONTRACTOR TO PROVIDE FIELD INSTALLATION FOR ALL

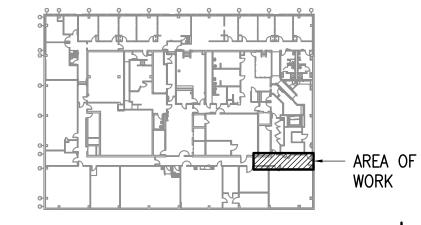

BASEMENT - KEY PLAN NO SCALE

SHEET NOTES

REMOVE AND SALVAGE BRICK FASCIA ASSOCIATED W/ O/A INTAKE. DEMOLISH EXISTING LOUVERS, TYP OF 3.

REINSTALL SALVAGED BRICK FASCIA. EXTEND FASCIA WITH NEW BRICK AND PROVIDE NEW LOUVERS, $\underline{\mathsf{L}}-1$ AND $\underline{\mathsf{L}}-2$ FOR $\underline{\mathsf{RAD}}-1$ AIRFLOW. MOUNT LOUVERS MINIMUM 6" AFG. TOP OF FASCIA TO BE MINIMUM 6" ABOVE TOP OF LOUVER. CONTRACTOR TO COORDINATE W/ OWNER FOR PROCUREMENT OF MASONRY WALL FASCIA FOR RADIATOR ENCLOSURE. NEW MASONRY FASCIA TO MATCH EXISTING MASONRY FASCIA FOR OUTSIDE AIR INTAKE. SEAL ALL JOINTS WEATHER TIGHT TO EXISTING MASONRY FASCIA AND GRADE.

INSTALL <u>RAD-1</u> ON STEEL SUPPORTS SECURED TO GRADE. CONTRACTOR TO PROVIDE A DEFERRED SUBMITTAL WITH STRUCTURAL & SEISMIC CALCULATIONS STAMPED BY A REGISTERED STRUCTURAL ENGINEER.

AREA OF

MILAUD R. BAUMGARTNER B.
ME-135263

MEFESSINAL

Alaska Court System

Boney Courthouse Generator Replacement

303 K Street Anchorage, Alaska 99501


CONSTRUCTION DOCUMENTS

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DATE:	03/06/24
PROJ. MGR.:	MRB
DRAWN BY:	MRB
REVIEWED BY:	ВРР
REVISIONS:	

MECHANICAL SCHEDULES AND SCHEMATICS


SHEET NO.

M301

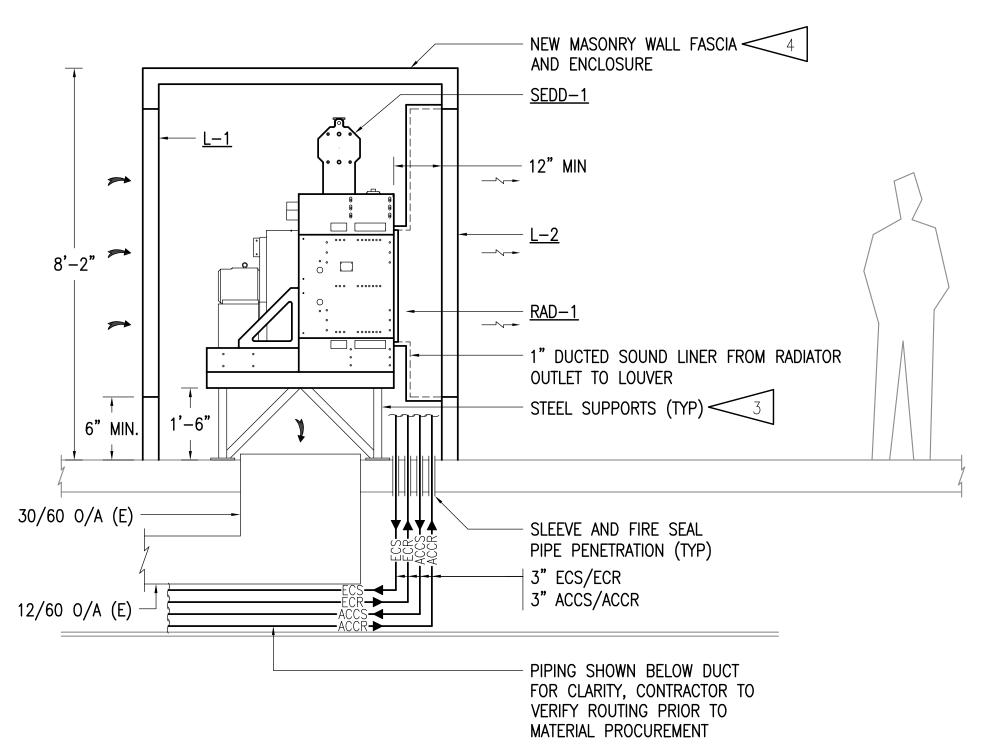



NO SCALE

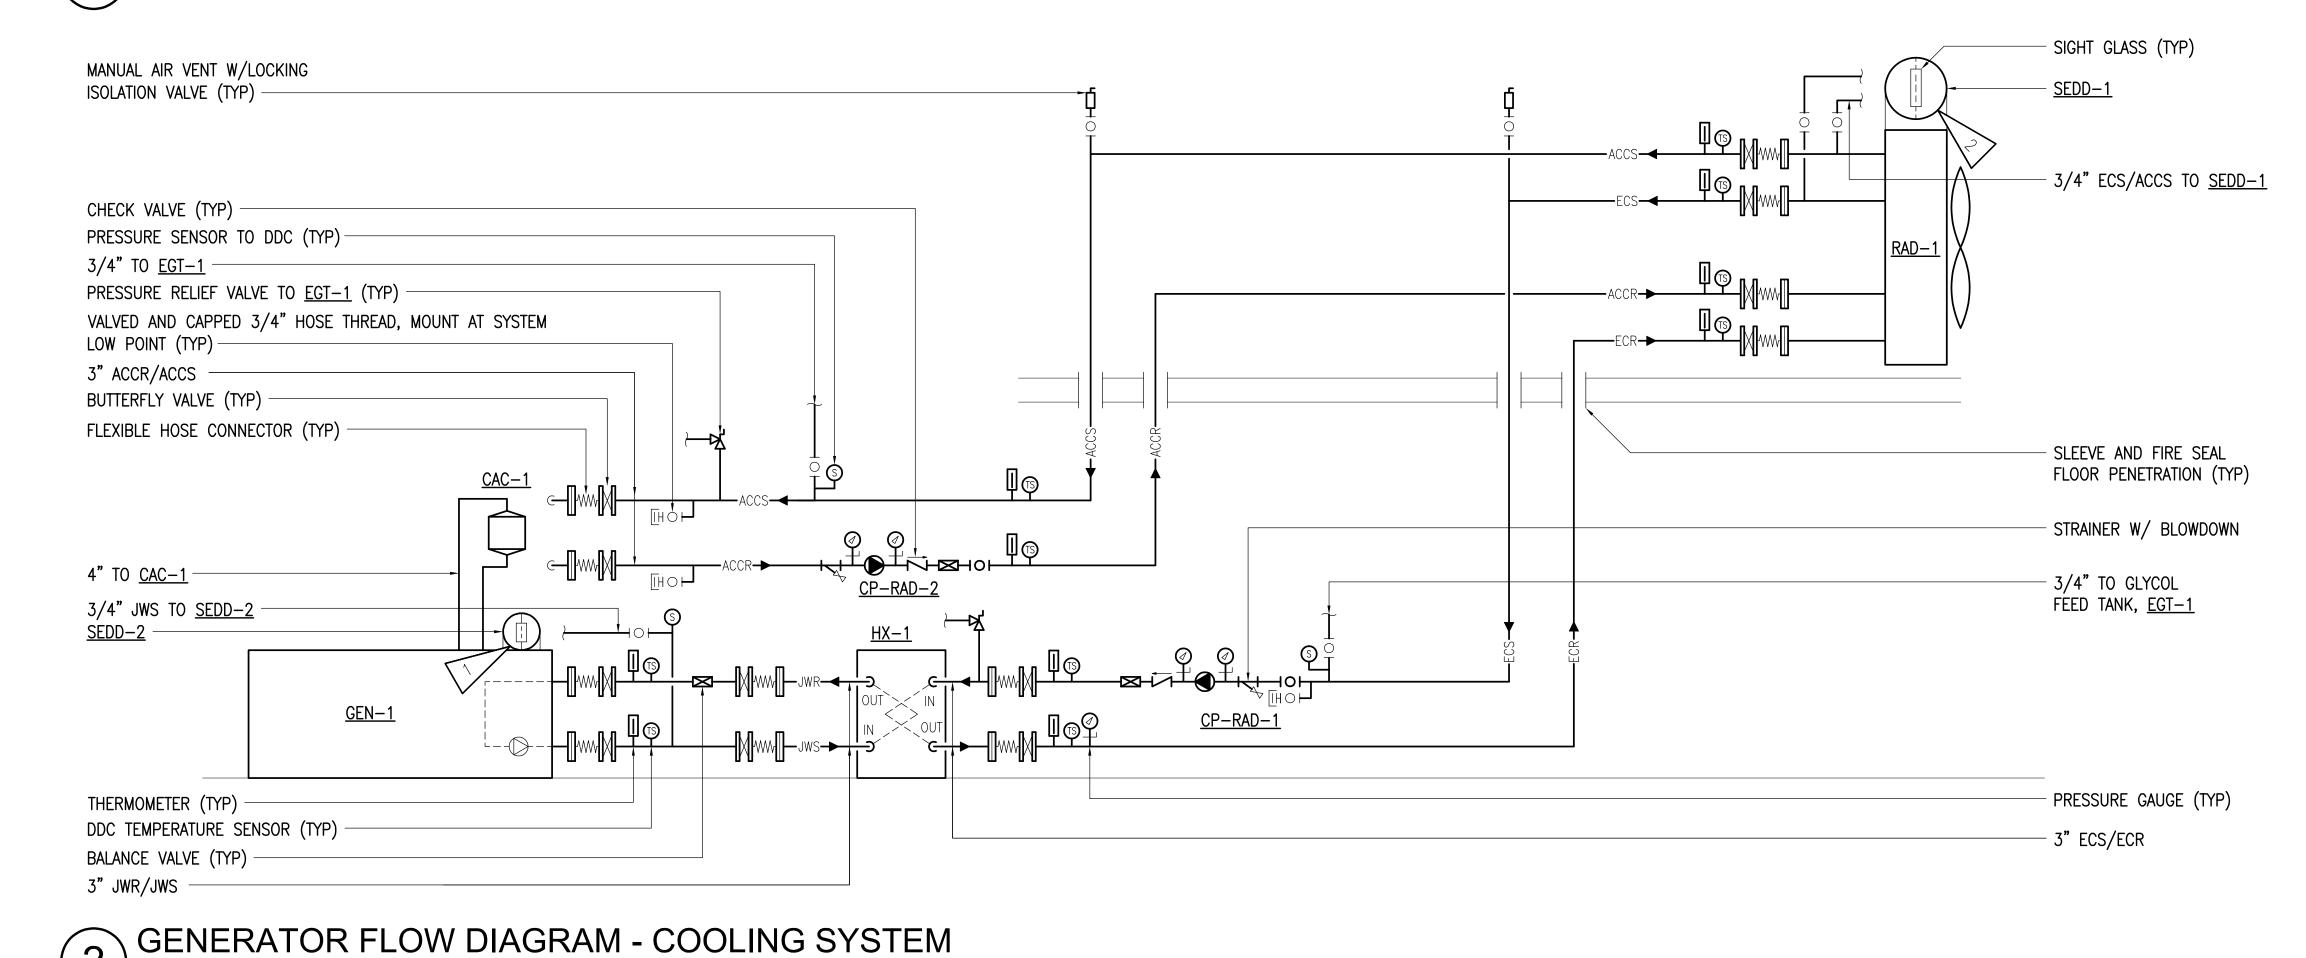

GENERAL NOTES

- A. THE INFORMATION SHOWN ON THIS DRAWING IS TAKEN FROM AS BUILT DRAWINGS AND A NON-DESTRUCTIVE WALK THROUGH OF THE FACILITY. THERE IS NO WARRANTY OR GUARANTEE AS TO THE ACCURACY OF THE INFORMATION SHOWN HERE-IN.
- B. MECHANICAL CONTRACTOR TO PROVIDE FIELD INSTALLATION FOR ALL GENERATOR COMPONENTS SHIPPED LOOSE FOR FIELD INSTALLATION.


SCHEMATIC NOTES:

- PROVIDE LOW LIQUID LEVEL SENSOR ON 1/2 NPT FITTING AT TANK, JW CIRCUIT. OUTPUT TO ENGINE CONTROLLER LOW COOLANT CONTACT.
- PROVIDE TWO(2) LOW LIQUID LEVEL SENSORS ON 1/2 NPT FITING AT TANK, AFTER COOLER AND ENGINE COOLANT CIRCUITS. OUTPUT TO ENGINE CONTROLLER LOW COOLANT CONTACT.
- CONTRACTOR TO PROVIDE A DEFERRED SUBMITTAL WITH STRUCTURAL & SEISMIC CALCULATIONS STAMPED BY A REGISTERED STRUCTURAL ENGINEER.
- CONTRACTOR TO COORDINATE W/OWNER FOR PROCUREMENT OF MASONRY WALL FASCIA FOR RADIATOR ENCLOSURE. NEW MASONRY FASCIA TO MATCH EXISTING MASONRY FASCIA FOR OUTSIDE AIR INTAKE. SEAL ALL JOINTS WEATHER TIGHT TO EXISTING MASONRY FASCIA AND GRADE.


LEGEND								
	CONDUIT, CONCEALED	С	CONDUIT					
#10	NUMBER AND SIZE OF WIRES (NO MARKS = 3 #12)	CO	CONDUIT ONLY					
A-2	HOMERUN TO PANEL (PANEL AND CIRCUIT No.)	E	DENOTES EXISTING ITEM					
_ , _	NEW PANEL, EXISTING PANEL	GFCI	GROUND FAULT CIRCUIT INTERRUPTER					
0	JUNCTION BOX	GRSC	GALVANIZED RIGID STEEL CONDUIT					
9	MOTOR (SIZED AS NOTED)	MCB	MAIN CIRCUIT BREAKER					
\$₁	FRACTIONAL HORSEPOWER MOTOR STARTER	MLO	MAIN LUGS ONLY					
占	DISCONNECT SWITCH	N	DENOTES NEW ITEM					
7	DISCONNECT SWITCH (FUSED)	NEC	NATIONAL ELECTRICAL CODE					
×	COMBINATION DISCONNECT/MAGNETIC MOTOR STARTER	R	DENOTES EXISTING ITEM THAT HAS BEEN RELOCATED					
ф	DUPLEX RECEPTACLE TO BE REMOVED (DASHED OR DOTTED LINES INDICATE ITEMS TO BE REMOVED TYPICAL)	TYP	TYPICAL					
	NOTE TAG (No. INDICATES NOTE)	UON	UNLESS OTHERWISE NOTED					
AFF	ABOVE FINISHED FLOOR	WP	WEATHERPROOF					
AFG	ABOVE FINISHED GRADE							

ELECTRICAL LOAD CALCULATION	I	
SERVICE SWITCHBOARD: 4,000A, 277/480V, 3Ø, 4-WIRE		
EXISTING SERVICE DEMAND LOAD		
EXISTING PEAK DEMAND LOAD (W) - PAST 12 MO	368,000	W
PER NEC 220.87(2) (125%)	460,000	
0.85 POWER FACTOR	541,176	
PANEL 'X': 225A, 277/480VV, 3Ø, 4-WIRE		
EXISTING DEMAND LOAD (NEC 220.87)		
30-DAY DEMAND METERING (VA):	63,282	VA
ADDED EQUIPMENT LOADS		
RAD-1	2,494	
CP-RAD-1	770	VA
CP-RAD-2	1,300	VA
EGT-1 (2 @ 863 VA)	1,728	VA
TOTAL ADDED LOAD	6,292	VA
NEW CALCULATED DEMAND LOAD SERVICE/MDD (VA).	E47 460	٧,٨
NEW CALCULATED DEMAND LOAD - SERVICE/MDP (VA):		
NEW CALCULATED DEMAND LOAD - SERVICE/MDP (AMPS):	659	A
NEW CALCULATED DEMAND LOAD - PANEL 'X' (VA):	69,574	VA
NEW CALCOLATED DEMIAND ECAD - I ANEL A (VA).		

CAPACITY FOR THE ADDED LOAD.

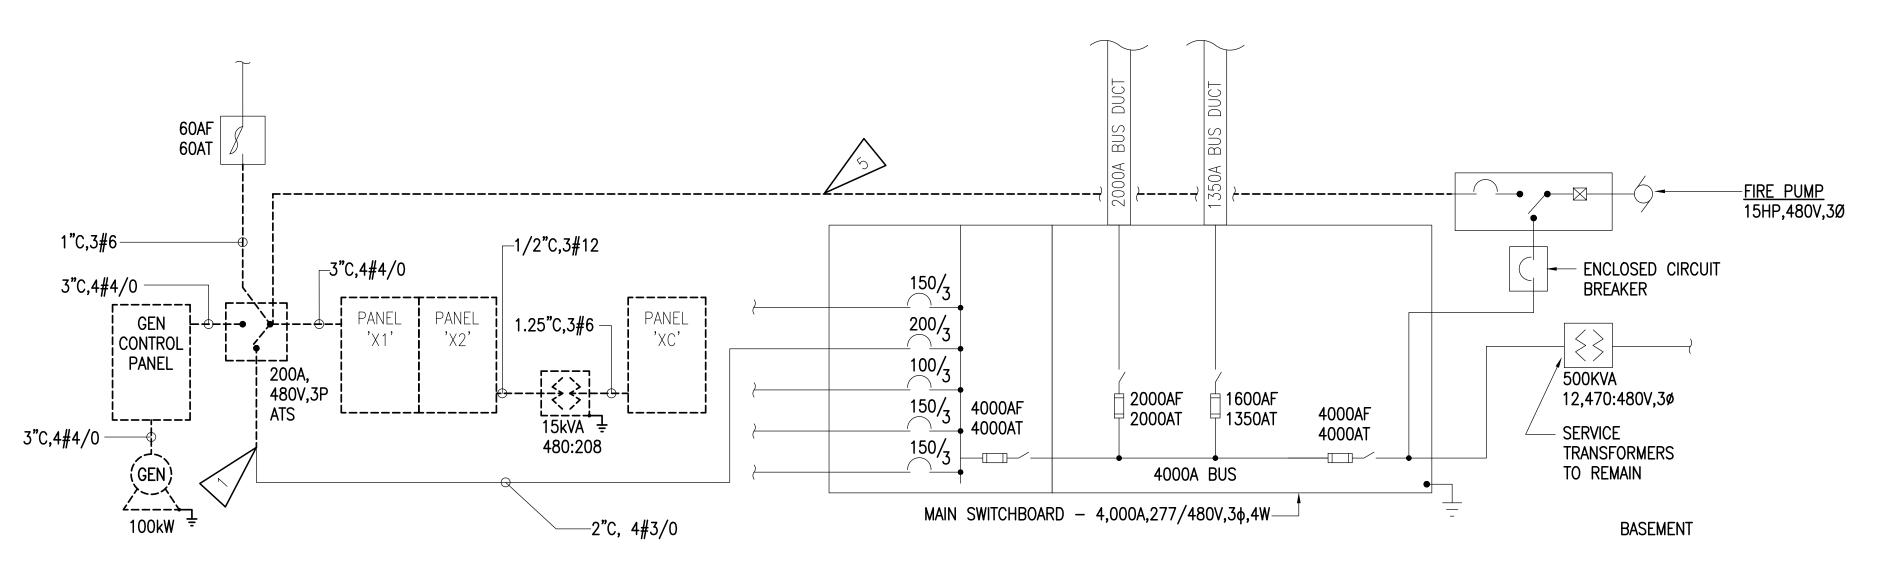

DEMOLITION PARTIAL ONE-LINE DIAGRAM NO SCALE

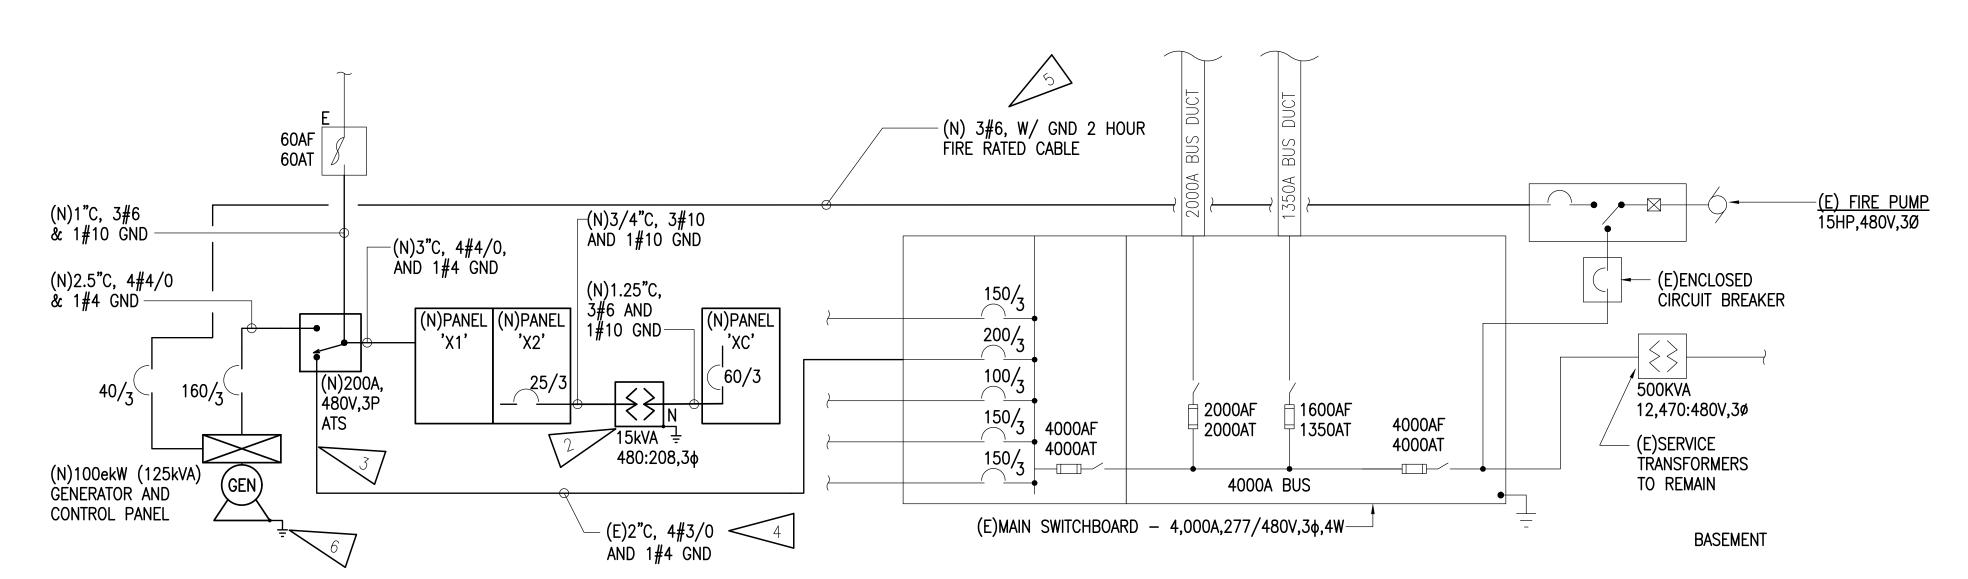

REMODEL PARTIAL ONE-LINE DIAGRAM NO SCALE

- AS-BUILT DRAWINGS AND A NON-DESTRUCTIVE WALK THROUGH OF THE FACILITY. THERE IS NO WARRANTY OR GUARANTEE AS TO THE ACCURACY OF THE INFORMATION ITEMS SCHEDULED FOR DEMOLITION PRIOR TO START OF WORK.
- SOLID LINES INDICATE EXISTING ITEMS TO REMAIN.
- INCLUDE A REMOTE RADIATOR.

SHEET NOTES:

- 1. DEMOLISH EXISTING FEEDER AS NEEDED TO INSTALL NEW ATS. EXTEND AND RECONNECT TO NEW TRANSFER SWITCH. PROVIDE JUNCTION BOXES, CONDUIT, AND WIRE AS REQUIRED.
- 2. PROVIDE NEW TRANSFORMER AND RECONNECT TO EXISTING GROUNDING ELECTRODE CONDUCTOR FOR SEPARATELY DERIVED SYSTEM.
- 3. EXTEND AND RECONNECT EXISTING FEEDERS AS REQUIRED.
- 4. PROVIDE #4 EQUIPMENT GROUNDING CONDUCTOR IF IT DOES NOT EXIST IN THE FEEDER, OTHERWISE EXTEND.
- 5. REMOVE EXISTING FEEDER TO FIRE PUMP AND REPLACE WITH 2 HOUR RATED FEEDER PER NEC 695.6(A)(2)(4). FIRE PUMP FEEDER IS APPROXIMATELY 140' IN LENGTH.
- 6. PROVIDE #2 BARE COPPER GROUND ELECTRODE CONDUCTOR AND CONNECT TO EXISTING GROUNDING ELECTRODE.

GENERAL NOTES:

- A. THE INFORMATION SHOWN ON THIS DRAWING IS TAKEN FROM SHOWN HERE-IN. THE CONTRACTOR SHALL FIELD VERIFY ALL
- THE OWNER SHALL HAVE FIRST RIGHT OF REFUSAL ON ALL SALVAGEABLE MATERIALS. THE CONTRACTOR SHALL DELIVER SALVAGED MATERIALS TO A WAREHOUSE AS DIRECTED BY THE OWNER. THE CONTRACTOR SHALL DISPOSE OF, OFF SITE, ALL UNWANTED MATERIALS.
- C. DASHED OR DOTTED LINES INDICATE ITEMS TO BE REMOVED.
- D. WORK INCLUDES THE DEMOLITION OF THE EXISTING GENERATOR AND ASSOCIATED EQUIPMENT FOR REPLACEMENT WITH A NEW GENERATOR AND ASSOCIATED EQUIPMENT TO



SUBMITTAL

RSA ENGINEERING, INC.

670 W. FIREWEED, SUITE 200 ANCHORAGE, AK 99503

CORPORATE NO: AECC542

PHONE: 907-276-0521

FAX: 907-276-1751

PRICING

Alaska Court System

Boney Courthouse Generator Replacement

303 K Street Anchorage, Alaska


CONSTRUCTION **DOCUMENTS**


JOB NO.	M3152
DATE:	03/06/24
PROJ. MGR.:	TEH
DRAWN BY:	BC,NVF
REVIEWED BY:	TEH, JAM
REVISIONS:	

LEGEND, ONE-LINE DIAGRAMS, AND LOAD **CALCULATION**

SHEET NO.

E001

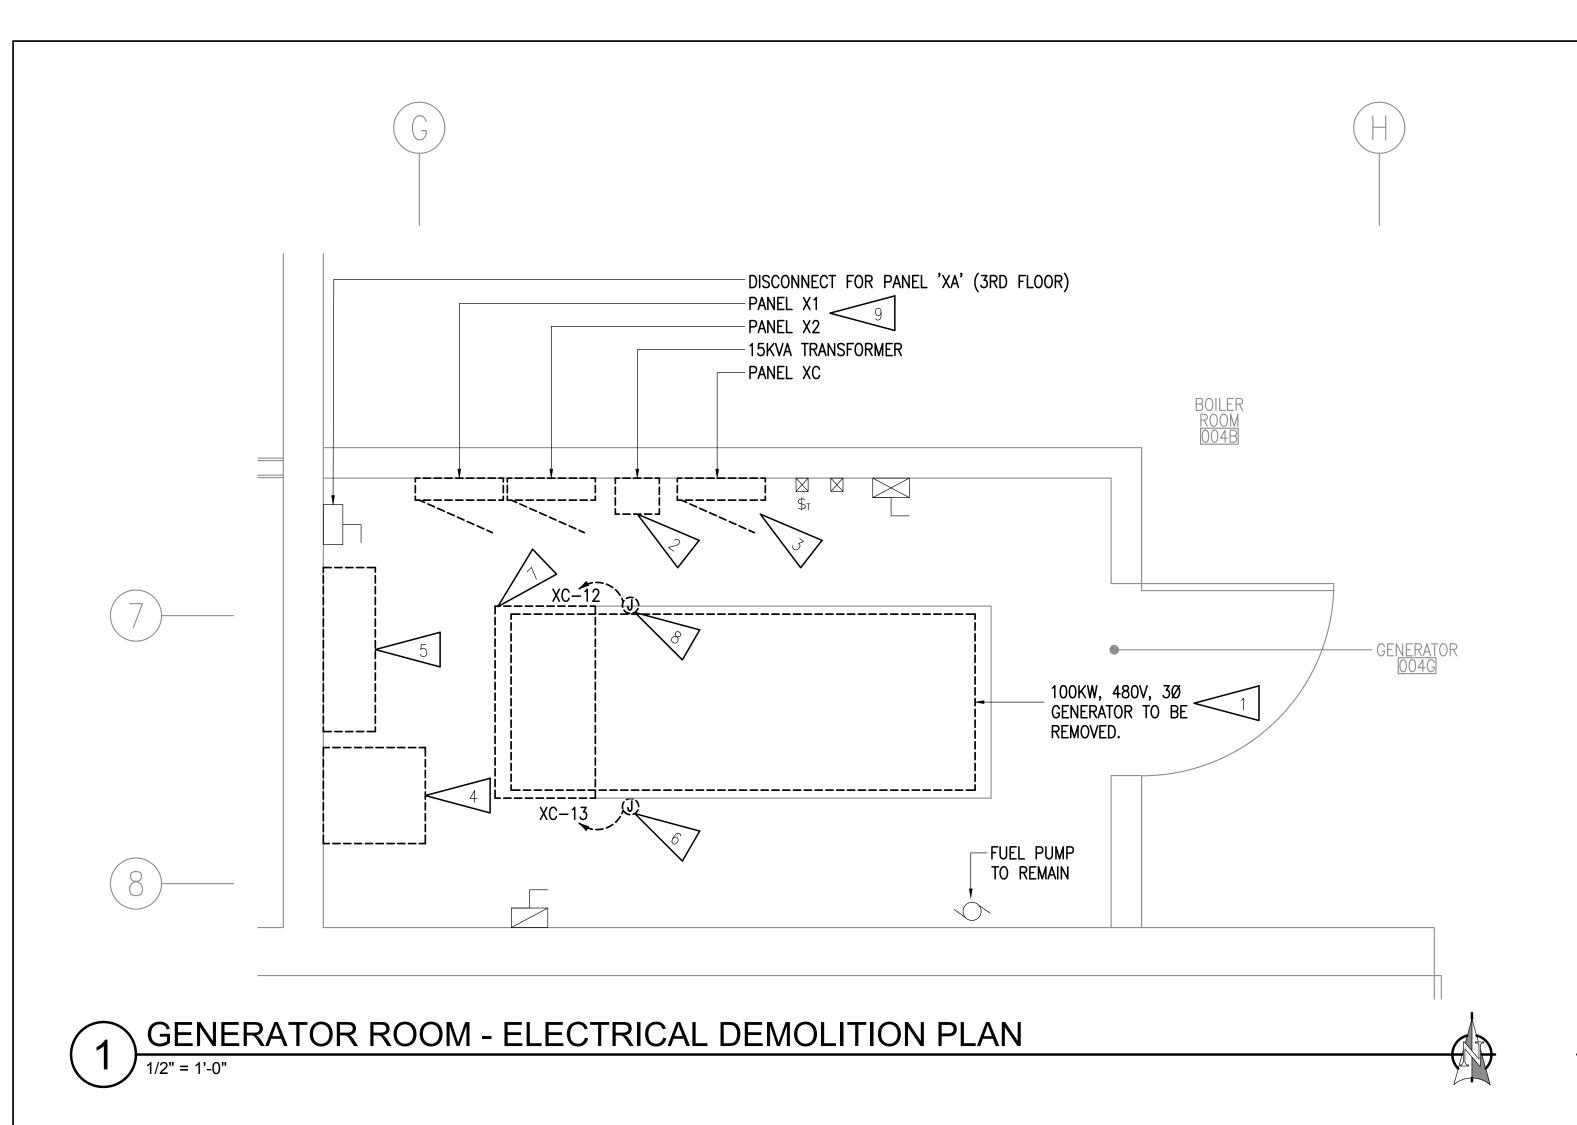

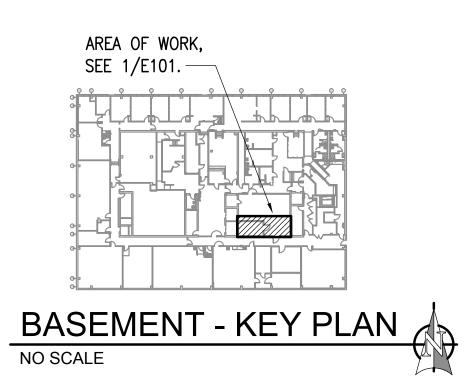

GENERAL NOTES:

- A. THE INFORMATION SHOWN ON THIS DRAWING IS TAKEN FROM AS-BUILT DRAWINGS AND A NON-DESTRUCTIVE WALK THROUGH OF THE FACILITY. THERE IS NO WARRANTY OR GUARANTEE AS TO THE ACCURACY OF THE INFORMATION SHOWN HERE-IN. THE CONTRACTOR SHALL FIELD VERIFY ALL ITEMS SCHEDULED FOR DEMOLITION PRIOR TO START OF WORK.
- . THE OWNER SHALL HAVE FIRST RIGHT OF REFUSAL ON ALL SALVAGEABLE MATERIALS. THE CONTRACTOR SHALL DELIVER SALVAGED MATERIALS TO A WAREHOUSE AS DIRECTED BY THE OWNER. THE CONTRACTOR SHALL DISPOSE OF, OFF SITE, ALL UNWANTED MATERIALS.
- C. DASHED OR DOTTED LINES INDICATE ITEMS TO BE REMOVED. SOLID LINES INDICATE EXISTING ITEMS TO REMAIN.
- D. SALVAGE ALL GENERATOR MONITORING DEVICES AND CONNECTORS


SHEET NOTES:

- 1. REMOVE GENERATOR AND ASSOCIATED ELECTRICAL EQUIPMENT. SALVAGE WIRING FOR EXTENSION TO NEW GENERATOR. SEE ELECTRICAL REMODEL PLAN 1/E201.
- 2. DEMOLISH EXISTING TRANSFORMER.
- 3. DEMOLISH PANELBOARD. SALVAGE ALL BRANCH CIRCUIT WIRING FOR EXTENSION TO NEW PANELBOARD TO BE INSTALLED AT NEW LOCATION. SEE ELECTRICAL REMODEL PLAN 1/E201.
- 4. DEMOLISH GENERATOR CONTROL PANEL.
- 5. DEMOLISH TRANSFER SWITCH.
- 6. DEMOLISH CONNECTION TO BATTERIES AND CHARGING EQUIPMENT. SALVAGE CIRCUIT FOR RE-USE.
- 7. PORTION OF HOUSEKEEPING PAD IN FRONT OF PANELS TO BE REMOVED. COORDINATE WITH PROJECT MANAGER.
- 8. DEMOLISH ENGINE BLOCK HEATER. SALVAGE CIRCUIT FOR RE-USE.
- 9. DEMOLISH PANELBOARD. SALVAGE BRANCH CIRCUIT WIRING FOR CONNECTION TO NEW PANELBOARD TO BE INSTALLED AT THIS LOCATION. SEE ELECTRICAL REMODEL PLAN 1/E201.

O. SUBMITTAL O. PRICING

> RSA ENGINEERING, INC. 670 W. FIREWEED, SUITE 200 ANCHORAGE, AK 99503 PHONE: 907-276-70521 FAX: 907-276-7151

CORPORATE NO: AECC542

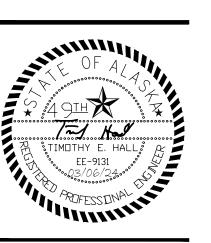

Alaska Court System

Boney Courthouse Generator Replacement

303 K Street Anchorage, Alaska 99501


CONSTRUCTION DOCUMENTS

M3152	JOB NO.
03/06/24	DATE:
TEH	PROJ. MGR.:
BC,NVF	DRAWN BY:
TEH, JAM	REVIEWED BY:
	REVISIONS:

ELECTRICAL DEMOLITION PLAN

SHEET NO.

E101

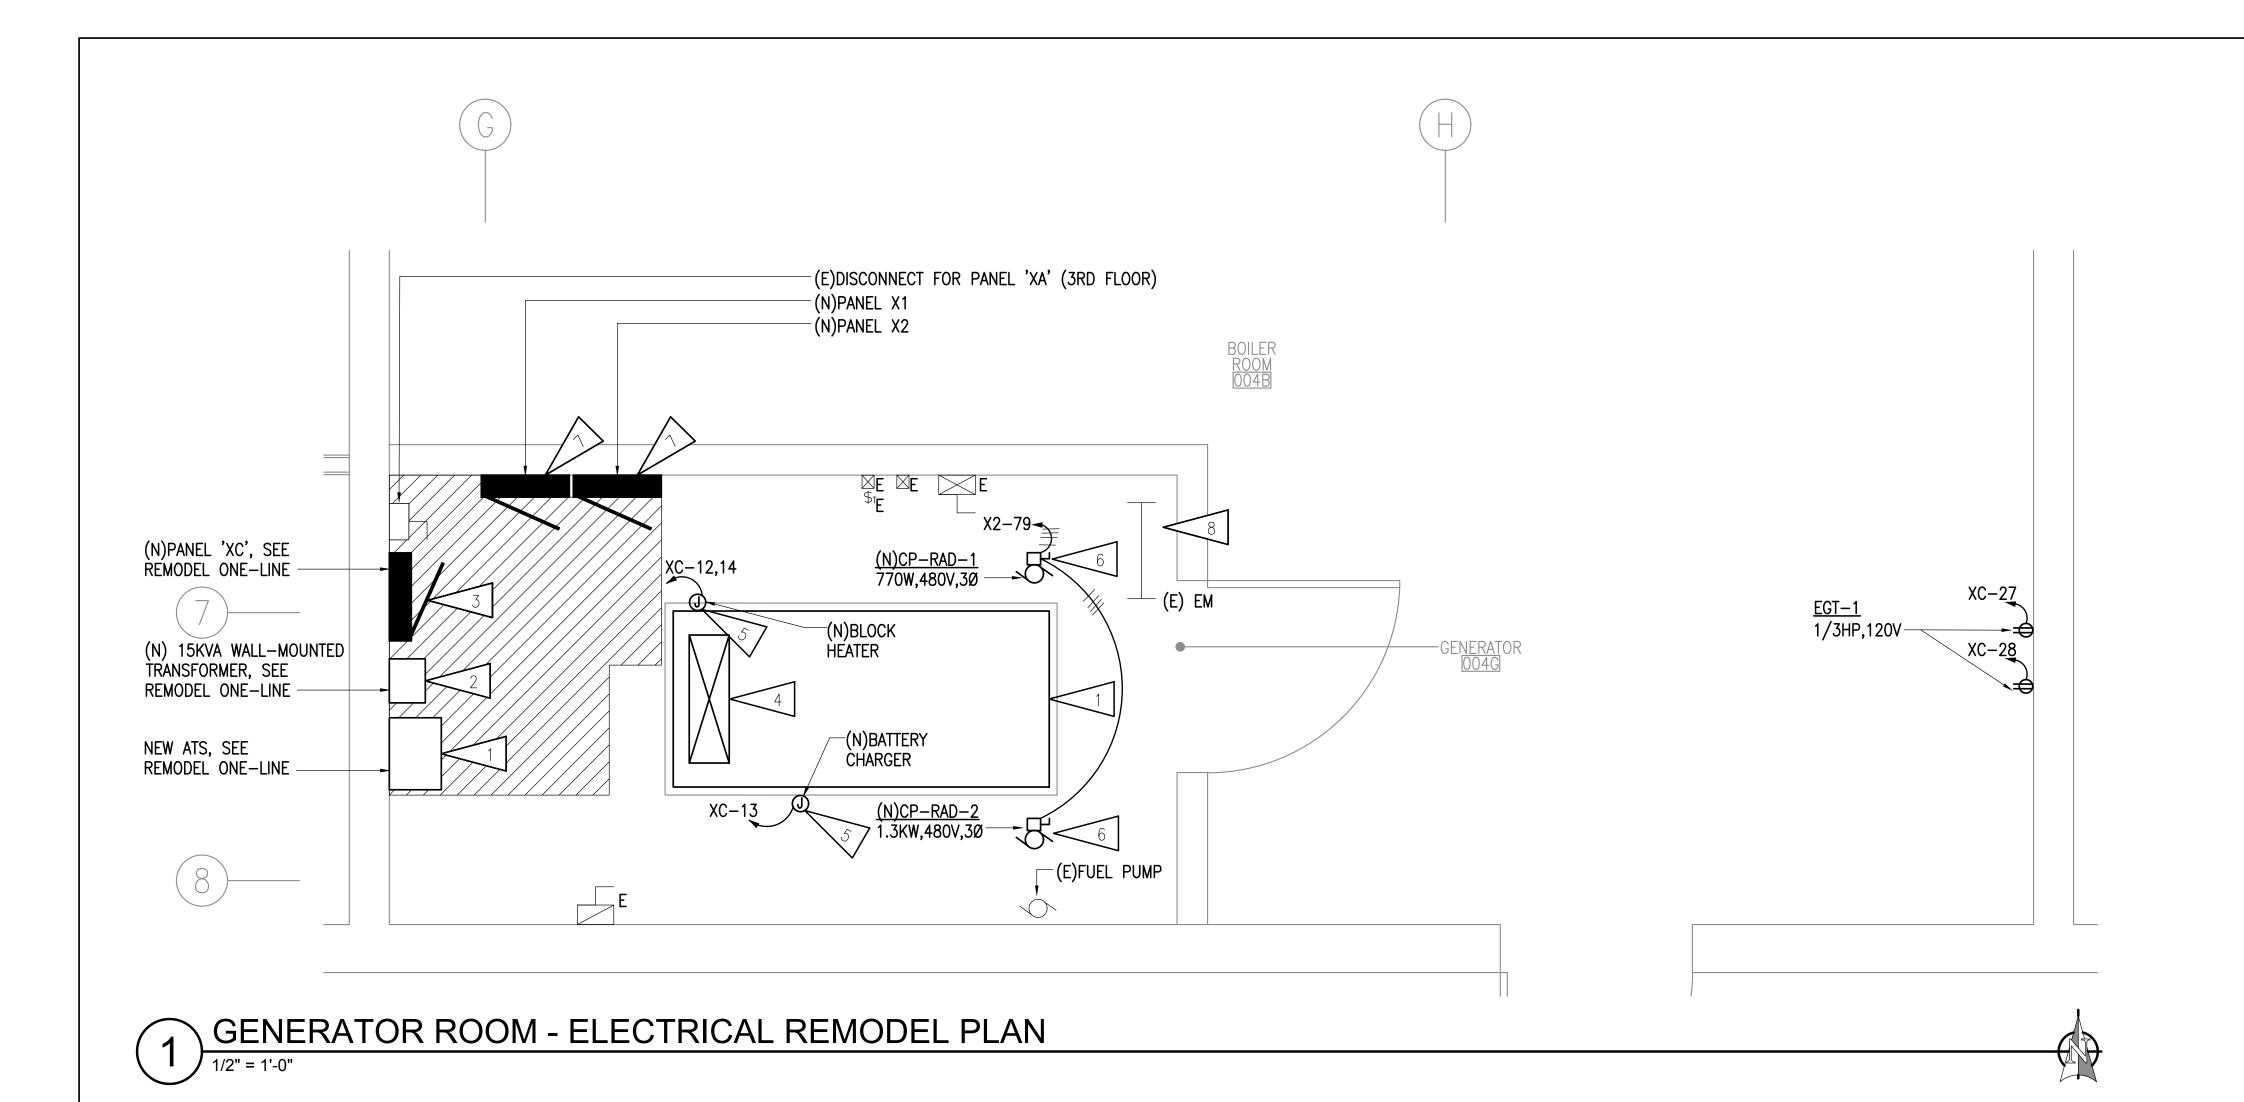

GENERAL NOTES:

- A. SEE REMODEL ONE-LINE DIAGRAM 2/E001 FOR EQUIPMENT
- B. CONTRACTOR SHALL DISCONNECT AND RECONNECT EQUIPMENT IN AREAS OF WORK AS REQUIRED TO INSTALL NEW GENERATOR IN ROOM.
- C. EXTEND AND RECONNECT ALL EXISTING GENERATOR MONITORING DEVICES AND CONNECTIONS (DDC, FIRE ALARM, ETC.). PROVIDE JUNCTION BOXES, CONDUIT AND WIRE AS REQUIRED.


SHEET NOTES:

- 1. NEW PAD MOUNTED STANDBY DIESEL GENERATOR AND WALL MOUNTED ATS. PROVIDE NEW FEEDER AND CONNECT TO NEW EQUIPMENT AT NEW LOCATIONS. SEE REMODEL ONE-LINE DIAGRAM 2/E001.
- PROVIDE NEW 15KVA, 480:208V, 3¢ WALL-MOUNTED TRANSFORMER IN LOCATION INDICATED. PROVIDE EXTENSION OF EXISTING LOCAL CIRCUIT AND CONNECT TO TRANSFORMER AT NEW LOCATION.
- 3. PROVIDE NEW PANELBOARD IN NEW LOCATION. PROVIDE EXTENSION OF SALVAGED CIRCUITS FOR CONNECTION TO NEW PANELBOARD. PROVIDE JUNCTION BOXES, CONDUIT, AND WIRE AS REQUIRED. SEE PANEL SCHEDULE ON SHEET E301 FOR PANELBOARD RATINGS, NEW CIRCUITS, AND EXISTING CIRCUITS THAT ARE TO REMAIN.
- GENERATOR MOUNTED CONTROL PANEL. PROVIDE CONTROL CONNECTION FROM NEW ATS PER MANUFACTURER INSTRUCTIONS.
- PROVIDE EXTENSION OF EXISTING CIRCUIT TO NEW LOAD. PROVIDE JUNCTION BOXES, CONDUIT, AND WIRE AS REQUIRED.
- 6. PROVIDE CONNECTION FOR MECHANICAL EQUIPMENT.
- 7. PROVIDE NEW PANELBOARD IN EXISTING LOCATION. PROVIDE EXTENSION OF SALVAGED CIRCUITS FOR CONNECTION TO NEW PANELBOARD. PROVIDE JUNCTION BOXES, CONDUIT, AND WIRE AS REQUIRED. SEE PANEL SCHEDULE ON SHEET E301 FOR PANELBOARD RATINGS, NEW CIRCUITS, AND EXISTING CIRCUITS THAT ARE TO REMAIN.
- 8. EXISTING EMERGENCY LIGHT TO REMAIN.

SUBMITTAL

PRICING

RSA ENGINEERING, INC. 670 W. FIREWEED, SUITE 200 ANCHORAGE, AK 99503 PHONE: 907-276-0521 FAX: 907-276-1751 CORPORATE NO: AECC542

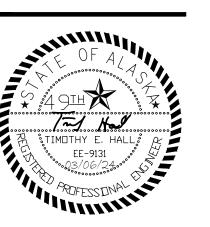

Alaska Court System

Boney Courthouse Generator Replacement

303 K Street Anchorage, Alaska 99501


CONSTRUCTION DOCUMENTS

M3152	JOB NO.
03/06/24	DATE:
TEH	PROJ. MGR.:
BC,NVF	DRAWN BY:
TEH, JAM	REVIEWED BY:
<u> </u>	REVISIONS:


ELECTRICAL REMODEL PLANS


SHEET NO.

E201

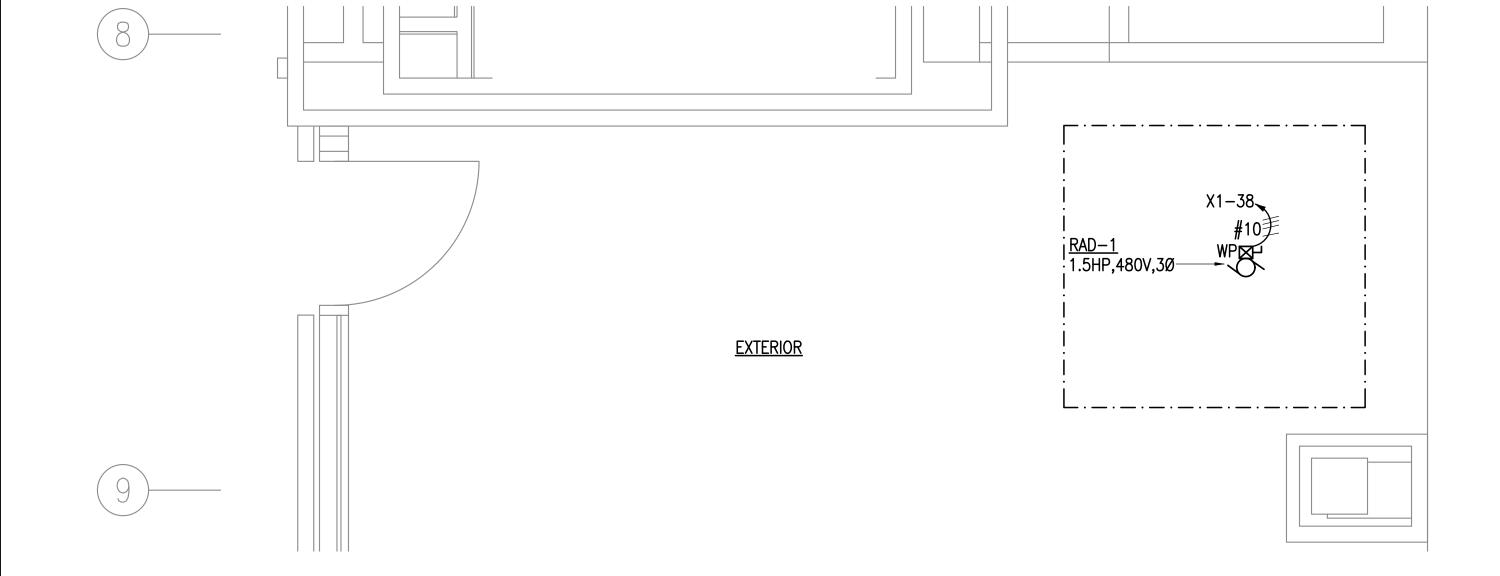

1ST FLOOR - ELECTRICAL REMODEL PLAN

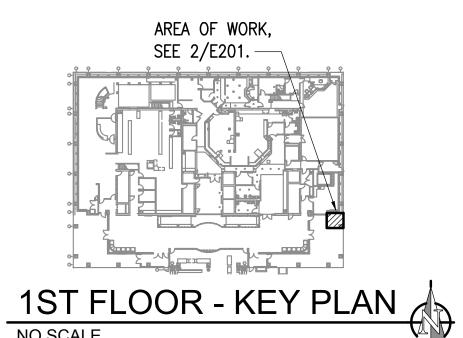

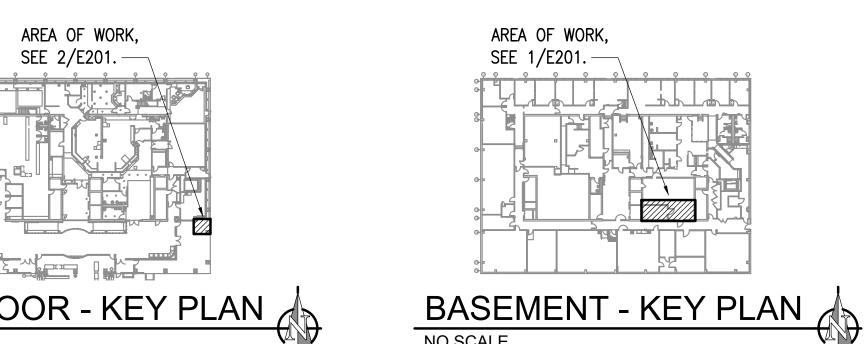

NO SCALE

MFR/MODEL: SQUARE 'D' TYPE NF					LTS: 277/480V	7,3PH,4W	ENCLO	DSURE:	NEMA 1		200 A		
					,	VOLT-AMPS		MTG:	SURFACE				
CIRC	POLE	AMPS	SERVICE	TYPE	A	В	С	TYPE	SERVICE	AMPS	POLE	CIRC	
o 1	3	70	PUMP P-7	/IOTR				FEDR	TRANSFORMER PANEL 'XB'	*	3	2	
o 3	3	70	^^^	/IOTR				FEDR	۸۸۸	*	3	4	
5	3	70	^^^ N	/IOTR				FEDR	۸۸۸	*	3	6	
7	3	20	FAN F-10	/IOTR				MOTR	PUMP P-2	20	3	8	
9	3	20	^^^ N	/IOTR				MOTR	۸۸۸	20	3	10	
11	3	20	^^^ N	/IOTR				MOTR	۸۸۸	20	3	12	
13	3	20	COMPRESSOR (3 HP)	/IOTR			·	MOTR	PUMP P-3	20	3	14	
15	3	20	\^^	/IOTR				MOTR	۸۸۸	20	3	16	
17	3	20	\^^	/IOTR				MOTR	۸۸۸	20	3	18	
19	3	15	BLR 1	/IOTR			·	MOTR	UNIT HEATER #1	20	3	20	
21	3	15	\^\	/IOTR				MOTR	۸۸۸	20	3	22	
23	3	15	\^^	/IOTR				MOTR	۸۸۸	20	3	24	
25	3	15	BLR 2	/IOTR				MOTR	UNIT HEATER #2	20	3	26	
27	3	15	\^\	/IOTR				MOTR	۸۸۸	20	3	28	
29	3	15	\^\	/IOTR				MOTR	۸۸۸	20	3	30	
31	3	15	BLR 3	/IOTR				MOTR	SUMP PUMPS	20	3	32	
33	3	15	\^^	/IOTR				MOTR	۸۸۸	20	3	34	
35	3	15	^^^ N	/IOTR				MOTR	۸۸۸	20	3	36	
37	3	15	JOCKEY PUMP N	/IOTR	831				REMOTE RADIATOR	15	3	38	
39	3	15		/IOTR		831		IVIO I IX	^^^	15	3	40	
41	3	15	\^^^ N	/IOTR			831	MOTR	^^^	15	3	42	
			SECTION 1 V-A ADDED		831	831	831		2,493	VA			
			SECTION 1 AMPS ADDED		3	3	3		3	A	L		

	MFR/MODEL: SQUARE 'D' TYPE NF VOLTS: 277/480V,3PH,4W ENCL							SURE:	NEMA 1		200	Α			
						VOLT-AMPS					MTG: SURFACE				
NOTE	CIRC	POLE	AMPS	SERVICE	TYPE	А	E	3	C		TYPE	SERVICE	AMPS	POLE	CIRC
b	43	3	20	PUMP 1-B	MOTR	4,777					FEDR	TRANSFORMER PANEL 'XC'	25	3	44 b
b	45	3	20	۸۸۸	MOTR			4,561			FEDR	^^^	25	3	46 b
b	47	3	20	^^^	MOTR					5,116	FEDR	۸۸۸	25	3	48 b
b	49	1	20	LTG-RM B26	LTG						LTG	LTG-STAIRWELLS	20	1	50 b
b	51	1	20	LTG-CORRIDOR B25	LTG						LTG	LTG-STAIRWELLS	20	1	52 b
b	53	1	20	LTG-MEZZANINE	LTG						LTG	LTG-4TH FLOOR	20	1_	54 b
b	55	1	20	LTG-1ST FLOOR	LTG						LTG	LTG-5TH FLOOR	20	1_	56 b
b	57	1	20	LTG-2ND FLOOR	LTG							SPARE	20	1_	58
b	59	1	20	LTG-3RD FLOOR	LTG							SPARE	20	1	60
	61	1	20	SPARE								SPARE	20	1	62
	63	1	20	SPARE							LTG	LTG-RMS B55,B67	20	1	64 b
	65	1	20	SPARE								SPACE	-	1	66
	67	1	20	SPARE							FEDR	PANEL 'XD'	*	3	68 b
	69	1	20	SPARE							FEDR	۸۸۸	*	3	70 b
	71	1	20	SPARE							FEDR	۸۸۸	*	3	72 b
	73	1	20	SPARE							HEAT	WATER HEATER WH-21	15	3	74 b
	75	1	20	SPARE							HEAT	٨٨٨	15	3	76 b
	77	1	20	SPARE							HEAT	^^^	15	3	78 b
а	79	3	15	CP-RAD-1 & 2	MOTR	690						SPACE		1_	80
а	81	3	15	^^^	MOTR		690					SPACE		1_	82
а	83	3	15	^^^	MOTR				690			SPACE		1	84
				SECTION 2 V-A ADDED		5,467		5,251		5,806		16,524	VA		
				SECTION 2 AMPS ADDED		20		19		21		20	Α		
				TOTAL V-A ADDED		6,298		6,082		6,637		19,017	VA		
				TOTAL AMPS ADDED		23	<u> </u>	22		24		23	A		
	A.I.C. RATING: 25,000														

PANEL NOTES:

a NEW LOAD CONNECTED TO NEW CIRCUIT.

b EXISTING LOAD AND CIRCUIT THAT WAS DISCONNECTED AND SALVAGED FROM THE DEMOLISHED PANEL 'X'. RECONNECT WIRING TO NEW CIRCUIT BREAKER IN THIS PANEL AND PROVIDE EXTENSION OF EXISTING CIRCUITS AS REQUIRED TO SAFELY CONNECT TO NEW CIRCUIT BREAKERS. SALVAGED LOAD SHALL BE CONNECTED TO NEW BREAKERS MATCHING THE SIZE OF THE PREVIOUS.

PANEL OPTIONS:

MAIN CIRCUIT BREAKER (SEE ONE-LINE FOR SIZE)

NEW PANEL 'XC' MFR/MODEL: SQUARE 'D' TYPE NQ						120/208	V,3PH,4	W		ENCLO	SURE:	NEMA 1	100 A			
					VOLT-AMPS						MTG:	SURFACE				
NOTE	POLE	AMPS	SERVICE	TYPE	A		В		С		TYPE	SERVICE	AMPS	POLE	CIRC	NOTE
c 1	1	15	PUMP P-2	MOTR	215	500						BOILER CONTROL	20	1	2	
b 3	1	20	HANDICAP DOOR OPERATOR	MISC			500	300				BATTERY CHARGING	20	1	4	
c 5	1	20	PUMP P-5	MOTR					696	500	MISC	BOILER MGMT SYSTEM	20	1	6	I
a 7	1	20	GENERATOR RM COOLING FAN	MOTR	1176	180					RECP	RECP-BOILER ROOM	20	1	8	
b 9	1	20	LTG-ELEVATOR PIT GEN ROOM	LTG			300	180				RECP-BOILER ROOM	20	1	10	
b 11	1	20	RECP-ELEVATOR PIT	RECP					180	1500	MISC	GENERATOR BLOCK HEATER	20	2	12	
c 13	1	20	SEWER DRAIN HT	HEAT	500	1000					MISC	۸۸	20	2	14	
c 15	1	15	WATER HEATER 21	MISC			197	180			RECP	RECP-BOILER ROOM	20	1	16	
b 17	1	20	AIR DUCT SMOKE DETECTOR	MISC					200	360	MISC	TV CAMERA	20	1	18	
b 19	1	20	PUMP P-1	MOTR	1176	30					LTG	EMERGENCY LIGHTING UNIT	20	1	20	
b 21	1	20	PUMP P-11	MOTR			1176					SPACE		1	22	1
c 23	1	20	RECP-GEN ROOM	RECP					180	1500	MISC	COMPUTER RM B53 UPS	20	1	24	
25	1	20	SPARE									SPARE	20	1	26	L
27	1	20	EGT-1(1)	MOTR			864	864			MOTR	EGT-1(2)	20	1	28	
29	1	20	SPARE									SPARE	20	1	30	i
31	1	20	SPARE									SPARE	20	1	32	
33			SPACE									SPACE			34	Ĺ
35			SPACE									SPACE			36	Ĺ
37			SPACE									SPACE			38	Ĺ
39			SPACE									SPACE			40	İ
41			SPACE									SPACE			42	L
			TOTAL V-A			4777		4561		5116		14,454	VA			
	TOTAL AMPS				40		38		43		40	Α				
			A.I.C. RATING: 10,000													
				LTG	RECP	MOTR	LG.MT	MISC	KIT	HEAT	SPEC	TOTAL	ŀ	AMPS	3	
		TOTA	L CONNECTED LOAD IN KVA:	0.33	0.90	4.44	0.29	6.56	0.00	0.50	0.00	12.7 KVA	35 A			
	NOT		DEMAND LOAD IN KVA:	0.41	0.90	4.44	0.29	6.56	0.00	0.50	0.00	13.1 KVA OPTIONS:		36	A	

LOAD INFORMATION ESTIMATED BASED ON EQUIPMENT DATA FROM SIMILAR PROJECTS. SIZE BREAKER PER MANUFACTURER RECOMMENDATIONS OF EQUIVALENT SELECTED.

LOAD INFORMATION BASED ON FIELD OBSERVATIONS.

303 K Street

CONSTRUCTION DOCUMENTS

Anchorage, Alaska 99501

SUBMITTAL

RSA ENGINEERING, INC. 670 W. FIREWEED, SUITE 200 ANCHORAGE, AK 99503 PHONE: 907-276-0521 FAX: 907-276-1751 CORPORATE NO: AECC542

PRICING

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REVIEWED BY:	TEH, JAM
REVISIONS:	

Alaska Court System

Courthouse

Replacement

Generator

Boney

PANEL SCHEDULES

SHEET NO.

E301