ALASKA COURT SYSTEM SNOWDEN ADMIN BUILDING MECHANICAL UPGRADES PROJECT ANC-C-23-0001













CONFORMED PERMIT DRAWINGS PACKAGE **AUGUST 8, 2022**

PROJECT TEAM

Alaska Court System Owner

> **Snowden Building** 820 W 4th Avenue Anchorage, AK 99501

Mechanical and **Electrical Engineering** **AMC Engineers**

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Structural

Reid Middleton

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Cost Estimate

Estimations

1225 East Int'l Airport Rd, Suite 205 Anchorage, AK 99518 907.561.0790 www.estimations.com

Hazardous Materials

EHS-Alaska


11901 Business Boulevard, Suite 208 Eagle River, AK 99577 907.694.1383 www.ehs-alaska.com

Landscaping

Huddle 605 W 2nd Avenue


Anchorage, AK 99501 907.223.0136 www.huddleak.com

LOCATION MAP

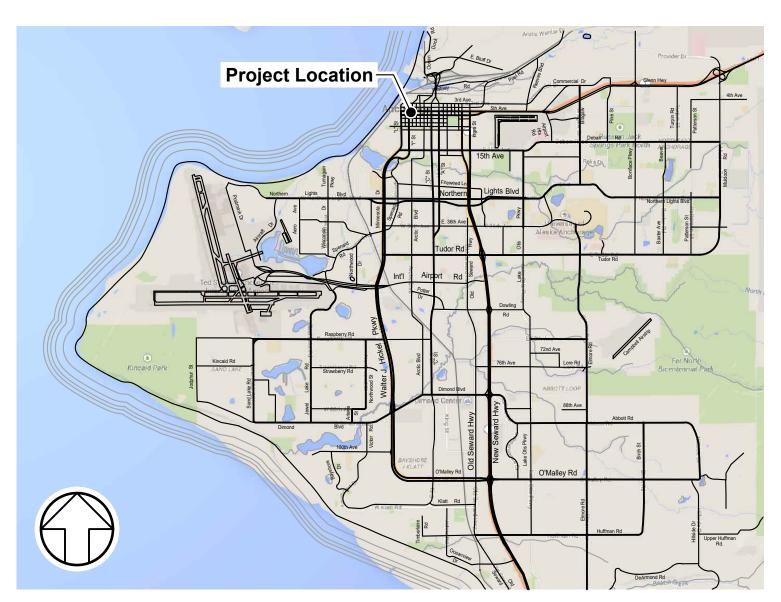

Anchorage, Alaska

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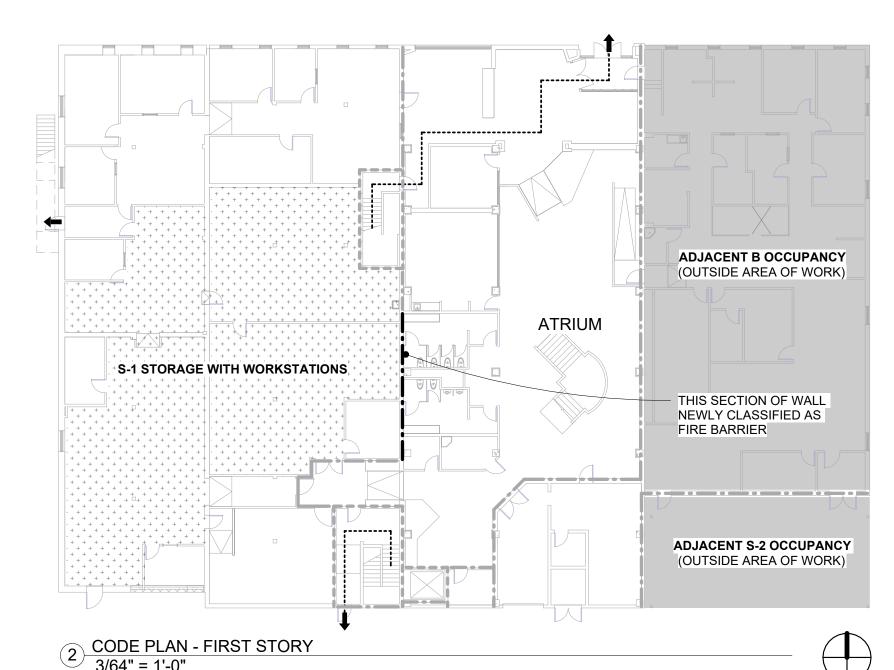
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AMC Project: Sheet Title **COVER SHEET**

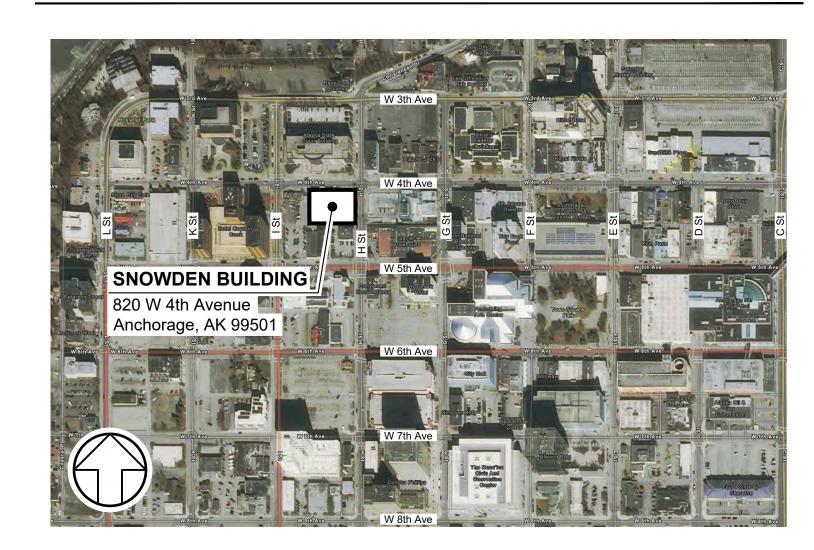Sheet Number



BUILDING CODE ANALYSIS

PROPERTY INFORMATION:

OWNER: STATE OF ALASKA - DEPARTMENT OF NATURAL RESOURCES LEGAL DESCRIPTION: BLOCK 39, LOT 1A-1

PROJECT ADDRESS: 838 W 4TH AVENUE, ANCHORAGE, AK 99501

AUTHORITY HAVING JURISDICTION: MUNICIPALITY OF ANCHORAGE

APPLICABLE CODES:

2018 INTERNATIONAL BUILDING CODE 2018 INTERNATIONAL EXISTING BUILDING CODE 2018 INTERNATIONAL FIRE CODE

2018 INTERNATIONAL MECHANICAL CODE 2017 NATIONAL ELECTRICAL CODE 2018 UNIFORM PLUMBING CODE

2009 ICC/ANSI A117.1 MOA TITLE 21

PROJECT SUMMARY:

THIS PROJECT COMPRISES ALTERATIONS TO HEATING AND VENTILATION SYSTEMS IN A THREE-STORY OFFICE BUILDING WITH LIMITED ARCHITECTURAL ALTERATIONS AS NEEDED FOR THE NEW HEATING AND VENTILATION CONFIGURATION.

IBC BUILDING SUMMARY:

STORIES / AREAS / OCC. ABOVE GRADE: GROUP B / S-1 / S-2 22,233 GSF Unchanged 12,262 GSF GROUP B Unchanged 4,121 GSF **GROUP B** Increased from 3,666 GSF w/ mechanical room addition

BUILDING HEIGHT: 39 FT Unchanged NFPA 13 THROUGHOUT FIRE SPRINKLER SYSTEM: Unchanged FIRE ALARM SYSTEM: EQUIPPED THROUGHOUT Unchanged SEPARATION OF OCCUPANCIES: NONE Unchanged FIRE RATED BLDG ELEMENTS: NONE Unchanged TYPE OF CONSTRUCTION:

The building was previously considered Type V-1HR with the sprinkler system applied as a substitution for building element fire ratings.

IBC CHAPTER 4 - SPECIAL DETAILED REQUIREMENTS

404.5 - SMOKE CONTROL (IN ATRIUMS) SMOKE CONTROL SYSTEM REQUIRED PER 909.

EXCEPTION: NOT REQUIRED WHERE ATRIUM CONNECTS ONLY TWO STORIES.

IBC 2021 verbiage clarifies the intent of this provision, indicating that an atrium may be more than two stories in height but separated from stories above the second story. This verbiage points to section 713.4 to determine the rating for this separation. In this case, because the atrium only extends through three stories, the required rating for the separation from the third story is 1-HR. [ref. IBC 2021 Section 404.5, Exception 2; IBC 2021 Section 713.4.]

In conversation with the Anchorage Building Department and Fire Prevention Department, it was agreed that the design may rely on the above verbiage from IBC 2021. Accordingly, the atrium will not be equipped with a smoke control system, and the entire third floor is separated from the atrium with fire barriers and horizontal assemblies.

404.6- ENCLOSURE OF ATRIUMS

SEPARATE FROM ADJACENT SPACES WITH 1-HR FIRE BARRIERS OR HORIZONTAL ASSEMBLIES.

EXCEPTION 4: NOT REQUIRED WHERE SMOKE CONTROL SYSTEM IS NOT REQUIRED

Smoke control is not required, so enclosure is not required. Separation is provided only between the atrium and the third story as described above.

IBC CHAPTER 5 - GENERAL BUILDING HEIGHTS AND AREAS

TABLE 504.3 - ALLOWABLE BUILDING HEIGHT GROUP B,S (S),(TYPE VB):

GROUP S-2 (SM):

Not exceeded TABLE 504.4 - ALLOWABLE STORIES ABOVE GRADE: GROUP B (S): Not exceeded GROUP S-1 (S): Not exceeded GROUP S-2 (S): Not exceeded TABLE 506.2 - ALLOWABLE BUILDING AREA: GROUP B (SM): 27.000 SF Not exceeded GROUP S-1 (SM) 27,000 SF Not exceeded 40,500 SF

508.4 - SEPARATED OCCUPANCIES

508.4.4 - SEPARATION INDIVIDUAL OCCUPANCIES SHALL BE SEPARATED FROM ADJACENT OCCUPANCIES IN ACCORDANCE WITH TABLE 508.4.

Not exceeded

TABLE 508.4 - REQUIRED SEPARATION OF OCCUPANCIES GROUP B / GROUP S-1: NO SEPARATION REQUIRED

509 - INCIDENTAL USES

Boiler room equipment exceeds limits of Table 509. Boiler room will be equipped with an automatic sprinkler system and construction to resist the passage of smoke.

IBC CHAPTER 7 - FIRE AND SMOKE PROTECTION FEATURES

The routing of the required separation between the atrium and third story is slighly modified with this project. Walls newly interpreted as fire barriers or will be upgraded to meet the requirements of Section 707 and Section 711 respectively.

722.1 - CONCRETE ASSEMBLIES

An existing section of an 8" concrete wall is newly considered a fire barrier. The wall exceeds requirements for a one hour rating in Table 722.2.1.1.

IBC CHAPTER 10 - MEANS OF EGRESS

TABLE 1014.3 - COMMON PATH OF EGRESS TRAVEL B, WITH SPRINKLER SYSTEM: 100 FT MAX. ALLOWABLE

TABLE 1016.2 - EXIT ACCESS TRAVEL DISTANCE B, WITH SPRINKLER SYSTEM:

300 FT MAX. ALLOWABLE

Code plans indicate the longest common path and travel distance in each area of work. No Exit Stairways or Exit Passageways are required to reach the Exit Discharge.

TABLE 1018.1 - CORRIDOR FIRE-RESISTANCE RATING B, WITH SPRINKLER SYSTEM: NO RATING REQUIRED.

1019 - EXIT ACCESS STAIRWAYS AND RAMPS

1019.3 OCCUPANCIES OTHER THAN GROUPS I-2 AND I-3 ENCLOSED WITH SHAFT ENCLOSURE

An existing exterior wall of an Exit Access Stairway converted to a shaft enclosure where the adjacent addition make the wall an interior wall.

IEBC CHAPTER 5 - PRESCRIPTIVE COMPLIANCE METHOD

502.1 GENERAL

ADDITIONS TO ANY BUILDING OR STRUCTURE SHALL COMPLY WITH THE REQUIREMENTS OF THE INTERNATIONAL BUILDING CODE FOR NEW CONSTRUCTION. ALTERATIONS TO THE EXISTING BUILDING OR STRUCTURE SHALL BE MADE TO ENSURE THAT THE EXISTING BUILDING OR STRUCTURE TOGETHER WITH THE ADDITION ARE NOT LESS COMPLYING WITH THE PROVISIONS OF THE INTERNATIONAL BUILDING CODE THAN THE BUILDING OR STRUCTURE WAS PRIOR TO THE ADDITION. AN EXISTING BUILDING TOGETHER WITH ITS ADDITIONS SHALL COMPLY WITH THE HEIGHT AND AREA PROVISIONS OF CHAPTER 5 OF THE INTERNATIONAL BUILDING CODE.

503.1 GENERAL

[...] ALTERATIONS TO ANY BUILDING OR STRUCTURE SHALL COMPLY WITH THE REQUIREMENTS OF THE INTERNATIONAL BUILDING CODE FOR NEW CONSTRUCTION. ALTERATIONS SHALL BE SUCH THAT THE EXISTING BUILDING OR STRUCTURE IS NOT LESS COMPLYING WITH THE PROVISIONS OF THE INTERNATIONAL BUILDING CODE THAN THE EXISTING BUILDING OR STRUCTURE WAS PRIOR TO THE ALTERATION.

All portions of the Addition as well as all altereed aspects of systems and spaces are compliant with the current International Building Code. No aspect of the work decreases the compliance of any aspect of the building

ZONING CODE ANALYSIS

ZONING DISTRICT:

ZONING USE:

OFFICE - NOT CHANGED

ROOFTOP EQUIPMENT SCREENING: EQUIPMENT MUST BE SCREENED FROM ABUTTING STREETS AND RESIDENTIAL LOTS. NO RESIDENTIAL LOTS ABUT THIS PROPERTY. THE ABUTTING STREETS ARE 4TH AVENUE AND H STREET. NO EXISTING OR NEW ROOFTOP EQUIPMENT IS VISIBLE FROM 4TH AVENUE OR H STREET.

FAN ROOM ADDITION

NONCONFORMITIES / AUTHORITY TO CONTINUE (21.13.010.B) : NONCONFORMING LIKELY DUE TO DEATH OF THE PLANTS. THE PLANTING WILL

BRINGING CHARACTERISTICS OF USE INTO COMPLIANCE (21.13.060.C): THE PROJECT MEETS CRITERIA TO REQUIRE BRINGING CHARACTERISTICS OF

THERE ARE CHARACTERISTICS OF USE THAT ARE LEGALLY

THE WORK WILL EXCEED 10% OF THE ASSESSED VALUE OF THE

ATRIUM

IN AN EXISTING PLANTING BED. PLANT COUNTS WERE FOUND TO BE ILLEGALLY BE BROUGHT INTO CONFORMITY WITH CURRENT TITLE 21.

USE INTO COMPLIANCE AS OUTLINED IN TITLE 21:

NONCONFORMING BUT DO NOT CONFORM WITH CURRENT CODE. THE WORK WILL REQUIRE A BUILDING PERMIT

ENTIRE THIRD STORY

THE GROUND FLOOR

ADJACENT B OCCUPANCY

(OUTSIDE AREA OF WORK)

SEPARATED FROM ATRIUM

HORIZONTAL ASSEMBLIES

THAT ARE CONTINUOUS TO

WITH 1-HR FIRE BARRIER AND

3RD FLOOR

2ND FLOOR

1ST FLOOR

24'-0"

11'-0"


CODE LEGEND — — COMMON PATH OF EGRESS EXIT ACCESS TRAVEL DISTANCE BEYOND COMMON PATH 1-HR FIRE BARRIER OR HORIZONTAL ASSEMBLY ---- 1-HR SHAFT ENCLOSURE 1-HR HORIZONTAL ASSEMBLY (IN PLAN) **GROUP S-1 STORAGE WITH** WORKSTATIONS (ALL OTHER AREAS GROUP B) NOT IN SCOPE

MOA ePlan Stamp

NOTIFICATION OF POTENTIAL HAZARDS

ASBESTOS, LEAD, AND OTHER HAZARDOUS MATERIALS ARE PRESENT IN THE BUILDING AND MAY IMPACT THE WORK OF ALL TRADES. REGULATED AIR CONTAMINANTS, INCLUDING ASBESTOS AND LEAD, ARE ALSO PRESENT IN SETTLED AND CONCEALED DUST IN AND ON ARCHITECTURAL, STRUCTURAL, MECHANICAL, AND ELECTRICAL COMPONENTS OR SYSTEMS THROUGHOUT THE BUILDING. ALL TRADES SHALL COORDINATE WITH OTHER TRADES AND CONDUCT THEIR WORK TO PREVENT WORKER EXPOSURE OR SITE CONTAMINATION. REFER TO SPECIFICATION DIVISIONS 0, 1, AND 2 FOR SPECIFIC INFORMATION CONCERNING DISTURBING, REMOVING, AND DISPOSING OF THESE MATERIALS AND THE INSTALLATION OF THE NEW MATERIALS OR COMPONENTS. THIS NOTIFICATION IS PROVIDED IN ACCORDANCE WITH EPA AND OSHA REQUIREMENTS.

www.amc-engineers.com Adams, Morgenthaler & Co., Inc CoA No. C0342 - 907.257.9100 701 E. Tudor Rd. Suite 250 Anchorage, AK 99503

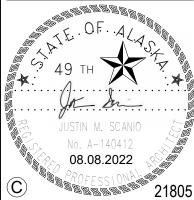

ARCHITECTURE DESIGN STRATEGY 3909 ARCTIC BLVD., STE 100 ANCHORAGE, AK 99503 907.561.5543

> RAD SBB AL, NO ME

√o. Date Description

1 INCH AT FULL SIZE IF NOT 1 INCH, SCALE ACCORDINGLY

Designed by: Checked by: 21805 AMC Project:

08/08/2022 Project Phase PERMIT DRAWINGS

Sheet Title

CODE ANALYSIS

Sheet Number

/ 1/16" = 1'-0"

LLBB

LLH

LLV

LOC

ΙP

LSH

LSL

LONGIT

LINEAL FOOT

LONG LEGS BACK TO BACK

LONG LEG HORIZONTAL

LONG LEG VERTICAL

LOCATION, LOCATE

LONG SLOTTED HOLE

LEVEL, OR LAMINATED

VENEER LUMBER

LAMINATED STRAND

LONGITUDINAL

LOW POINT

LUMBER

MATERIAL

MAXIMUM

MINIMUM

METAL

NEAR FACE

NOMINAL

NUMBER

MACHINE BOLT

MOMENT FRAME

MANUFACTURER

MISCELLANEOUS

MILES PER HOUR

NOT IN CONTRACT

NORTH-SOUTH

NOT TO SCALE

OUTSIDE DIAMETER

ON CENTER

OPENING

OPPOSITE

OUTSIDE FACE

OVERSIZED HOLE

OPEN WEB JOIST

PIECE, PRECAST

PENETRATION

PLACES

PLYWOOD

PARTIAL JOINT

PENETRATION

PRESTRESS

PREFABRICATED

POST-TENSIONED

RAD RADIUS

ROOF DRAIN

REFERENCE

REMAINDER

REINFORCING

POLYVINYL CHLORIDE

PANEL

PERPENDICULAR

POUNDS PER CUBIC FOOT

PLATE, PROPERTY LINE

POUNDS PER LINEAR FOOT

POUNDS PER SQUARE FOOT

POUNDS PER SQUARE INCH

PARALLEL STRAND LUMBER

POINT, PRESSURE TREATED

NEAR SIDE, NONSHRINK

MECHANICAL

LIVE LOAD

SHT

SIM

SJI

SOG

SPC

SPEC

SQ

SS

SSH

STAG

STD

STIFF

STIR

STL

STRUC

SUPP

SYM

SW

T&B

T&G

TEMP

THK

THRU

TOC

TOF

TOS

TR

TRANS

TYP

UON

VERT

VIF

WD

WHS

W/O

WP

WT

WWR

SHEET

SIMILAR

SLAB ON GRADE

SPECIFICATION

STAINLESS STEEL

SQUARE

STANDARD

STIFFENER

STRUCTURAL

SUPPORT

STIRRUP

STEEL

DOUGLAS FIR-LARCH

DIAMETER

DIAGONAL

DIAPHRAGM

DIMENSION

DEAD LOAD

DOWN

DITTO

DEEP

DETAIL

DRAWING

X'-X"

(X'-X'')

[X'-X"]

A A A A A

OII

ASBESTOS, LEAD, AND OTHER HAZARDOUS MATERIALS ARE PRESENT IN THE BUILDING AND MAY IMPACT THE WORK OF ALL TRADES. REGULATED AIR CONTAMINANTS. INCLUDING ASBESTOS AND LEAD, ARE ALSO PRESENT IN SETTLED AND CONCEALED DUST IN AND ON ARCHITECTURAL, STRUCTURAL, MECHANICAL, AND ELECTRICAL COMPONENTS OR SYSTEMS THROUGHOUT THE BUILDING. ALL TRADES SHALL COORDINATE WITH OTHER TRADES AND CONDUCT THEIR WORK TO PREVENT WORKER EXPOSURE OR SITE CONTAMINATION. REFER TO SPECIFICATION DIVISIONS 0, 1, AND 2 FOR SPECIFIC INFORMATION CONCERNING DISTURBING, REMOVING, AND DISPOSING O THESE MATERIALS AND THE INSTALLATION OF THE NEW MATERIALS OR COMPONENTS. THIS NOTIFICATION IS PROVIDED IN ACCORDANCE WITH EPA AND OSHA REQUIREMENTS

TOP OF SLAB RELATIVE TO DATUM

TOP OF WALL OR BEAM ELEVATION

ELEVATION RELATIVE TO DATUM

CONCRETE WALL IN SECTION

CHANGE OF SLAB THICKNESS

RAISED SLAB

BEAM/GIRDER

STEEL IN CROSS SECTION

COLUMN

STEEL SYMBOLS

CONCRETE CURB/PARTIAL HEIGHT

CONCRETE WALL BELOW THIS LEVEL

WORK POINT

-LIMIT OF SPAN

SLOPE

CONCRETE SYMBOLS

-DIRECTION OF SPAN

TOP OF FOOTING RELATIVE TO DATUM

NOTIFICATION OF POTENTIAL HAZARDS

OF ALA ELLEN E. HAMEL No. T13259 8/8/22 PROFESSIONAL 21905

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Trilly !

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4300 B St., Suite 302 Anchorage, AK 99503 Phone 907 562-3439 - www.reidmiddleton.com Corporate License #AECC598 © Copyright Reid Middleton, Inc. 2022

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Revisions					
lo.	Date	Description			

1 INCH AT FULL SIZE IF NOT 1 INCH,

SCALE ACCORDINGLY					
Designed by:	EH				
Checked by:	DS				
AMC Project:	21805				
Date:	8/8/2022				

Project Phase **PERMIT DRAWINGS**

Sheet Title STRUCTURAL

ABBREVIATIONS & SYMBOLS

Sheet Number

S001

GENERAL SYMBOLS

STEEL JOIST INSTITUTE SPACE, SPACED, SPACING SHORT SLOTTED HOLE STAGGER. STAGGERED

SYMMETRICAL, SYMMETRY SHEAR WALL TOP OF TOP AND BOTTOM TONGUE AND GROOVE TEMPERATURE THICK, THICKNESS THROUGH TOP OF CONCRETE TOP OF FOOTING TOP OF STEEL THREADED ROD TRANSVERSE


UNLESS OTHERWISE NOTED


VERTICAL VERIFY IN FIELD


TYPICAL

WIDTH, WIDE FLANGE WITH WELDED HEADED STUD WITHOUT **WORK POINT** WEIGHT WELDED WIRE REINFORCEMENT

X **GRID BUBBLE GRID LINE** NORTH NORTH ARROW SOIL OPENING IN FLOOR OR WALL DIMENSION PER ARCHITECT DIMENSION PER MECHANICAL OR

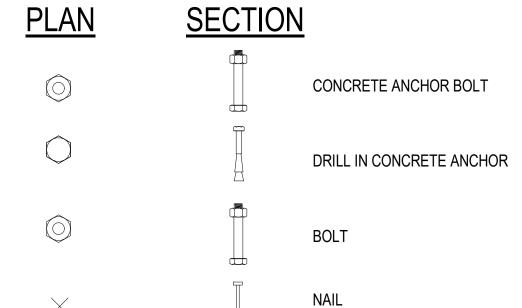

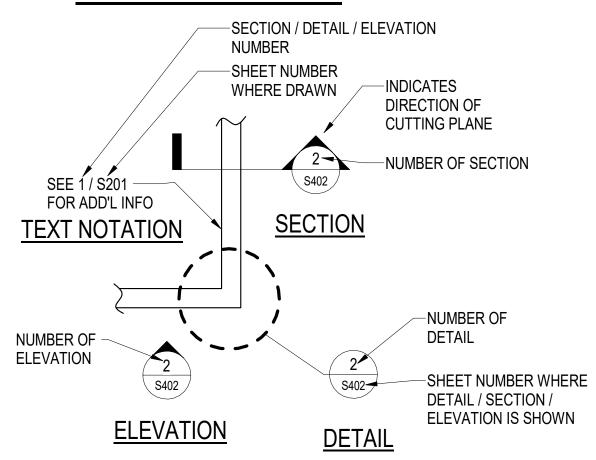

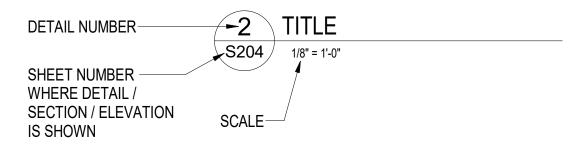

DETAIL IDENTIFIERS

CENTER-TO-CENTER CDF CONTROL DENSITY FILL COLD-FORMED **CENTER OF GRAVITY** CAST-IN-PLACE CONTROL JOINT, **CONSTRUCTION JOINT COMPLETE JOINT** PENETRATION CENTERLINE CEILING **CLEAR CONCRETE MASONRY UNIT COLUMN** CONCRETE CONNECTION CONSTRUCTION CONTINUE, CONTINUOUS CONTRACTOR COORDINATE COMPLETE PENETRATION

DEMOLISH, DEMOLITION

DOUGLAS FIR

AND

ABOVE & BELOW

AMERICAN CONCRETE

ABOVE FINISHED FLOOR

AMERICAN INSTITUTE OF

AMERICAN IRON AND STEEL

STEEL CONSTRUCTION

ANCHOR BOLT

INSTITUTE

ADDITIONAL

ADHESIVE

ΑT

A&B

ACI

ADD'L

ADH

AFF

AISC

AISI

AR

B/

BAL

BF

BM

BU

CANT

CC

CF

DB

DBA

DBL

DBN

DEG, °

DEMO

DF

LVL DWL DOWEL INSTITUTE ALT ALTERNATE **EXIST EXISTING** ALUM ALUMINUM MATL EΑ **EACH ANCH** ANCHOR, ANCHORAGE MAX EE EACH END APA AMERICAN PLYWOOD MB EF EACH FACE ASSOCIATION **MECH** EJ **EXPANSION JOINT APPROX APPROXIMATE** MF **ELEVATION** ANCHOR ROD MFR EMB, EMBED **EMBEDMENT ARCH** ARCHITECT, MIN **ENGR ENGINEER ARCHITECTURAL MISC** EQ EARTHQUAKE, EQUAL ARND AROUND MPH **EQUIP EQUIPMENT ASCE** AMERICAN SOCIETY OF CIVIL MTL ES EACH SIDE **ENGINEERS** ETC **ASSY** ET CETERA ASSEMBLY E-W **EAST-WEST ASTM** AMERICAN SOCIETY FOR NIC **TESTING AND MATERIALS** EXP **EXPANSION** NOM **AWS** AMERICAN WELDING EXT **EXTERIOR** NO, # SOCIETY N-S FD FLOOR DRAIN NS **BOTTOM OF** FDN FOUNDATION NTS BALANCE **FEMA** FEDERAL EMERGENCY BRACED FRAME MANAGEMENT AGENCY OC BLDG BUILDING FF FAR FACE, FINISH FLOOR OD BLKG BLOCKING FIN **FINISH** OF BEAM FLR **FLOOR OPNG** BOD **BOTTOM OF DECK** FLG **FLANGE** OPP BOT **BOTTOM** FOW FACE OF WALL BRG OSH BEARING FS FAR SIDE OWJ **BSMT BASEMENT** FT, ' FEET **BTWN BETWEEN**

DFL

DIA, Ø

DIAG

DIAPH

DIM

DL

DN

DO

DP

DTL

DWG

FTG FOOTING PC BUILT-UP PCF GA **GAUGE** PEN CAMBER, CHANNEL GALV GALVANIZED **PERP** CANTILEVER GB **GRADE BREAK** CAPACITY GEN **GENERAL** GLUED LAMINATED MEMBER GL, GLULAM PLF GLUED LAMINATED BEAM GLB PLWD GR GRADE PNL GRND GROUND **GWB** GYPSUM WALL BOARD **PREFAB** HF HEM-FIR PS HGR HANGER

CG CIP CJP, CP PSF HK HOOK CL PSI HKP HOUSE KEEPING PAD CLG PSL HORIZ, H **HORIZONTAL** CLR HP HIGH POINT CMU P-T **HSB** HIGH STRENGTH BOLT COL PVC HSS HOLLOW STRUCTURAL CONC SECTION CONN HT HEIGHT CONST RD CONT REF **IBC** INTERNATIONAL BUILDING REINF CODE

CONTR COORD ID INSIDE DIAMETER CP IF INSIDE FACE CRSI CONCRETE REINFORCED IN, " INCH STEEL INSTITUTE INCL **INCLUDE** CTR CENTER, CENTERED **INFO** INFORMATION CY CUBIC YARD INT INTERIOR IJ ISOLATION JOINT PENNYWEIGHT (NAILS)

> DIVIDER BEAM, DROPPED JST **JOIST** JT **JOINT** DEFORMED BAR ANCHOR DOUBLE KIP (1,000 LB) DIAPHRAGM BOUNDARY KSF KIPS PER SQUARE FOOT NAILING KSI DEGREE

> > LB, #

LENGTH, ANGLE

POUND

KIPS PER SQUARE INCH

REQD REQUIRED RND ROUND RO **ROUGH OPENING** RTN RETURN

REM

SBN

SC

SCHED

SECT

SHEAR WALL BOUNDARY NAILING SLIP CRITICAL

SCHEDULE SECTION

ELECTRICAL

CONNECTORS

<u>PLAN</u>	<u>SECTION</u>
	CONCRETE ANCHOR BOLT
	DRILL IN CONCRETE ANCHOR
	BOLT

DETAIL LABEL

ALL NEW CONSTRUCTION SHALL COMPLY WITH THE 2018 INTERNATIONAL BUILDING CODE (IBC) AS AMENDED AND ADOPTED BY THE MUNICIPALITY OF ANCHORAGE (MOA).

SAFETY - THE CONTRACTOR IS RESPONSIBLE FOR MEETING ALL FEDERAL, STATE AND LOCAL SAFETY STANDARDS. THE CONTRACTOR IS IN CHARGE OF ALL SAFETY MATTERS ON AND AROUND THE JOB

STRUCTURAL DESIGN DATA

STRUCTURAL DESIGN IS IN ACCORDANCE WITH THE IBC AND THE 2018 INTERNATIONAL BUILDING CODE (IEBC) AS AMENDED AND ADOPTED BY THE MUNICIPALITY OF ANCHORAGE. RISK CATEGORY IS II IN ACCORDANCE WITH IBC SECTION 1604.5.

WORK BEING PERFORMED UNDER THIS PROJECT IS CLASSIFIED AS THE FOLLOWING UNDER THE

ALTERATION - LEVEL 2

REFER TO ARCHITECTURAL DRAWINGS FOR ELEVATIONS, SLOPES, DEPRESSIONS, NON-BEARING WALLS, FIRE-PROOFING, FASCIA, CURBS, DRAINS, RAILINGS, WATERPROOFING, FINISHES, ETC.

THE STRUCTURE HAS BEEN DESIGNED FOR THE FOLLOWING OPERATIONAL LOADS ON THE COMPLETED STRUCTURES. CONTRACTOR IS RESPONSIBLE FOR TEMPORARY SHORING AND BRACING DURING CONSTRUCTION.

NEW 3rd FLOOR MECHANICAL ROOM = 40 PSF, EXCEPT AT FOOTPRINT OF AHU, 42 PSF

SNOW LOADS: GROUND SNOW (Pg) = 50 PSF Is=1.0, Ct=1.0, Ce=1.0

ROOF SNOW (Pf) = 40 PSF FLAT + DRIFT

WIND LOADS: BASIC WIND SPEED (3-SECOND GUST, Vult)=130 MPH EXPOSURE B, INTERNAL PRESSURE GCpi=±0.55 (PARTIALLY ENCLOSED)

SEISMIC LOADS: SITE CLASS D, SEISMIC DESIGN CATEGORY D,

Ss=1.5, S1=0.676, Sds=1.2, Sd1=0.766, le=1.0

NEW ROOFTOP MECHANICAL SPACE: R=6.5 (LIGHT FRAMED STEEL SHEET WALLS), Ω o=3, Cd=4, ρ =1.0, Cs=0.185

LATERAL ANALYSIS IS LINEAR STATIC . LATERAL FORCES ARE CARRIED BY THE FLEXIBLE ROOF AND FLOOR DIAPHRAGMS TO THE SHEAR WALLS. MOMENTS, SHEARS, AND ROTATIONAL FORCES ARE DELIVERED TO THE FOUNDATION BY THE SHEAR WALLS IN PROPORTION TO THEIR TRIBUTARY AREA.

CONTRACTOR SHALL VERIFY ALL EXISTING DIMENSIONS, MEMBER SIZES, AND CONDITIONS PRIOR TO COMMENCING WORK. DIMENSIONS OF EXISTING CONSTRUCTION SHOWN ON THE DRAWINGS ARE INTENDED AS GUIDELINES ONLY AND MUST BE VERIFIED. EXISTING CONDITIONS SHOWN ON DRAWINGS ARE BASED ON EITHER SITE OBSERVATIONS, ORIGINAL DRAWINGS, OR WERE ASSUMED BASED ON EXPECTED CONDITIONS. IF EXISTING CONDITIONS DO NOT CLOSELY MATCH CONDITIONS SHOWN ON DRAWINGS. OR IF EXISTING MATERIALS ARE OF QUESTIONABLE OR SUBSTANDARD QUALITY, NOTIFY ENGINEER PRIOR TO COMMENCING WORK.

SPECIAL INSPECTION

THE OWNER SHALL ENGAGE A SPECIAL INSPECTOR PER CHAPTER 17 OF THE IBC. SEE STATEMENT OF SPECIAL INSPECTIONS ON SHEET S003. COPIES OF INSPECTION REPORTS SHALL BE AVAILABLE TO THE CONSTRUCTION SITE FOR REVIEW BY THE MOA BUILDING SAFETY PERSONNEL.

DEFERRED SUBMITTALS

THE FOLLOWING ITEM IS NOT INCLUDED IN THESE DRAWINGS AND REQUIRE STRUCTURAL DESIGN TO BE FURNISHED BY THE CONTRACTOR:

1. EXTERIOR CLADDING

DRAWINGS AND CALCULATIONS FOR BUILDER-DESIGNED COMPONENTS. SEALED BY AN ALASKA STATE REGISTERED PROFESSIONAL ENGINEER RESPONSIBLE FOR THE DESIGN, SHALL BE SUBMITTED TO THE ENGINEER FOR REVIEW FOR GENERAL CONFORMANCE TO THE CONTRACT DOCUMENTS PRIOR TO SUBMITTING TO BUILDING SAFETY FOR REVIEW. SUBMITTALS OF BUILDER-DESIGNED ITEMS SHALL INCLUDE LOCATIONS, MAGNITUDES, AND DIRECTIONS OF ALL FORCES TRANSFERRED TO THE STRUCTURE. DEFERRED SUBMITTALS MUST BE REVIEWED AND APPROVED BY BUILDING SAFETY PRIOR TO INSTALLATION/CONSTRUCTION.

<u>SUBMITTALS</u>

THE CONTRACTOR SHALL REVIEW, STAMP WITH THEIR APPROVAL, DATE AND SIGN ALL SHOP DRAWINGS AND SUBMITTALS REQUIRED BY THE CONTRACT DRAWINGS PRIOR TO SUBMITTAL TO THE ENGINEER. AT THE TIME OF SUBMISSION, THE CONTRACTOR SHALL INFORM THE ENGINEER IN WRITING OF ANY DEVIATION IN THE SHOP DRAWINGS FROM THE REQUIREMENTS OF THE CONTRACT DRAWINGS. DIMENSIONS AND QUANTITIES ARE THE CONTRACTOR'S RESPONSIBILITY AND WILL NOT BE REVIEWED.

STRUCTURAL CONCRETE

ALL CONCRETE CONSTRUCTION SHALL CONFORM TO ACI 301, STANDARD SPECIFICATION FOR STRUCTURAL CONCRETE. AS MODIFIED BY IBC SECTION 1905 AND LOCAL ADOPTED AMENDMENTS.

- ALL CAST-IN-PLACE CONCRETE:
- 1. EXPOSURE F0, S0, W0, C0 (ACI 318-14, 19.3.1.1) 2. MINIMUM 28-DAY COMPRESSIVE STRENGTH = 4,500 PSI
- 3 MAXIMUM AGGREGATE SIZE = 3/4"
- 4. MAXIMUM WATER-CEMENT RATIO = 0.45
- 5. MAXIMUM CHLORIDE ION CONTENT = 1.00%
- 6. TARGET AIR CONTENT = 6% (+/-1%), EXCEPT FOR TROWELED INTERIOR SLABS WHICH SHALL
- NOT EXCEED 3% AIR CONTENT.

CONCRETE SHALL BE PROPORTIONED TO ACHIEVE A WORKABLE MIX THAT CAN BE PLACED WITHOUT SEGREGATION OR EXCESS FREE SURFACE WATER.

STRUCTURAL CONCRETE (CONTINUED) APPLICABLE ASTM STANDARDS PORTLAND CEMENT = ASTM C150 AGGREGATE = ASTM C33, NORMAL WEIGHT

WATER = ASTM C1602 WATER REDUCING ADMIXTURE = ASTM C494, TYPE A

CONCRETE PLACED DURING COLD WEATHER SHALL CONFORM TO ACI 306. ALL COLD WEATHER CONCRETE AND CONCRETE EXPOSED TO WEATHER SHALL CONTAIN AIR ENTRAINMENT PER ACI 318-14 TABLE 19.3.3.1.

THE FOLLOWING MINIMUM CONCRETE COVER SHALL BE PROVIDED FOR REINFORCEMENT FOR CAST-IN-PLACE CONCRETE:

2-INCHES

A. CONCRETE CAST AGAINST EARTH 3-INCHES B. CONCRETE EXPOSED TO EARTH OR WEATHER

1½-INCHES -#5 AND SMALLER 3/4-INCH C. CONCRETE NOT EXPOSED TO EARTH OR WEATHER

ALL CONCRETE REINFORCING SHALL BE DETAILED, FABRICATED, LABELED, SUPPORTED AND SPACED IN FORMS AND SECURED IN PLACE IN ACCORDANCE WITH THE LATEST EDITIONS OF ACI 315, ACI 318, CRSI MSP-1 AND ACI SP-66. DOWELS SHALL MATCH SIZE AND NUMBER OF MAIN REINFORCING

TYPICAL REINFORCING BARS SHALL BE ASTM A615, GRADE 60. LAP SPLICES SHALL BE CLASS B LAPS PER ACI (63 X BAR DIAMETER). LAP SPLICES MAY ALSO ACCOMPLISHED USING MECHANICAL DEVICES THAT DEVELOP 125% OF THE STRENGTH OF THE REBAR.

STRUCTURAL MASONRY

-#6 AND LARGER

HOLLOW LOAD BEARING CONCRETE MASONRY UNITS SHALL CONFORM TO ASTM C90, GRADE N, TYPE I, NORMAL WEIGHT, WITH A MINIMUM ULTIMATE COMPRESSIVE STRENGTH OF 2,800 PSI. PROTECT UNITS FROM MOISTURE PRIOR TO INSTALLATION.

MORTAR SHALL MEET ASTM C270, TYPE S. PROPORTIONS SHALL COMPLY WITH TMS 602-16 TABLE SC-1. MINIMUM 28 DAY COMPRESSIVE STRENGTH = 1,800 PSI.

GROUT SHALL MEET ASTM C476. PROPORTIONS SHALL COMPLY WITH TMS 602-16 TABLE SC-7 MINIMUM COMPRESSIVE STRENGTH = 2.000 PSI. PROVIDE ADEQUATE TEMPORARY BRACING DURING CONSTRUCTION TO WITHSTAND LATERAL LOADS AND THE PRESSURES OF FLUID GROUT.

THE MINIMUM DESIGN STRENGTH OF THE MASONRY ASSEMBLAGE (MASONRY UNITS, MORTAR, AND GROUT) f'm = 2,000 PSI.

CMU SHALL BE LAID IN RUNNING BOND, AND CONSTRUCTION SHALL COMPLY WITH TMS 602-16 SECTION 3.3.

REINFORCING BARS SHALL CONFORM TO ASTM A615, GRADE 60. WELDABLE REINFORCING SHALL MEET A706 AND SHALL BE WELDED PER ANSI/AWS D1.4. LAP SPLICES SHALL BE PER TMS 402-16 SECTION 6.1.6.1.1 (43 X BAR DIAMETER).

TYPICAL REINFORCEMENT FOR 8" WALL (NOMINAL):

-VERTICAL: #5 @ 24" OC, AND IN CORNER AND ENDWALL CELLS. -HORIZONTAL (BOND BEAMS): #5 @ 48" OC, (2) #5 AT ROOF/FLOOR LEVELS.

-AT ENDS OF WALLS OR OPENINGS, TERMINATE BOND BEAM REINFORCEMENT IN A STANDARD 180-DEGREE HOOK AROUND THE VERTICAL REINFORCEMENT.

VERTICAL CELLS TO BE FILLED WITH GROUT SHALL BE ALIGNED TO PROVIDE A CONTINUOUS, UNOBSTRUCTED OPENING. CELLS WHICH WILL CONTAIN VERTICAL REINFORCING SHALL HAVE A MINIMUM FOUR (4) INCH CLEAR OPENING.

POST-INSTALLED ANCHORS

INSTALLATION SHALL CONFORM TO MANUFACTURER'S INSTRUCTIONS AND REQUIREMENTS OF ICC-ES REPORT. ALL POST-INSTALLED ANCHORS SHALL HAVE A CURRENT ICC-ES REPORT AND BE AUTHORIZED FOR USE IN SEISMIC DESIGN CATEGORY D. PERIODIC SPECIAL INSPECTION IS REQUIRED FOR ALL POST-INSTALLED ANCHORS, UON. INSTALLATION OF ADHESIVE ANCHORS HORIZONTALLY OR UPWARDLY INCLINED SHALL BE PERFORMED BY ACI/CRSI CERTIFIED PERSONNEL ONLY AND REQUIRES CONTINUOUS SPECIAL INSPECTION.

THREADED ROD SHALL BE ASTM A307, UON (OR ISO898 CLASS 5.8), TENSILE STRENGTH OF 60 KSI MIN, AND GALVANIZED WHERE EXPOSED TO THE WEATHER.

EXISTING BASE SHALL BE SCANNED PRIOR TO DRILLING HOLES. EXISTING REBAR LOCATIONS SHALL BE MARKED. AND NEW ANCHOR LOCATIONS REVISED TO AVOID EXISTING REINFORCING. NO REINFORCING BARS SHALL BE CUT TO INSTALL ANCHORS. ALL DEFECTIVE ANCHOR HOLES SHALL BE GROUTED AND A NEW HOLE DRILLED A MINIMUM OF 3 BOLT DIAMETERS AWAY.

ADHESIVE ANCHORS FOR THREADED ROD AND REBAR SHALL BE ONE OF THE FOLLOWING (OR AN APPROVED EQUIVALENT):

CONCRETE: -DEWALT "PURE110+" (ESR-3298)

-HILTI "HIT-HY 200 SAFE SET" (ESR-3187) -EPCON "A7+" (ESR-3903) -SIMPSON "SET-XP" (ESR-2508)

MASONRY (SOLID & UNGROUTED)

-SIMPSON "SET-XP" (IAPMO UES ER-265) -HILTI "HY-270" (ESR-4143 GROUTED CMU or ESR-4144 UNGROUTED CMU) -DEWALT "AC100+gold" (ESR-3200)

EXPANSION ANCHORS SHALL BE ONE OF THE FOLLOWING (OR AN APPROVED EQUIVALENT):

CONCRETE:

-HILTI "KWIK BOLT TZ2" (ESR-4266) -SIMPSON "STRONG-BOLT 2" (ESR-3037) -DEWALT "POWER-STUD+SD2" (ESR-2502) SOLID GROUTED MASONRY:

-HILTI "KWIK BOLT 3" (ESR-1385) -SIMPSON "WEDGE-ALL" (ESR-1396) -DEWALT "POWER-STUD+SD1" (ESR-2966)

SCREW ANCHORS IN CONCRETE AND GROUT FILLED MASONRY SHALL BE ONE OF THE FOLLOWING (OR AN APPROVED EQUIVALENT):

-HILTI "KH-EZ" (ESR-3027 CONC, ESR-3056 CMU) -SIMPSON "TITEN HD" (ESR-2713 CONC, ESR-1056 CMU) -ITW "TAPCON" (ESR-2202 CONC, ESR-1671 CMU) -DEWALT "SCREW-BOLT+" (ESR-3889 CONC, ESR-4042 CMU <u>SSTRUCTURAL STEEL</u>

MATERIALS:

ASTM A992 **WIDE-FLANGE SHAPES:** ASTM A53, GRADE B

ALL OTHER SHAPES & PLATE: ASTM A36 BOLTS, WASHERS & NUTS: ASTM F3125, F436 & A563 **ANCHOR RODS: ASTM F1554, GRADE 36**

ALL DETAILING, FABRICATION AND ERECTIONS SHALL CONFORM TO AISC SPECIFICATIONS AND CODES, LATEST EDITION. FABRICATOR MUST PARTICIPATE IN THE AISC QUALITY CERTIFICATION PROGRAM, BE CERTIFIED BY THE MUNICIPALITY OF ANCHORAGE, OR SPECIAL INSPECTIONS AT THE CONTRACTOR'S EXPENSE, MUST BE PROVIDED IN THE FABRICATION SHOP.

ALL WELDING SHALL BE DONE BY QUALIFIED WELDERS AND SHALL CONFORM TO THE AWS D1.1 AND D1.8, LATEST EDITIONS. ALL WELDING ELECTRODES SHALL BE PROPERLY CONDITIONED 70 KSI MINIMUM TENSILE STRENGTH, WITH DIFFUSED HYDROGEN LEVELS OF 16ml/g (H16) OR LESS IN ACCORDANCE WITH AWS A4.3.

WELDS NOT SPECIFIED SHALL BE SHOP-PERFORMED CONTINUOUS OR ALL-AROUND 3/16" FILLET

STEEL DECK AND COLD-FORMED STEEL MAY BE WELDED WITH E60 ELECTRODES. WELDING SHALL BE IN ACCORDANCE WITH AWS D1.3, "SPECIFICATION FOR THE WELDING OF SHEET STEEL IN STRUCTURES".

THERE SHALL BE NO FIELD CUTTING OF STRUCTURAL STEEL MEMBERS FOR THE WORK OF OTHER TRADES WITHOUT THE PRIOR APPROVAL OF THE ENGINEER.

ALL CONNECTIONS SHALL BE SIMPLE, SINGLE PLATE SHEAR CONNECTIONS USING HIGH-STRENGTH BEARING TYPE BOLTS WITH THREADS INCLUDED IN THE SHEAR PLANE, A325-N. UON. NUTS SHALL BE SNUG-TIGHT, UON. ONE PLY OF THE CONNECTION SHALL USE SHORT-SLOTTED HOLES ORIENTED HORIZONTALLY.

THE CONTRACTOR SHALL BE RESPONSIBLE FOR THE CONTROL OF ALL ERECTION PROCEDURES AND SEQUENCES. CONSIDERATION SHOULD BE GIVEN TO TEMPERATURE DIFFERENTIALS, ESPECIALLY WITH RESPECT TO STRUCTURAL STEEL FRAMING INTO CONCRETE WALLS, BEAMS, OR COLUMNS.

ALL STEEL SHALL BE CLEANED BY METHODS COMPLYING WITH THE STEEL STRUCTURES PAINTING COUNCIL METHOD SSPC-SP3, POWER TOOL CLEANING. REMOVE OIL, GREASE, AND SIMILAR CONTAMINANTS. EXCEPT FOR MEMBERS TO BE WELDED, APPLY STRUCTURAL STEEL PRIMER PAINT IN ACCORDANCE WITH THE MANUFACTURERS INSTRUCTIONS TO A UNIFORM DRY FILM THICKNESS OF 2.0 MILS. AFTER FINAL STEEL INSTALLATION, WIRE BRUSH EXPOSED STEEL SURFACES AND CLEAN WITH SOLVENTS BEFORE TOUCH-UP PAINTING. TOUCH-UP PAINT SHALL BE THE SAME AS SHOP PAINT STRUCTURAL STEEL TO RECEIVE SPRAY-APPLIED FIRE-PROOFING MAY BE SUPPLIED AS BARE STEEL.

STEEL EXPOSED TO WEATHER OR INDICATED AS GALVANIZED SHALL BE HOT-DIP GALVANIZED PER ASTM A123. TOUCH-UP AND REPAIR GALVANIZATION SHALL CONFORM TO ASTM A780. FASTENERS SHALL COMPLY WITH ASTM A153.

THE CONTRACTOR SHALL SUBMIT SHOP DRAWINGS TO THE ENGINEER FOR REVIEW. THESE DRAWINGS SHALL BE CHECKED BY THE CONTRACTOR BEFORE SUBMITTAL AND SHALL SHOW SHOP FABRICATION DETAILS, FIELD ASSEMBLY DETAILS, AND ERECTION DIAGRAMS FOR ALL STRUCTURAL STEEL. ALSO SUBMIT WELDERS' QUALIFICATIONS.

ALL STEEL DECKING SHALL MEET ASTM A 653-SS, GRADE 50, WITH A MINIMUM YIELD STRENGTH OF 50 KSI. ALL DECKING SHALL BE GALVANIZED PER ASTM A653-G60. ALL ROOF METAL DECK SHALL BE LAPPED A MINIMUM OF 2-INCHES.

MINIMUM DECK GAGES ARE SHOWN ON PLANS AND ARE BASED ON 3-SPAN, UNSHORED CONDITIONS. HEAVIER DECK MAY BE REQUIRED FOR OTHER CONDITIONS, DEPENDING ON THE MANUFACTURER'S AND CONTRACTOR'S LAYOUT. ALL DECK SHALL SATISFY AISI, "SPECIFICATION FOR THE DESIGN OF COLD FORMED STEEL STRUCTURAL MEMBERS".

FASTEN STEEL DECKING PER SCHEDULE:

SIDE LAPS: BUTTON PUNCH AT 24" OC

ROOF DECK, Q-design(ASD)= 154 PLF: SUPPORTING STEEL: 36/4 PATTERN, 7/8-INCH DIAMETER VISUAL (1/2-INCH EFFECTIVE) PUDDLE WELDS AT 12-INCH ON-CENTER.

"PUNCHLOK" OR "DELTA-GRIP" OR OTHER ENHANCED PUNCHING CONNECTION SYSTEM MAY BE SUBSTITUTED FOR ROOF SIDE LAPS. AND MECHANICAL 'PAF' FASTENERS MAY BE SUBSTITUTED FOR SUPPORTING STEEL CONNECTIONS. CONTRACTOR SHALL SUBMIT CALCULATIONS TO SHOW UNIT SHEAR CAPACITIES OF ALTERNATE FASTENER LAYOUT EXCEEDS THE "Q-design" INDICATED ABOVE.

PROVIDE CONTINUOUS METAL CLOSURES AT ALL SLAB OPENINGS AND SLAB EDGES AND CONTINUOUS DECK CLOSURE AT ALL DECK ENDS. PROVIDE, AS REQUIRED, ALL RIDGE AND VALLEY PLATES. COLUMN CLOSURES. CANT STRIPS. SUMP PLATES AT PIPING PENETRATIONS AND RECESSED. SUMP PANS AT ALL ROOF DRAINS. PROVIDE SUPPLEMENTAL FRAMING AT OPENINGS AS REQUIRED FOR SUPPORT OF THE METAL DECK. ALL OPENING SIZES AND LOCATIONS SHALL BE COORDINATED WITH ARCHITECTURAL AND MECHANICAL DRAWINGS.

THE DECK SUPPLIER SHALL CONFIRM THE DECK SIZE FOR THE ACTUAL LAYOUT AND PROVIDE THE ENGINEER WITH ENGINEERING CALCULATIONS OR PUBLISHED MANUFACTURER'S DATA VERIFYING THE SPECIFIED DECK REQUIREMENTS.

PROVIDE CHECKED SHOP DRAWINGS INDICATING LOCATION, GAGE, AND SIZE OF EACH PIECE OF DECKING. THE DRAWINGS SHALL CLEARLY SHOW WELDING DETAILS TO STRUCTURAL FRAMING AND SIDE LAP CONNECTIONS DETAILS.

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NOTIFICATION OF POTENTIAL HAZARDS

ASBESTOS, LEAD, AND OTHER HAZARDOUS MATERIALS ARE PRESENT IN THE BUILDING AND MAY IMPACT THE WORK OF ALL TRADES. REGULATED AIR CONTAMINANTS, INCLUDING ASBESTOS AND LEAD, ARE ALSO PRESENT IN SETTLED AND CONCEALED DUST IN AND ON ARCHITECTURAL, STRUCTURAL, MECHANICAL, AND ELECTRICAL COMPONENTS OR SYSTEMS THROUGHOUT THE BUILDING. ALL TRADES SHALL COORDINATE WITH OTHER TRADES AND CONDUCT THEIR WORK TO PREVENT WORKER EXPOSURE OR SITE CONTAMINATION. REFER TO SPECIFICATION DIVISIONS 0, 1, AND 2 FOR SPECIFIC INFORMATION CONCERNING DISTURBING, REMOVING, AND DISPOSING O THESE MATERIALS AND THE INSTALLATION OF THE NEW MATERIALS OR COMPONENTS. THIS NOTIFICATION IS PROVIDED IN ACCORDANCE WITH EPA AND OSHA REQUIREMENTS

COLD FORMED STEEL SHALL MEET ASTM A1003 STRUCTURAL GRADE 50 TYPE H (Fy=50 KSI) FOR 14 GAUGE (68 MIL) OR 16 GAUGE (54 MIL) MEMBERS AND ASTM A1003 STRUCTURAL GRADE 33 TYPE H (Fy-33 KSI) FOR 18 GAUGE (43 MIL) AND LIGHTER MEMBERS.

ALL STRUCTURAL MEMBERS SHALL BE DESIGNED PER THE AMERICAN IRON AND STEEL INSTITUTE (AISI) "SPECIFICATION FOR THE DESIGN OF COLD-FORMED STEEL STRUCTURAL MEMBERS". LATEST EDITION.

USE ONLY ONE MANUFACTURER OF COLD FORMED JOIST THROUGHOUT THE WORK, UNLESS OTHERWISE SHOWN ON THE DRAWINGS OR SPECIFICALLY APPROVED IN ADVANCE BY THE ENGINEER ACCEPTABLE JOIST MANUFACTURERS INCLUDE ANY MEMBER OF THE STEEL STUD MANUFACTURER'S ASSOCIATION.

PROVIDED ALL ACCESSORIES INCLUDING TRACKS, CLIPS, WEB STIFFENERS, ANCHORS, FASTENING DEVICES, RESILIENT CLIPS, AND OTHER ITEMS REQUIRED FOR A COMPLETE AND PROPER INSTALLATION. INSTALL ALL ITEMS RECOMMENDED BY THE MANUFACTURER

FASTENING OF COMPONENTS SHALL BE WITH SELF-DRILLING SCREWS (ASTM C1513) OR WELDS OF SUFFICIENT SIZE TO INSURE THE STRENGTH OF THE CONNECTION. WIRE TYING OF COMPONENTS SHALL NOT BE PERMITTED. ALL WELDS SHALL BE TOUCHED UP WITH A ZINC-RICH PAINT.

UNLESS OTHERWISE INDICATED:

- 1. TRACKS SHALL BE CONNECTED WITH TWO 1/4 SCREWS OR PAF TO SUPPORTING SUBSTRATE AT EACH STUD, OR AN EQUIVALENT EQUAL SPACING;
- 2. OVERLAPPING STUDS OR BRACES SHALL BE CONNECTED WITH THREE #8 SCREWS; 3. STUDS SHALL BE CONNECTED TO TOP AND BOTTOM TRACKS WITH TWO 1/4 SCREWS, ONE AT
- 4. BUILT-UP MEMBERS SHALL BE STITCHED TOGETHER WITH WELDS OR #8 SCREWS AT EACH CORNER AT 6-INCHES ON-CENTER.

PROVIDE COMMERCIAL GROUT FOR LEVELING THE FLOOR RUNNER OF STEEL STUD PARTITIONS AS REQUIRED.

METAL STUD SHEAR WALLS SHALL BE MADE FROM MINIMUM 18 GAUGE (43 MIL) STUDS, TRACKS, AND BLOCKING. BLOCK ALL PANEL EDGES WITH STIFFENED C-SHAPE STUDS OR A 43 MIL x 1-1/2" FLAT STRAP (INSTALLED BETWEEN THE METAL STUDS AND THE SHEATHING).

FOR ROOFTOP METAL STUD SHEARWALLS LABELLED "SW6", PROVIDE THE FOLLOWING: 0.027" STEEL SHEATHING, ONE SIDE

STRUCTURAL TIMBER

MATERIALS:

DIMENSIONAL LUMBER: HEM-FIR NO. 2 OR BETTER

#8 @ 4" OC AT PANEL EDGES. 12" OC AT ALL OTHER SUPPORTS

THERE SHALL BE NO FIELD CUTTING OF STRUCTURAL TIMBER MEMBERS FOR THE WORK OF OTHER TRADES WITHOUT THE PRIOR REVIEW OF THE ENGINEER.

ALL NAILS SHALL BE COMMON WIRE SMOOTH SHANK NAILS. PER ASTM F1667. UNLESS NOTED OTHERWISE. OTHER NAILS PER ESR-1539 ARE ALLOWED WITH NUMBER OR SPACING ADJUSTMENTS. SUBMIT DEFERRED SUBMITTAL FOR ALTERNATE FASTENERS. NAILING SHALL CONFORM TO TABLE 2304.10.1 OF THE IBC. MINIMUM NAIL DIMENSIONS ARE AS FOLLOWS:

<u>NAILSIZE</u>	<u>LENGTH</u>	DIAMETER	HEAD DIAMETER
8d	2-1/2"	0.131"	0.281"
10d	3"	0.148"	0.312"
16d	3-1/2"	0.162"	0.344"

NAILS OR STAPLES SHALL BE DRIVEN FLUSH; HEADS SHALL NOT BE DRIVEN BEYOND TIMBER SURFACE. STANDARD ASTM A307 BOLTS SHALL BE USED IN STD HOLES. WASHERS SHALL BE USED UNDER ALL BOLT HEADS AND NUTS CONTACTING WOOD.

PRE-MANUFACTURED HARDWARE SHALL BE SIMPSON OR APPROVED EQUAL. FASTENERS FOR METAL CONNECTORS SHALL CONFORM TO MANUFACTURER'S RECOMMENDATIONS FOR THE HIGHEST CAPACITY AVAILABLE FOR EACH CONNECTOR, UNLESS OTHERWISE NOTED

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Revisions No. Date Description

1 INCH AT FULL SIZE IF NOT 1 INCH, SCALE ACCORDINGLY esigned by: Checked by:

21805 AMC Project: 8/8/2022 Project Phase **PERMIT DRAWINGS**

Sheet Title STRUCTURAL

GENERAL NOTES

Sheet Number

			SPECIAL INSPECTION & TESTING SCHEDULE	
ITEM	C.I.	P.I.	REFERENCE STANDARD	REMARKS
PREFABRICATED ITEMS	X	Χ	IBC 1704.2.5	REQUIRED FOR STRUCTURAL, LOAD-BEARING, OR LATERAL LOAD-RESISTING MEMBERS OR ASSEMBLIES UNLESS OTHERWISE APPROVED BY BUILDING OFFICIAL
CONCRETE:			ACI 318-14, 301-16, 302.1R-15, ACI 311.1R-07; ACI 311.4R-05; IBC 1705.3, TABLE 1705.3	
GROUTING AND REBAR		Χ		
POST-INSTALLED ANCHORS; VERIFY CERTIFICATION PRIOR TO INSTALLING HORIZONTAL OR INCLINED ADHESIVE ANCHORS	(SEE NOTE)	Х	ACI 318 17.8, 26.7.1(i); ICC-ES REPORT	PER MANUFACTURER REQUIREMENTS, INCLUDES THE DRILLING & CLEANING OUT OF THE HOLES & THE INSTALLATION OF THE ANCHORS. INSTALLATION OF ADHESIVE ANCHORS HORIZONTALLY OR UPWARDLY INCLINED SHALL BE PERFORMED BY ACI/CRSI CERTIFIED PERSONNEL ONLY AND REQUIRE CONTINUOUS INSPECTION.
MASONRY:			TMS 402-16: 3.1 "LEVEL 2" QUALITY ASSURANCE; 2018 IBC 1705.4	
GROUTING AND REBAR		Χ		
POST-INSTALLED ANCHORS	Х	Х	ICC-ES REPORT	PERIOID OR CONTINUOUS PER ICC-ES REPORT. INCLUDES THE DRILLING & CLEANING OUT OF THE HOLES & THE INSTALLATION OF THE ANCHORS
COLD-FORMED STEEL FRAMING:			AISI: S100-16; IBC: 1705.11.2, 1705.12.3	SPECIAL INSPECTION ONLY REQUIRED WHEN METAL STUDS USED AS PART OF THE LATERAL FORCE RESISTING SYSTEM
MATERIAL GRADE, MEMBER SIZE & GAGE		Χ		
DETAILS OF COLD-FORMED FRAMING		Χ		BLOCKING, CONNECTIONS, BRIDGING, BEARING, HANGERS
SCREWING OF ALL SHEAR WALLS AND ROOF DIAPHRAGMS		Χ		INCLUDING GAUGE OF FRAMING.
SIZES AND LOCATIONS OF ALL HOLDOWNS		Χ		
SIZES, LOCATIONS OF ALL STRAPS AND BRACES		Х		
SIZES, SPACINGS OF SILL ANCHORS		Χ		
SCHEDULE NOTES:				

1. ITEMS MARKED WITH AN "X" REQUIRE INSPECTION BY A SPECIAL INSPECTOR, ITEMS INDICATED WITH A "T" REQUIRE THE SPECIAL INSPECTOR TO OBSERVE QUALITY CONTROL TESTING BY THE CONTRACTOR.

2. C.I. = CONTINUOUS SPECIAL INSPECTION DURING PROGRESS OF WORK.

3. P.I. = PERIODIC SPECIAL INSPECTION DURING PROGRESS OF WORK.

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NOTIFICATION OF POTENTIAL HAZARDS

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STATEMENT OF SPECIAL INSPECTIONS

THE FOLLOWING STRUCTURAL SYSTEMS ARE PART OF THE DESIGNATED LATERAL FORCE RESISTING SYSTEMS IN THE BUILDING AND HENCE ARE SUBJECT TO THE REQUIREMENTS OF THIS STATEMENT OF SPECIAL INSPECTIONS AND THE STRUCTURAL SPECIAL INSPECTION AND TESTING SCHEDULE IN ACCORDANCE WITH IBC SECTION 1704.3.

- METAL DECK DIAPHRAGMS
- COLD-FORMED STEEL SHEAR WALLS

SPECIAL INSPECTIONS AND TESTING

THE OWNER SHALL ENGAGE A SPECIAL INSPECTOR PER CHAPTER 17 OF THE IBC. SPECIAL INSPECTION AND TESTING OF THE DESIGNATED SEISMIC SYSTEMS AND OTHER BUILDING STRUCTURE COMPONENTS SHALL BE AS OUTLINED IN THE SPECIAL INSPECTIONS AND TESTING SCHEDULE. WHERE REQUIREMENTS OVERLAP, THE MORE STRINGENT IS TO BE USED.

SPECIAL INSPECTION IS NOT REQUIRED FOR COMPONENTS FABRICATED IN A SHOP APPROVED BY THE MUNICIPALITY OF ANCHORAGE TO PERFORM SUCH WORK WITHOUT SPECIAL INSPECTION. SPECIAL INSPECTION ON STEEL ELEMENTS THAT ARE PART OF THE LATERAL FORCE RESISTING SYSTEM MARKED WITH AN "O" SHALL BE OBSERVED ON A RANDOM DAILY BASIS PER AISC 341-16 J5.

DISTRIBUTION OF REPORTS

COPIES OF THE SPECIAL INSPECTION AND TEST REPORTS SHALL BE DISTRIBUTED TO THE MUNICIPALITY OF ANCHORAGE BUILDING SAFETY DIVISION, THE GENERAL CONTRACTOR, THE ENGINEER OF RECORD, AND THE ARCHITECT OF RECORD. REPORTS SHALL BE COMPLETED DAILY AND DISTRIBUTED ON A WEEKLY BASIS AND SHALL BE DISTRIBUTED BY THE MONDAY FOLLOWING THE WEEK IN WHICH THE INSPECTION OR TEST WAS COMPLETED. A COPY OF ALL SPECIAL INSPECTION REPORTS, DEFICIENCIES, AND CORRECTIVE ACTIONS SHALL BE MAINTAINED AT THE JOB SITE.


STRUCTURAL OBSERVATIONS

STRUCTURAL OBSERVATIONS ARE NOT REQUIRED FOR THIS PROJECT.

CONTRACTOR STATEMENT OF RESPONSIBILITY

CONTRACTOR SHALL SUBMIT A WRITTEN STATEMENT OF RESPONSIBILITY TO THE OWNER AND THE MOA, IN ACCORDANCE WITH IBC 1704.4. THE STATEMENT SHALL ACKNOWLEDGE AWARENESS OF THE SPECIAL REQUIREMENTS OF THE QUALITY ASSURANCE PLAN; ACKNOWLEDGE THAT CONTROL WILL BE EXERCISED TO OBTAIN CONFORMANCE WITH THE CONSTRUCTION DOCUMENTS; IDENTIFY PROCEDURES FOR EXERCISING CONTROL; THE METHOD AND FREQUENCY OF REPORTING, AND THE DISTRIBUTION OF REPORTS; AND IDENTIFY PERSONS THAT WILL EXERCISE CONTROL AND THEIR QUALIFICATIONS.



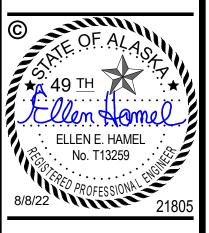

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ALASKA COURT SYSTEM SNOWDEN ADMIN BUILDING MECHANICAL UPGRADES

Revisions							
No.	Date	Description					

1 INCH AT FULL SIZE

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Designed by: EH
Checked by: DS
AMC Project: 21805
Date: 8/8/2022

Project Phase
PERMIT DRAWINGS

Sheet Title

SPECIAL INSPECTION

Sheet Number


NOTIFICATION OF POTENTIAL HAZARDS

COMPONENTS & CLADDING WIND LOADS							
ZONE	10 SF	20 SF	50 SF	100 SF			
2 - END ZONE	-77 PSF	-73 PSF	-67 PSF	-63 PSF			
5 - END ZONE WALL	-49 PSF	-47 PSF	-43 PSF	-41 PSF			

END ZONE ROOF

<u>LEGEND</u>


1. THE WIND LOADS LISTED ABOVE ARE GROSS ULTIMATE AND ARE TO BE USED WITH LOAD COMBINATIONS IN ASCE 7-16.

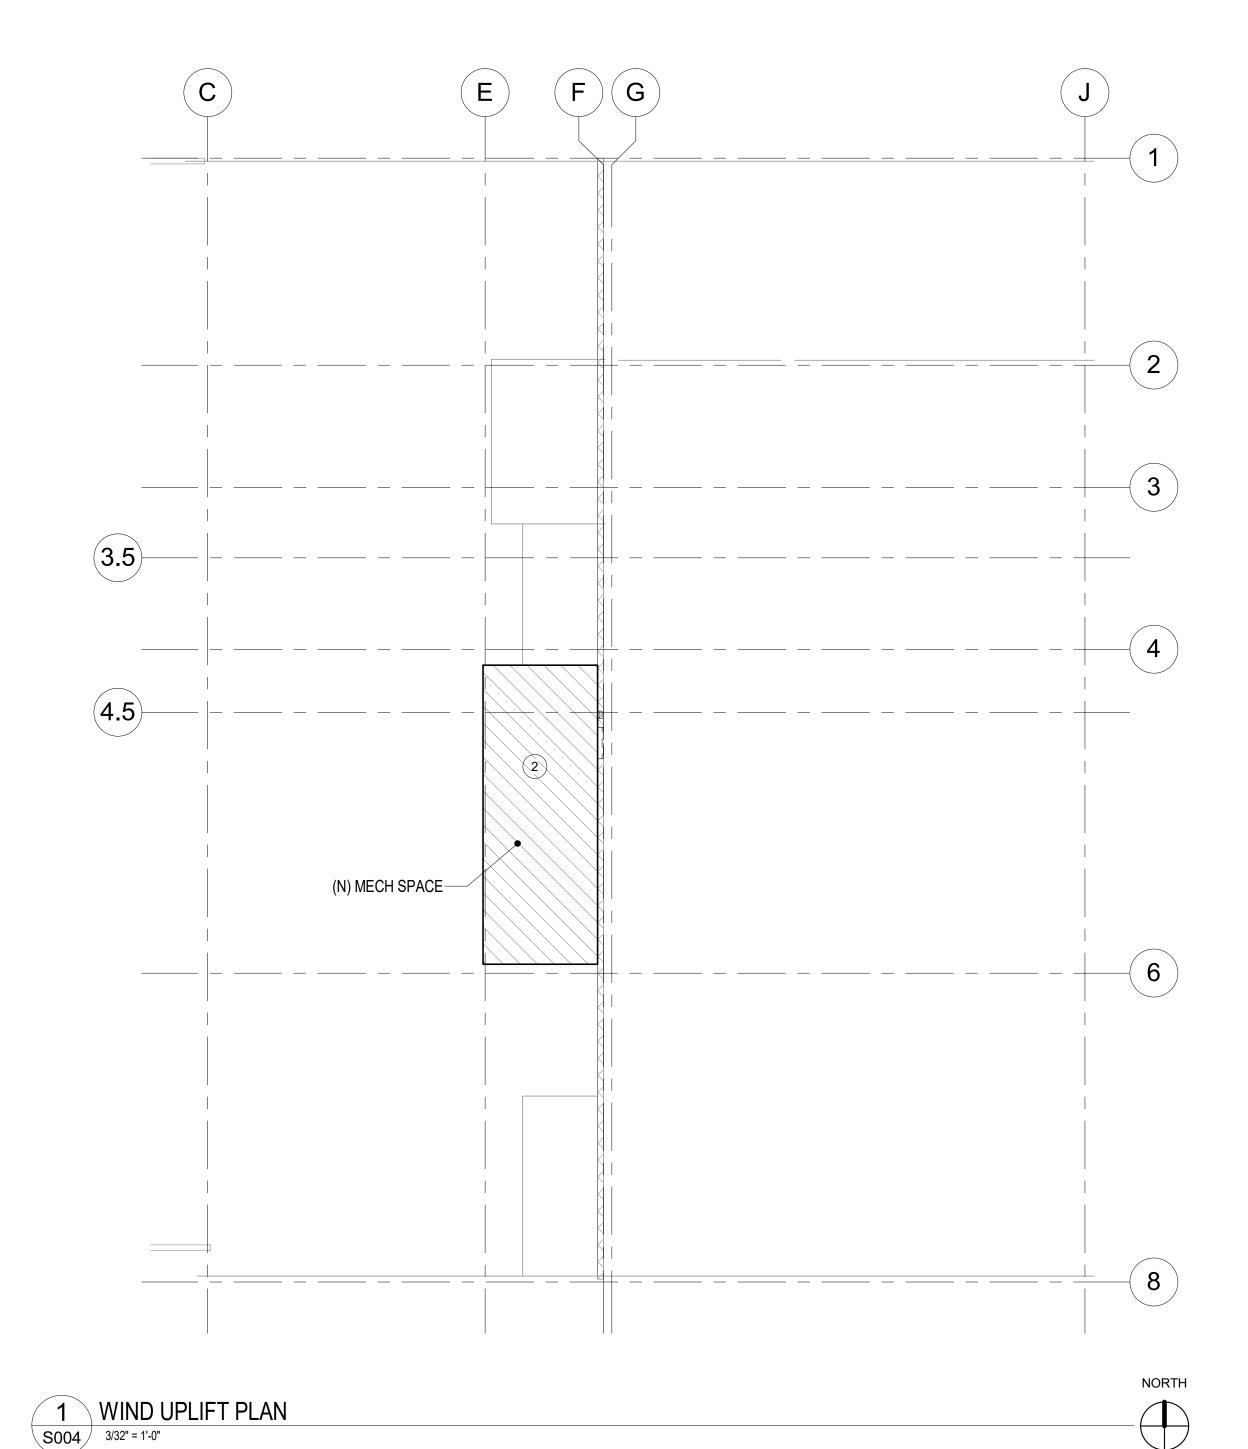


NOTE:

1. SNOW DRIFT LOADS ONLY CONSIDERED WITHIN REGION SHOWN. SNOW DRIFT DUE TO EXISTING STRUCTURES IS NOT ADDRESSED UNLESS OVERLAP EXISTS BETWEEN EXISTING STRUCTURE DRIFT AND DRIFT DUE TO NEW MECHANICAL SPACE.

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2 SNOW DRIFT PLAN S004 3/32" = 1'-0"

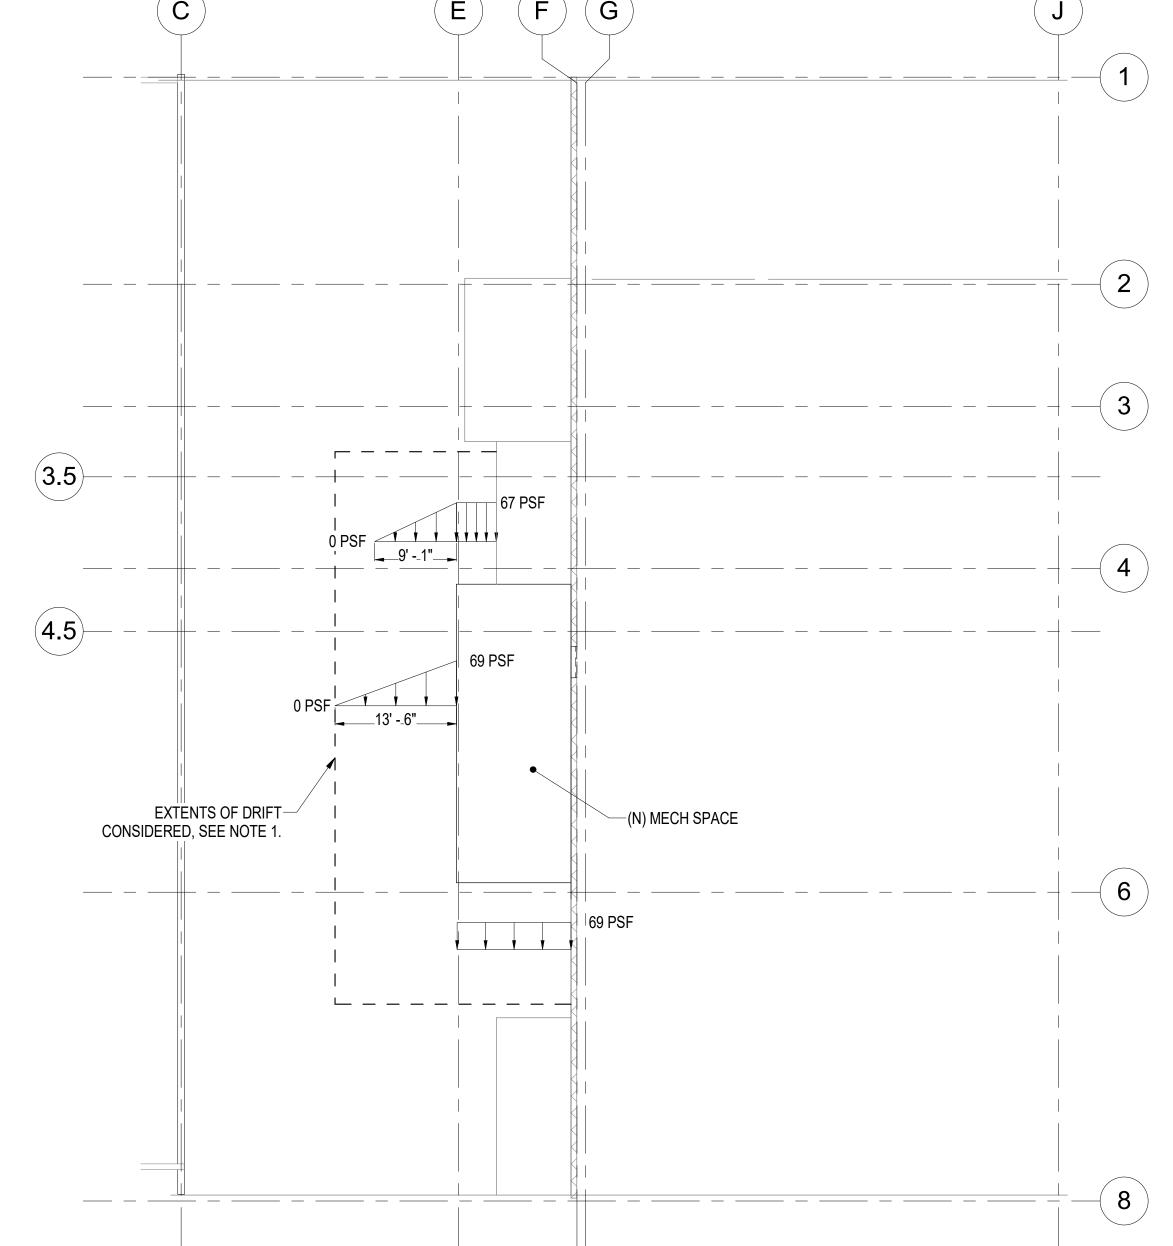

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No. Date Description
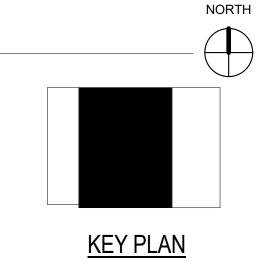
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Designed by: Checked by: 21805 AMC Project: 8/8/2022

Project Phase PERMIT DRAWINGS

Sheet Title LOAD MAPS

Sheet Number

 (H)

31' - 11"

NORTH

(G)

19' - 7"

S201

13' - 2"

(D)

15' - 4"

15' - 6"

MOA ePLANS STAMP

NOTIFICATION OF POTENTIAL HAZARDS

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ELLEN E. HAMEL

No. T13259

8/8/22

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ALASKA COURT SYSTEM SNOWDEN ADMIN BUILDING MECHANICAL UPGRADES

Revisions					
Date	Description				

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AMC Project:	21805
Date:	8/8/2022

Project Phase
PERMIT DRAWINGS

Sheet Title

FIRST FLOOR PLAN
- STRUCTURAL

Sheet Number

15' - 6"

H

BUILDING ZONE B

S201

31' - 11"

MOA ePLANS STAMP

NOTIFICATION OF POTENTIAL HAZARDS

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8

NORTH

- NOTES:
 1. FOR HOUSE KEEPING PAD DETAIL, SEE 2/S505.
- 2. FOR SEISMIC ANCHORAGE OF MECHANICAL EQUIPMENT, SEE SHEET S505.

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Project Phase PERMIT DRAWINGS

Sheet Title

SECOND FLOOR PLAN -STRUCTURAL

Sheet Number

S102

KEY PLAN

8

SECOND FLOOR PLAN

BUILDING ZONE C1

BUILDING ZONE C1

19' - 7"

2 S201

31' - 11"

BUILDING ZONE B

15' - 6"

NOTIFICATION OF POTENTIAL HAZARDS

ASBESTOS, LEAD, AND OTHER HAZARDOUS MATERIALS ARE PRESENT IN THE BUILDING AND MAY IMPACT THE WORK OF ALL TRADES. REGULATED AIR CONTAMINANTS, INCLUDING ASBESTOS AND LEAD, ARE ALSO PRESENT IN SETTLED AND CONCEALED DUST IN AND ON ARCHITECTURAL, STRUCTURAL, MECHANICAL, AND ELECTRICAL COMPONENTS OR SYSTEMS THROUGHOUT THE BUILDING. ALL TRADES SHALL COORDINATE WITH OTHER TRADES AND CONDUCT THEIR WORK TO PREVENT WORKER EXPOSURE OR SITE CONTAMINATION. REFER TO SPECIFICATION DIVISIONS 0, 1, AND 2 FOR SPECIFIC INFORMATION CONCERNING DISTURBING, REMOVING, AND DISPOSING OF THESE MATERIALS AND THE INSTALLATION OF THE NEW MATERIALS OR COMPONENTS. THIS NOTIFICATION IS PROVIDED IN ACCORDANCE WITH EPA AND OSHA REQUIREMENTS

NOTES:

1. FOR HOUSE KEEPING PAD DETAIL, SEE 1/S505 AND 2/S505.

2. FOR SEISMIC ANCHORAGE OF MECHANICAL EQUIPMENT, SEE SHEET S505. 3. PRIOR TO INSTALLATION OF HKP, REMOVE AND REINSTALL WOOD JOISTS IN

THIS AREA FOR INSERTION OF AHU ON LEVEL 2, BELOW.

4. (N) METAL STUD SHEAR WALL, SW6, (4) SIDES. 600S162-43 @ 16" OC, BRIDGING

AT 48" OC. TOP AND BOTTOM TRACK, 600T125-43.

5. AT STEP IN (N) STUD WALL, ATTACH (N) STUD TO (E) WALL WITH 1/2" SCREWS @

HOLDOWN SCHEDULE						
MARK	SIMPSON HOLDOWN	CHORD SIZE	ANCHOR BOLT			
4	S/HDU4	2-43	5/8" Ø			





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Designed by: Checked by: 21805 AMC Project: 8/8/2022

Project Phase

PERMIT DRAWINGS

Sheet Title THIRD FLOOR PLAN

- STRUCTURAL

Sheet Number **S103**

NORTH

 (E)

(N) PARAPET, (4) SIDES-

 $\left(\mathsf{G}\right)$

19' - 7"

2 S201

11"

13' - 2"

(N) 1200S162-68 @ 24" OC BRIDGING @ 48" OC H

31' - 11"

MOA ePLANS STAMP

NOTIFICATION OF POTENTIAL HAZARDS

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ALASKA COURT SYSTEM SNOWDEN ADMIN BUILDING MECHANICAL UPGRADES

Revisions					
No.	Date	Description			

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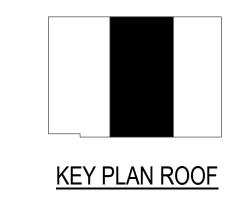
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Checked by:	[
AMC Project:	218
Date:	8/8/20

Project Phase
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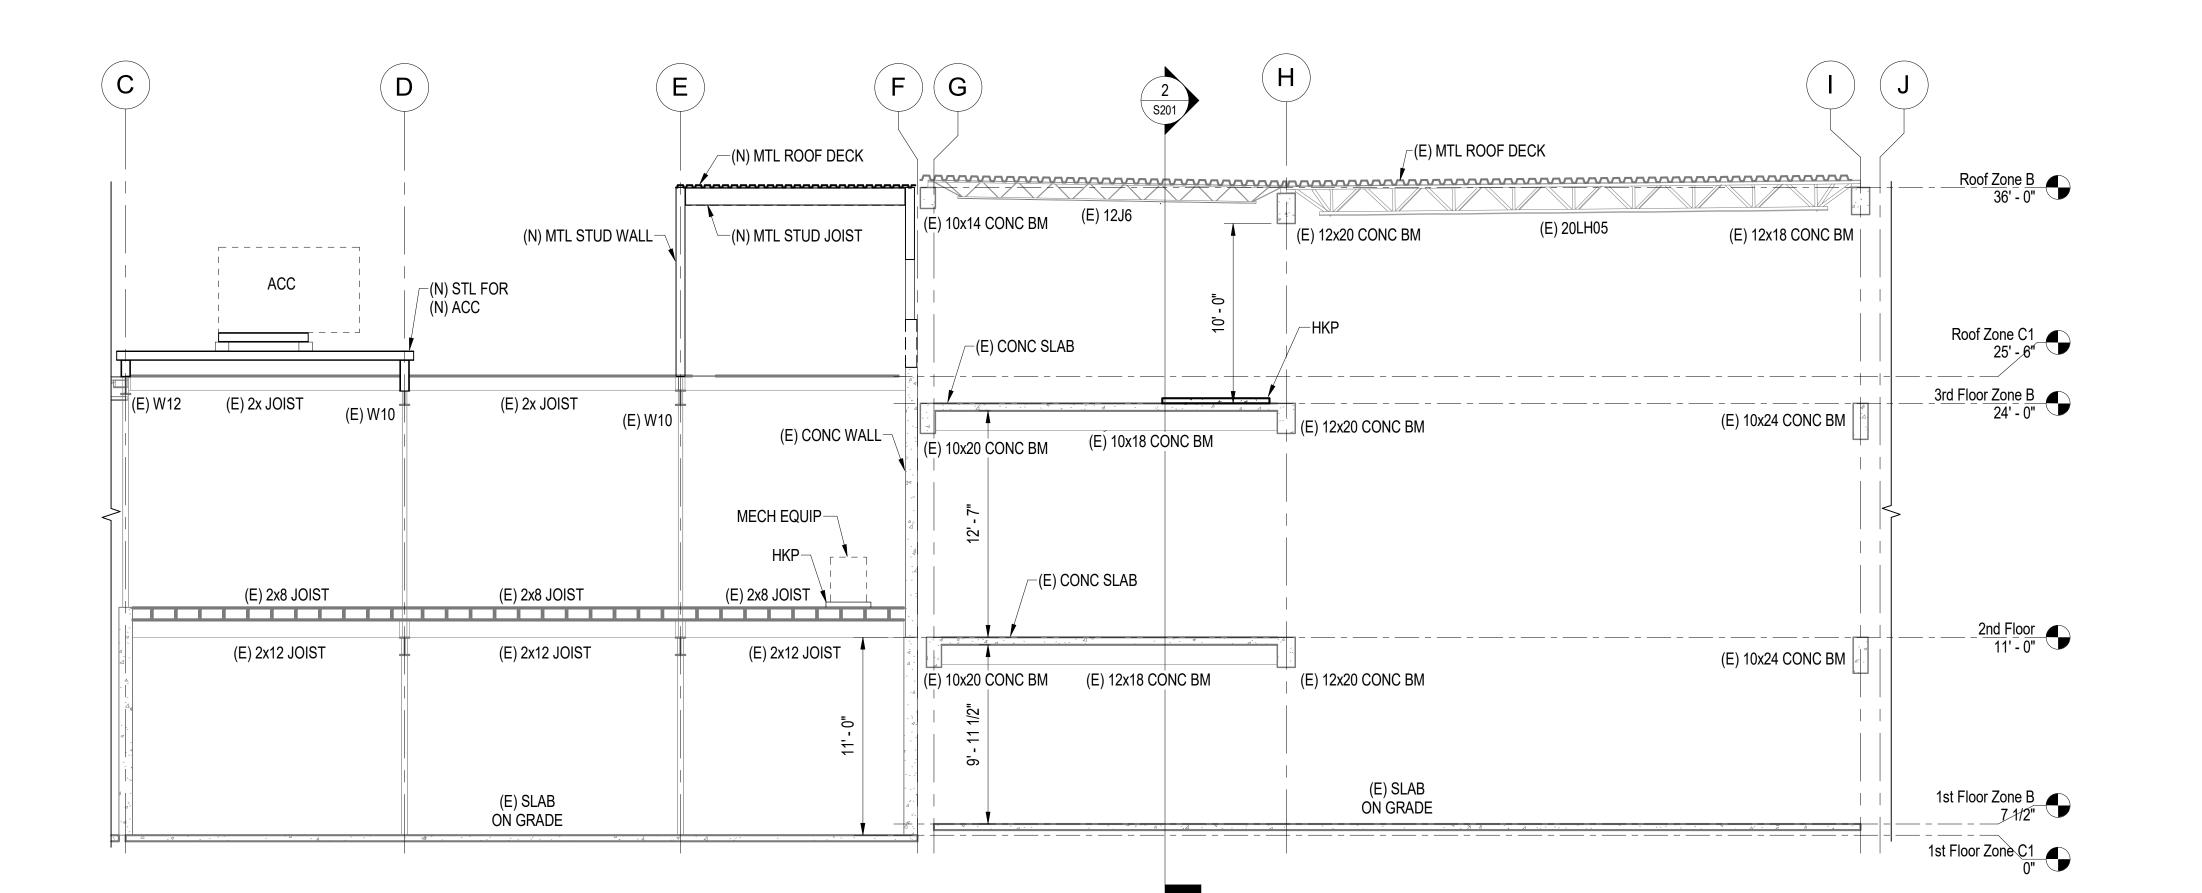
Sheet Title ROOF PLAN -

STRUCTURAL

Sheet Number S104







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NOTIFICATION OF POTENTIAL HAZARDS

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AMC Project: 21805
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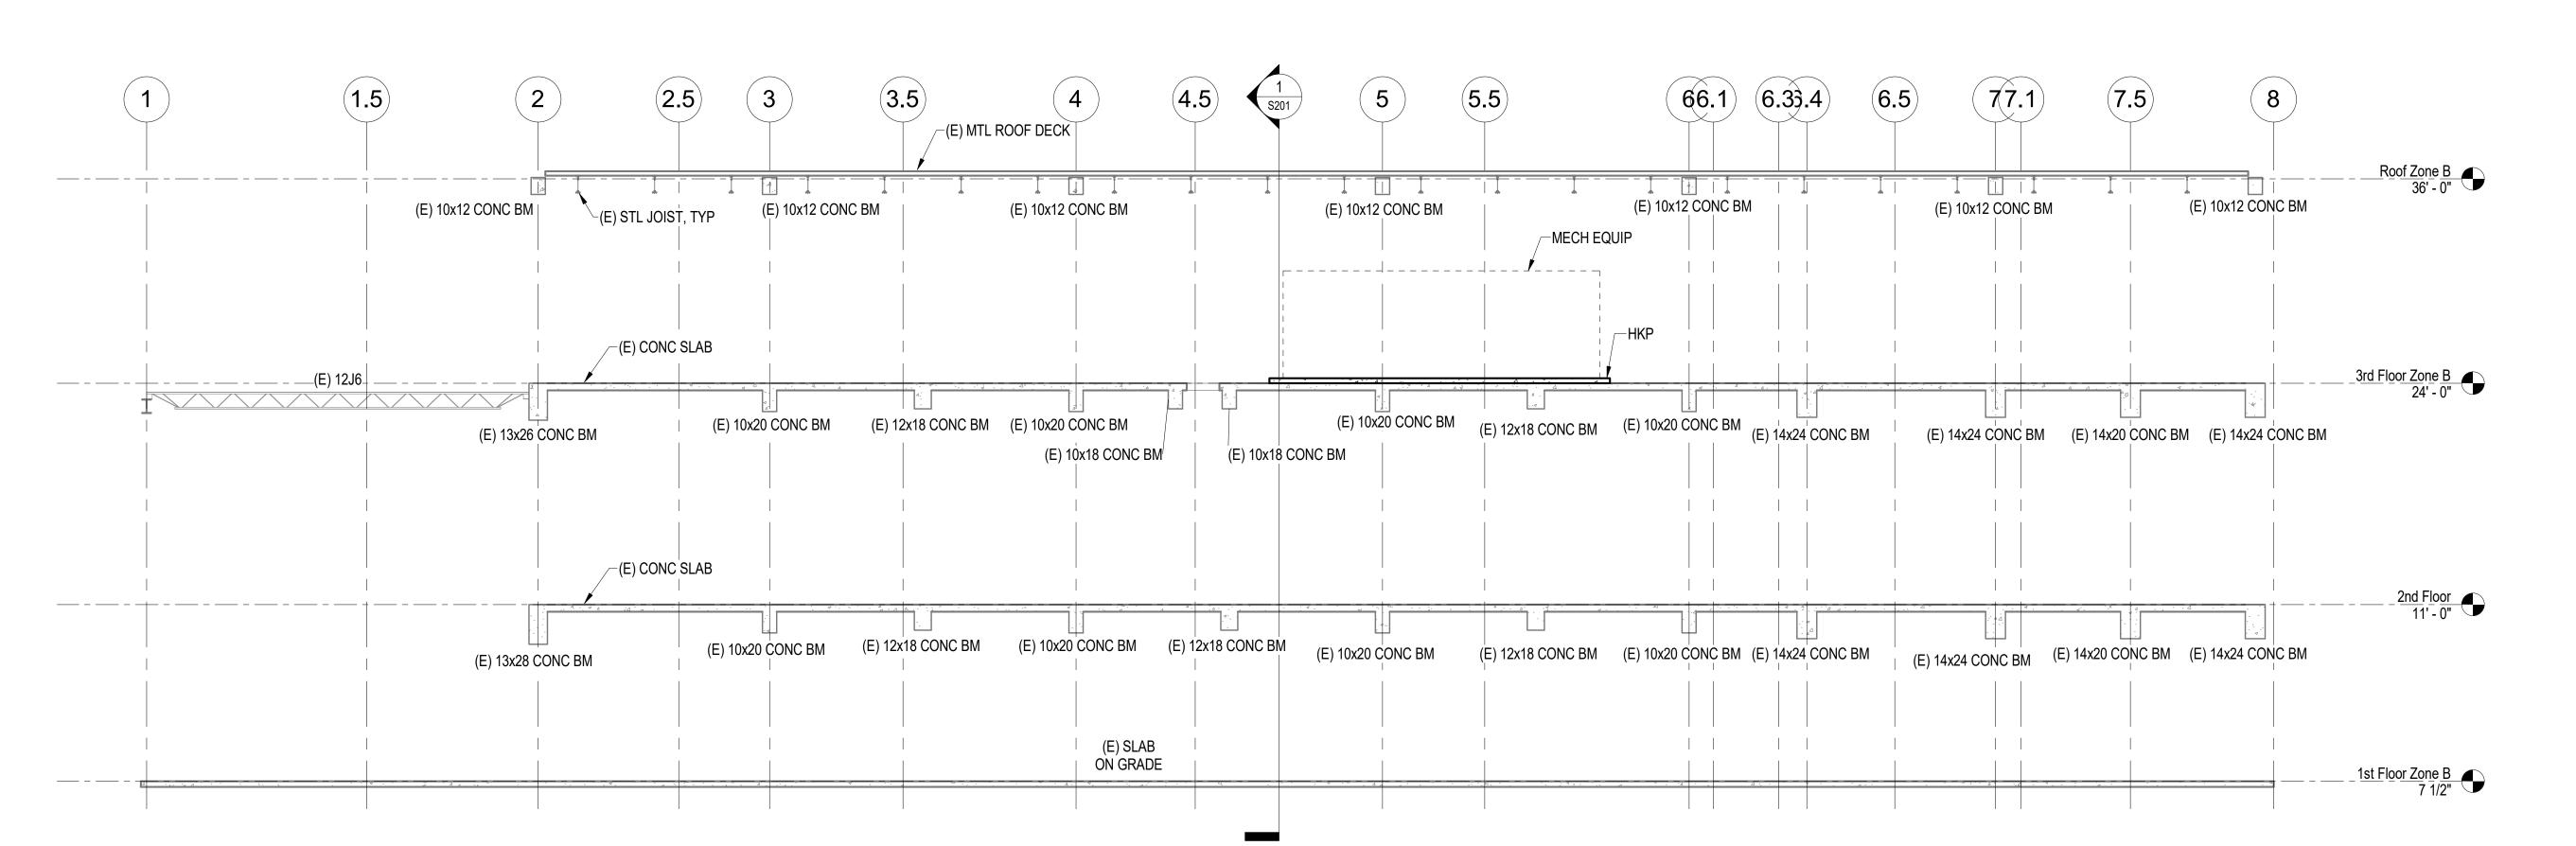
Sheet Title SECTIONS

Sheet Number **S201**

NORTH-SOUTH BUILDING SECTION
3/16" = 1'-0"

EAST-WEST BUILDING SECTION

S201 3/16" = 1'-0"



SECTION A-A



L6x6x3/8 HORIZ LEG-

TURNED INTO CMU -1/2"Øx4 1/2" EMBED ADHESIVE ANCHORS @ 24" OC, IN FULLY GROUTED CELLS REMOVE HORIZ LEG OF ANGLE PAST EDGE OF -EXTEND HORIZ LEG OPENING, TYP INTO WALL TO SUPPORT CMU -(N) OPENING PER ARCH/MECH; @ SIM, (2) (N) OPENINGS EITHER SIDE OF CMU VERTICAL MC6x6.5 JAMB REINF ES OF OPNG

1' - 4"

LEG, TYP L

4'-6" MAX

3 TYP OPENING IN (E) CMU WALL S501

1" MIN ---

THIS IS CONSIDERED TO BE A SINGLE OPENING OF SIZE D1 < 15" SPACING NOTES: 1. IF "A" OR "B" IS GREATER THAN 4xD1, 4xD2 OR 36", THEN THERE IS NO RESTRICTION ON THE OTHER DIMENSION. 2. IF "A" & "B" ARE LESS THAN 4xD1, 4xD2, OR 36", THEN THE OPENING GROUP WILL BE CONSIDERED A SINGLE HOLE, AND MUST BE REINFORCED AS REQUIRED FOR THE LARGER OPENING. JOIST/BEAM BELOW -L2x2x1/4 BELOW MTL DECK EXTEND 24" BEYOND EA SIDE OF OPENING 3" MAX— ─1' - 3" MAX NOTE: 1. FOR OPENINGS LESS THAN L2x2x1/4-4"Ø OR SQ, NO REINF IS **SECTION A-A** REQUIRED.

2 TYP SMALL OPENINGS IN (E) ROOF DECK \S501

1/2" = 1'-0"

1. FULLY GROUT ALL MASONRY CELLS THAT ARE

WALL REINFORCEMENT.

AVOID (E) REINFORCING.

REINFORCEMENT.

REINFORCING IF:

COLUMNS.

-@ SIM, (E) CMU VERTICAL TO REMAIN BETWEEN (2)

OPENINGS

-(N) 1/2" Ø X 3" EMBED

FIELD DRILL TO AVOID (E)

CONCRETE SCREW ANCHOR, TYP, (2) TOTAL

REBAR

—(N) 3/8" X 6" X 0'-8" PL

-(E) CONC BM, TYP /(E) OPNG 3/16 —(E) CONC SLAB -(N) OPNG 10" X 16", (N) C6x13,-SEE NOTE 1 ± 8"

- NOTES:

 1. ATTACH (N) CHANNEL TO (E) SLAB w/ 1/4" Ø X 1 7/8" EMBED CONCRETE SCREWS @ 18" OC, FULL-
- LENGTH OF (N) CHANNEL. SCAN (E) SLAB TO AVOID (E) REBAR.


4 PLAN DETAIL AT (N) OPENINGS ADJACENT TO (E) OPENINGS

MOA ePLANS STAMP

NOTIFICATION OF POTENTIAL HAZARDS

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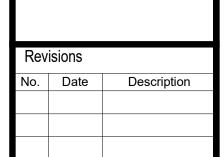



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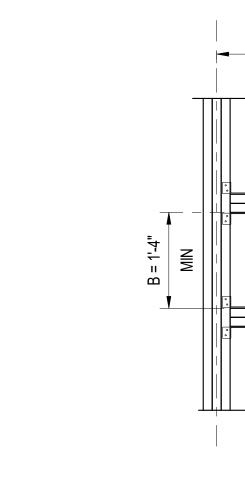
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AMC Project:	2180
Date:	8/8/2022
Project Phase	

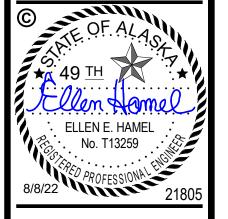
PERMIT DRAWINGS

Sheet Title OPENING DETAILS

Sheet Number

S501

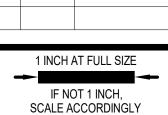

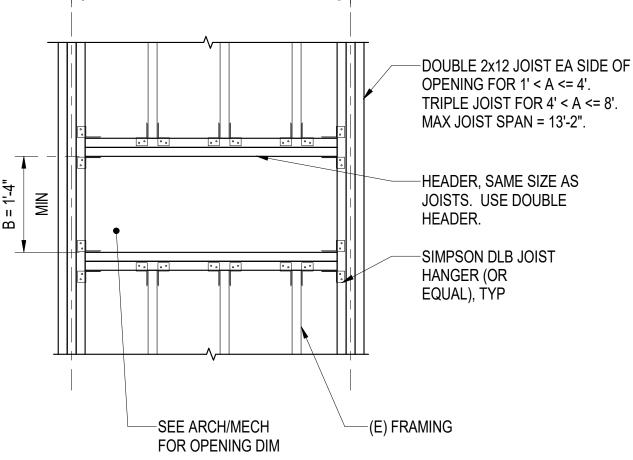

A = 8'-0" MAX

7 TYP FLOOR PENETRATION AT (E) WOOD FRAMING 3/4" = 1'-0"

6 CHANNEL TO CONC CONNECTION \S501

(E) BEAM-

(N) CHANNEL-

TO RECEIVE POST-INSTALLED ANCHORS. 2. ADJUST ANCHOR LOCATIONTO AVOID EXISTING 3. CONTRACTOR TO CONFIRM OPENING DIMENSIONS BEFORE INSTALLING 4. SMALL OPENINGS (< 10" Ø) DO NOT REQUIRE CHANNEL TO (N)/ A. (E) REINFORCEMENT IS AVOIDED. SCAN TO CHANNEL B. (N) OPENINGS ARE SPACED 2'-0" APART FROM (N) AND (E) OPENINGS, BEAMS, AND

2. 6/S501 TYP AT (N) CHANNEL TO (E) CONCRETE BEAM, (3) LOCATIONS. 3. ALL STEEL THIS DETAIL TO BE PAINTED w/ INTUMESCENT PAINT. SEE ARCH.

S501

NORTH

NOTE:

1. ATTACH (N) CHANNEL TO (E) SLAB w/ 1/4" Ø X 1 7/8" EMBED CONCRETE SCREWS @ 18" OC, FULL-LENGTH OF (N) CHANNEL. SCAN (E) SLAB TO AVOID (E) REBAR. 2. 6/S501 TYP AT (N) CHANNEL TO (E) CONCRETE BEAM, (4) LOCATIONS. 3. ALL STEEL THIS DETAIL TO BE PAINTED W/ INTUMESCENT PAINT. SEE ARCH. 5 PLAN DETAIL AT EXPANDED OPENING S501

—(E) CONC SLAB

EXTENTS OF-

(E) OPNG

(6.0)

EXPAND EXISTING-

OPNG TO 1'-4" X 5'-6"

NORTH

-(E) CONC BM, TYP

-(N) C6x13, TYP, (3)

LOCATIONS; NOTE 1


3/16

CHANNEL

CHANNEL

TO (N)

TYP

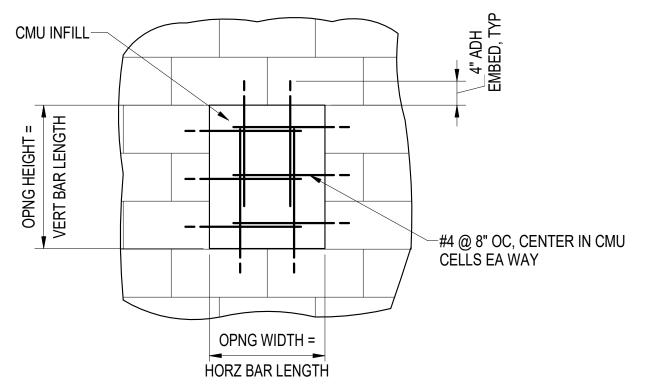


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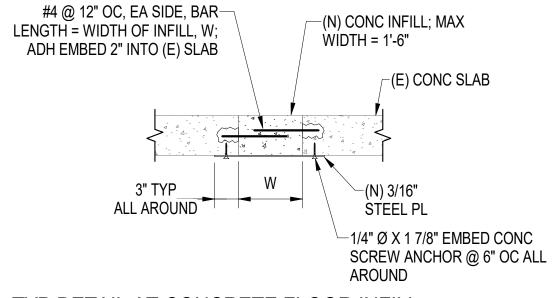
1. MAY USE 3,000 PSI CONCRETE FOR INFILL (IN LIEU OF CMU) IN CONCEALED AREAS.

2. AT PARTIAL GROUTED EXISTING WALL, VERTICAL REINFORCING DOWELS SHALL MATCH THE EXISTING VERT CELL SPACING, NO MORE THAN 24" OC. IF SPACING EXCEEDS 24", GROUT COURSE ABOVE OPENING AS REQUIRED.

3. AT PARTIAL GROUTED EXISTING WALL, HORIZONTAL REINFORCING INTO UNGROUTED CELLS SHALL USE SCREENS RATED FOR

INSERTION INTO UNGROUTED BLOCKS. 4. MAXIMUM OPENING SIZE FOR THIS DETAIL IS 3'-8" WIDTH x 3'-4" HEIGHT.



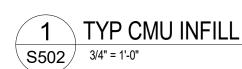

2 TYP DETAIL AT CONCRETE FLOOR INFILL

S502

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Revisions		
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Designed by:	EH
Checked by:	DS
AMC Project:	21805
Date:	8/8/2022

Project Phase PERMIT DRAWINGS

Sheet Title

INFILL DETAILS

Sheet Number

-T200-43 TRACK JAMB PER SCHEDULE BOX HEADER STUD -(6) #10 SCREWS INTO HEADER, EA SIDE -(6) #10 SCREWS INTO JAMB, EA SIDE

-ROOF DECK

ROOF JOIST

-JOIST BLKG @ 24" OC OVER WALL. (3) #8

---#12 SCREW @ 12" OC JOIST TO TOP TRACK

(N) STUD

-T200-43 TRACK

<u>OPENING WIDTH</u> UP TO 6 FT IN 6" WALL JAMB CONFIGURATION DOUBLE 600S162-43

-#10 SCREWS @ 8" OC, TYP HORIZ TRACKS -VERT HEADER STUDS PER SCHEDULE -#10 @ 16" OC

HORIZ TRACKS OPENING WIDTH VERT HEADER STUDS UP TO 6 FT IN 6" WALL 600S162-43 600T125-43

TYP HEADER TO JAMB CONNECTION S503 1 1/2" = 1'-0"

600S162-43 STUD @ 12" OC-

600T200-43 BOTTOM TRACK-

(2) ROWS OF 1/4" SCREWS @

(2) 1/4" SCREWS EA SIDE, -

2" OC TRACK TO DECK

#12 SCREW @ 12" OC-DECK TO JOIST

LOCATE ONE JOIST OVER-

WALL; RIM JOIST @ SIM

1/4" SCREW EA SIDE,-


TRACK TO STUD

(N) WALL-


SHÈÁTHING

TRACK TO STUD

2 TYP HEADER S503 3" = 1'-0"

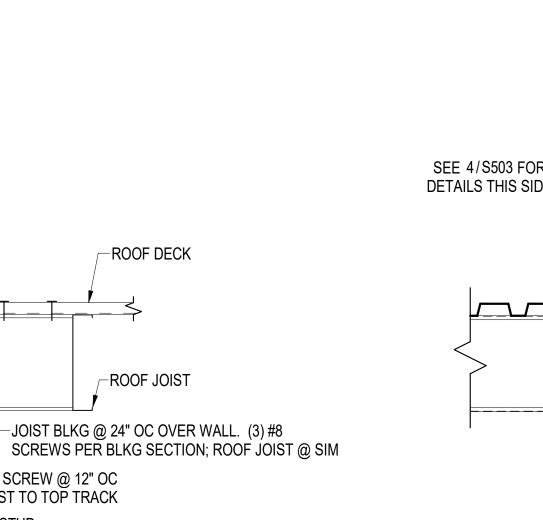

4 SECTION AT ROOF JOIST TO STUD WALL S503 1" = 1'-0"

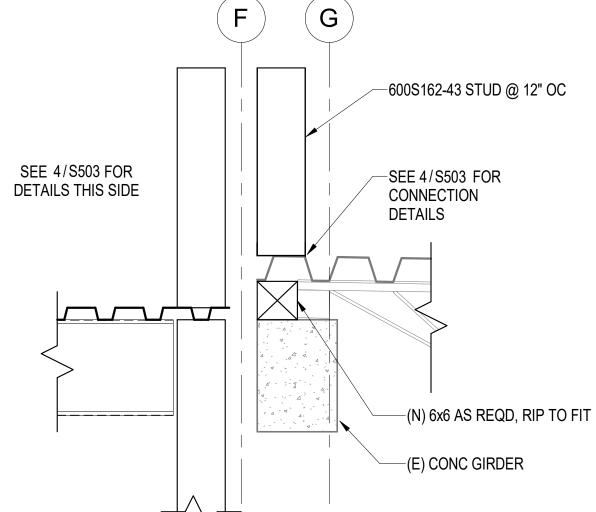


SECTION AT ROOF GRID F/G S503 1" = 1'-0"

MOA ePLANS STAMP


NOTIFICATION OF POTENTIAL HAZARDS

ASBESTOS, LEAD, AND OTHER HAZARDOUS MATERIALS ARE PRESENT IN THE BUILDING AND MAY IMPACT THE WORK OF ALL TRADES. REGULATED AIR CONTAMINANTS, INCLUDING ASBESTOS AND LEAD, ARE ALSO PRESENT IN SETTLED AND CONCEALED DUST IN AND ON ARCHITECTURAL, STRUCTURAL, MECHANICAL, AND ELECTRICAL COMPONENTS OR SYSTEMS THROUGHOUT THE BUILDING. ALL TRADES SHALL COORDINATE WITH OTHER TRADES AND CONDUCT THEIR WORK TO PREVENT WORKER EXPOSURE OR SITE CONTAMINATION. REFER TO SPECIFICATION DIVISIONS 0, 1, AND 2 FOR SPECIFIC INFORMATION CONCERNING DISTURBING, REMOVING, AND DISPOSING OF THESE MATERIALS AND THE INSTALLATION OF THE NEW MATERIALS OR COMPONENTS. THIS NOTIFICATION IS PROVIDED IN ACCORDANCE WITH EPA AND OSHA REQUIREMENTS

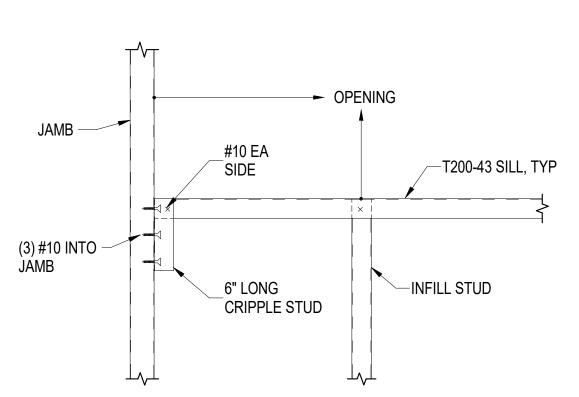

3 TYP SILL TO JAMB CONN S503 1 1/2" = 1'-0"



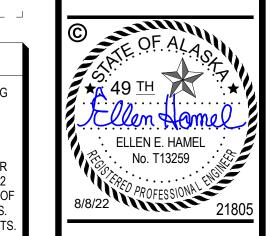

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COURT SYSTEM ADMIN BUILDING CAL UPGRADES AL/ NO/ ME

Revisions		
No.	Date	Description

1 INCH AT FULL SIZE IF NOT 1 INCH,

SCALE ACCORD	INGLY
Designed by:	E
Checked by:	
AMC Project:	2180
Date:	8/8/202

Project Phase PERMIT DRAWINGS


Sheet Title

TYPICAL METAL STUD DETAILS


Sheet Number

SHORT OF SUPPORT

1 SECTION AT (N) SISTERED JOIST S504 1" = 1'-0"

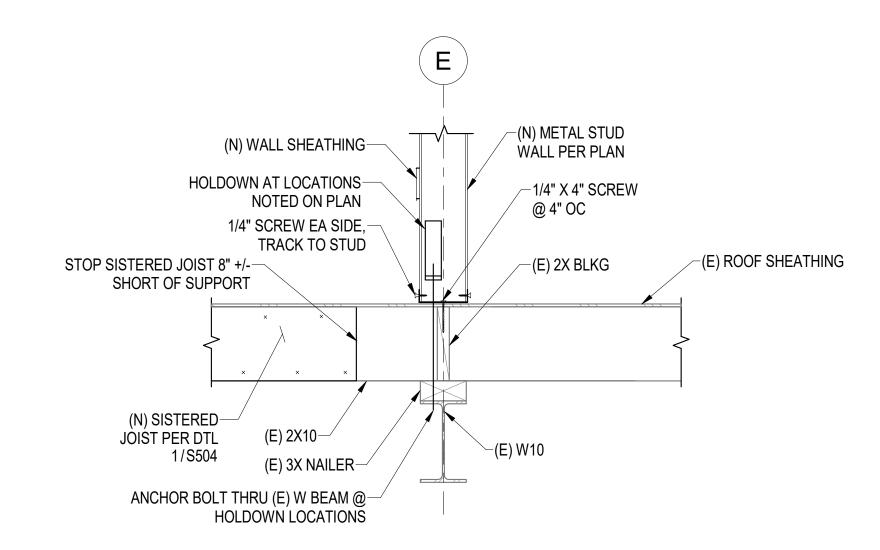


3 SECTION AT (N) WALL PERP TO (E) JOIST S504 1" = 1'-0"

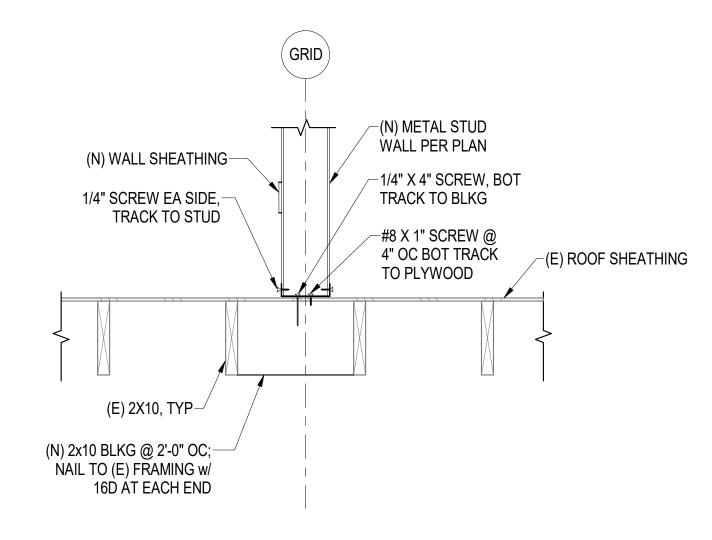

4 SECTION AT (N) WALL PARALLEL TO (E) JOIST

NOTIFICATION OF POTENTIAL HAZARDS

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5 SECTION AT (N) WALL TO (E) CMU WALL 1" = 1'-0"

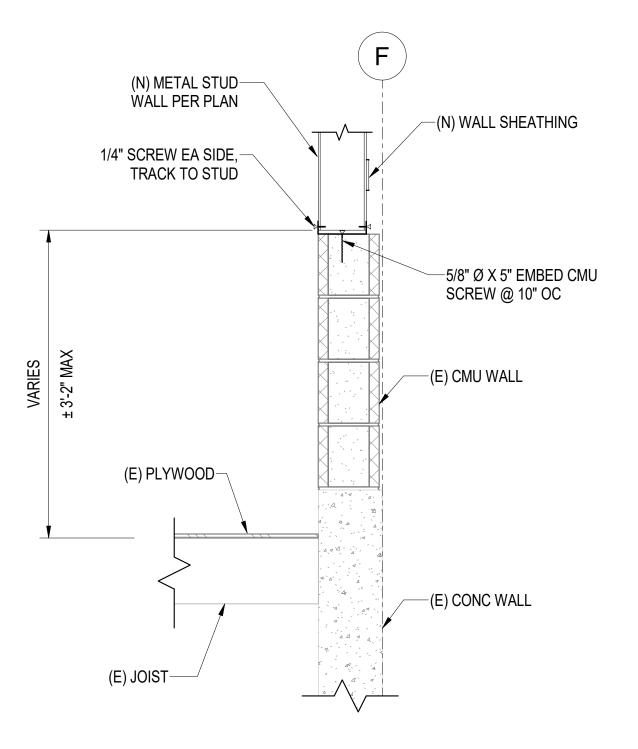



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ALASKA COURT SYSTEM SNOWDEN ADMIN BUILDING MECHANICAL UPGRADES

Rev	isions	
No.	Date	Description

1 INCH AT FULL SIZE

IF NOT 1 INCH,
SCALE ACCORDINGLY


Designed by: EH
Checked by: DS
AMC Project: 21805
Date: 8/8/2022

Project Phase
PERMIT DRAWINGS


Sheet Title FRAMING SECTIONS

Sheet Number

TYP HOUSEKEEPING PAD S505 3/4" = 1'-0"

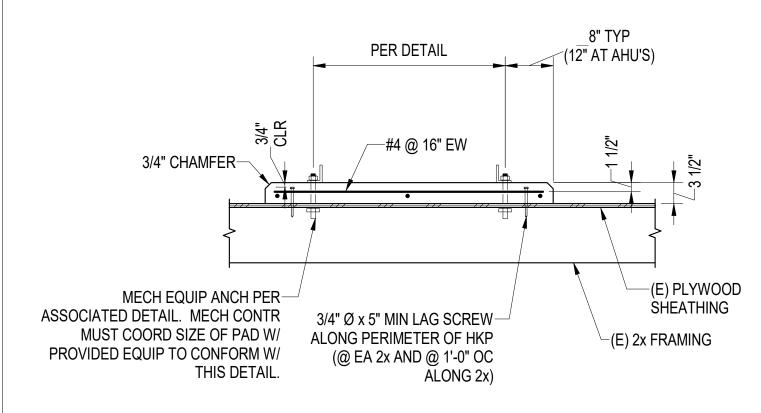

HOUSEKEEPING PAD ON (E) WOOD FRAMING S505 3/4" = 1'-0"

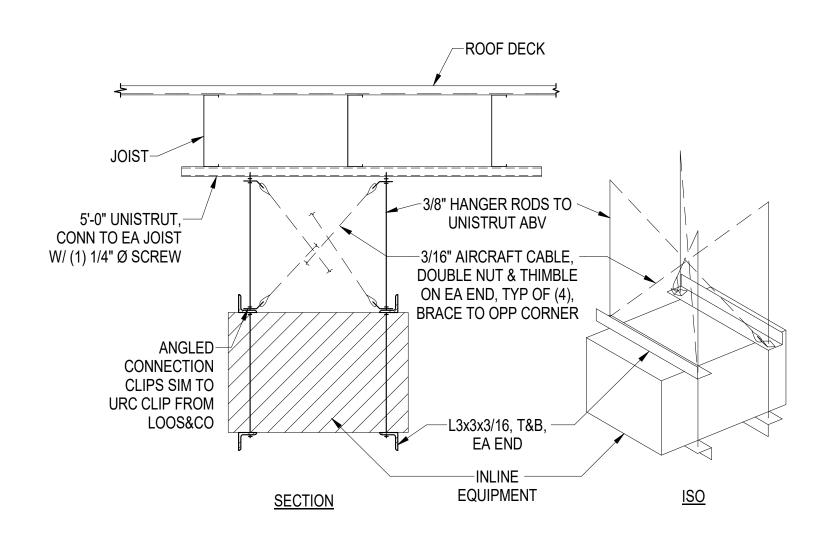


UNIT ID	MAX WEIGHT (LBS)
EF-1	140
RF-2	200

1. ANCHORAGE OF EQUIPMENT IS BASED ON THE MECHANICAL UNIT SELECTIONS SHOWN ON M002. IF UNITS OTHER THAN THOSE LISTED ARE SUBSTITUTED, CONTRACTOR SHALL PROVIDE DEFERRED SUBMITTAL FOR ANCHORAGE OF EQUIPMENT.

2. SEE 6/S505 FOR SMALL CABINET FAN.

5 SUSPENDED INLINE EQUIPMENT S505 3/4" = 1'-0"

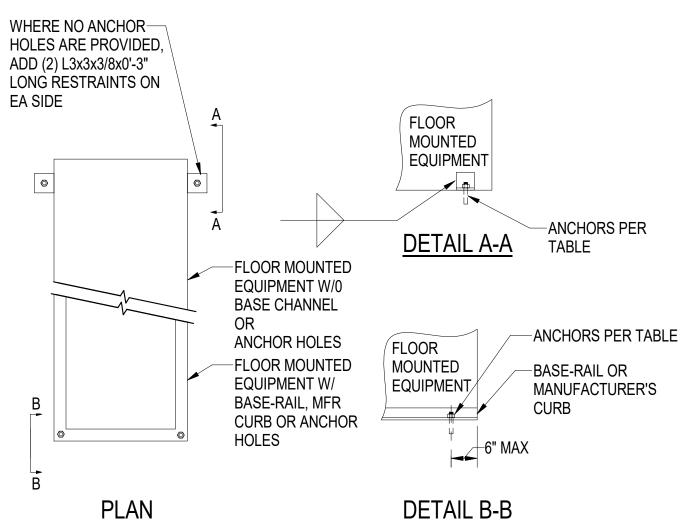


<u>-</u>				
UNIT ID	MAX WEIGHT (LBS)	NUMBER & SIZE OF ANCHORS	TYPE OF ANCHORS	HKP DETAIL
AHU-1	3,500	(8) 3/8"Ø	THRU BOLT	2/S505
AHU-2	4,000	(8) 3/8"Ø	THRU BOLT	2/S505
AHU-3	5,500	(8) 1/2"Ø X 3" EMB	ADH ANCHOR	1/S505
AHU-4	4,500	(8) 1/2"Ø X 3" EMB	ADH ANCHOR	1/S505
BLR-1	1,900	(4) 1/2"Ø X 3" EMB	ADH ANCHOR	1/S505

1. ANCHORAGE OF EQUIPMENT IS BASED ON THE MECHANICAL UNIT SELECTIONS SHOWN ON M002. IF UNITS OTHER THAN THOSE LISTED ARE SUBSTITUTED, CONTRACTOR SHALL PROVIDE DEFERRED SUBMITTAL FOR ANCHORAGE OF EQUIPMENT





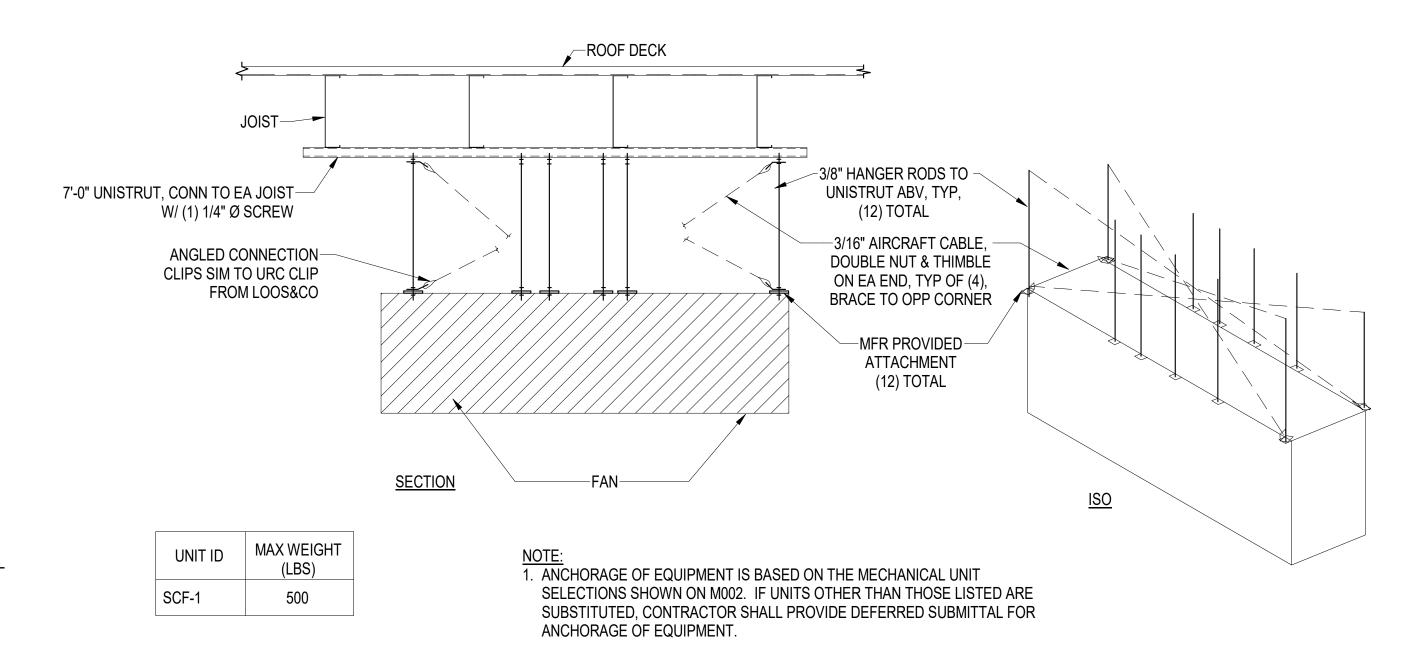

SMALL CABINET FAN S505 3/4" = 1'-0"

MOA ePLANS STAMP

NOTIFICATION OF POTENTIAL HAZARDS


ASBESTOS, LEAD, AND OTHER HAZARDOUS MATERIALS ARE PRESENT IN THE BUILDING AND MAY IMPACT THE WORK OF ALL TRADES. REGULATED AIR CONTAMINANTS, INCLUDING ASBESTOS AND LEAD, ARE ALSO PRESENT IN SETTLED AND CONCEALED DUST IN AND ON ARCHITECTURAL, STRUCTURAL, MECHANICAL, AND ELECTRICAL COMPONENTS OR SYSTEMS THROUGHOUT THE BUILDING. ALL TRADES SHALL COORDINATE WITH OTHER TRADES AND CONDUCT THEIR WORK TO PREVENT WORKER EXPOSURE OR SITE CONTAMINATION. REFER TO SPECIFICATION DIVISIONS 0, 1, AND 2 FOR SPECIFIC INFORMATION CONCERNING DISTURBING, REMOVING, AND DISPOSING O THESE MATERIALS AND THE INSTALLATION OF THE NEW MATERIALS OR COMPONENTS. THIS NOTIFICATION IS PROVIDED IN ACCORDANCE WITH EPA AND OSHA REQUIREMENTS

-CONC HKP -TANK MAX WEIGHT (LBS) UNIT ID 1/8" ANGLE CLIP, 2"x2"x2", TYP ET-1 800 WH-1 450 -(3) 3/8"Ø X 3" EMBED ADH ANCHORS

1. ANCHORAGE OF EQUIPMENT IS BASED ON THE MECHANICAL UNIT SELECTIONS SHOWN ON M002. IF UNITS OTHER THAN THOSE LISTED ARE SUBSTITUTED, CONTRACTOR SHALL PROVIDE DEFERRED SUBMITTAL FOR ANCHORAGE OF EQUIPMENT.


2. SEE 1/S505 FOR HOUSEKEEPING PAD DETAIL

TANK - BASE MOUNT

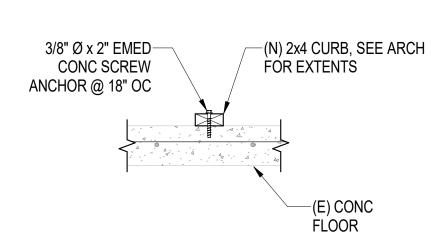

TYP MECH EQUIPMENT CURB S505 1" = 1'-0"

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YSTEM SUILDING RADES Ζġ AL/ NO/ ME
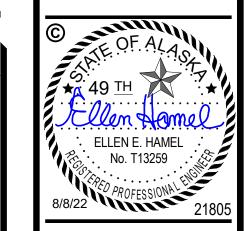
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Designed by: Checked by: 21805 AMC Project: 8/8/2022 Date: Project Phase

PERMIT DRAWINGS

Sheet Title

MECHANICAL ANCHORAGE **DETAILS**

Sheet Number

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NOTIFICATION OF POTENTIAL HAZARDS

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ELLEN E. HAMEL

No. T13259

8/8/22 PROFESSIONA 21805

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YSTEM SUILDING SRADES

SOURT SY ADMIN BU SAL UPGF AL/ SNO

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-(4) 3/4" Ø BOLTS

1 INCH AT FULL SIZE

IF NOT 1 INCH, SCALE ACCORDINGLY Designed by: Checked by: 21805 AMC Project:

8/8/2022 Project Phase **PERMIT DRAWINGS**

Sheet Title ACC SUPPORT

Sheet Number

DETAILS

S506


NOTES:

1. ISOLATOR TOP PLATES NOT SHOWN ON PLAN.

2. (E) EAST/WEST ROOF FRAMING NOT SHOWN. 3. (E) ROOF SHEATHING NOT SHOWN.


4. ACC BASIS OF DESIGN IS AAON MODEL # CFA-013-B-A-8-DAOOK. IF ACTUAL UNIT VARIES FROM THIS, ENGINEER SHALL BE NOTIFIED

PLAN AT NEW ACC SUPPORTS S506 3/4" = 1'-0"

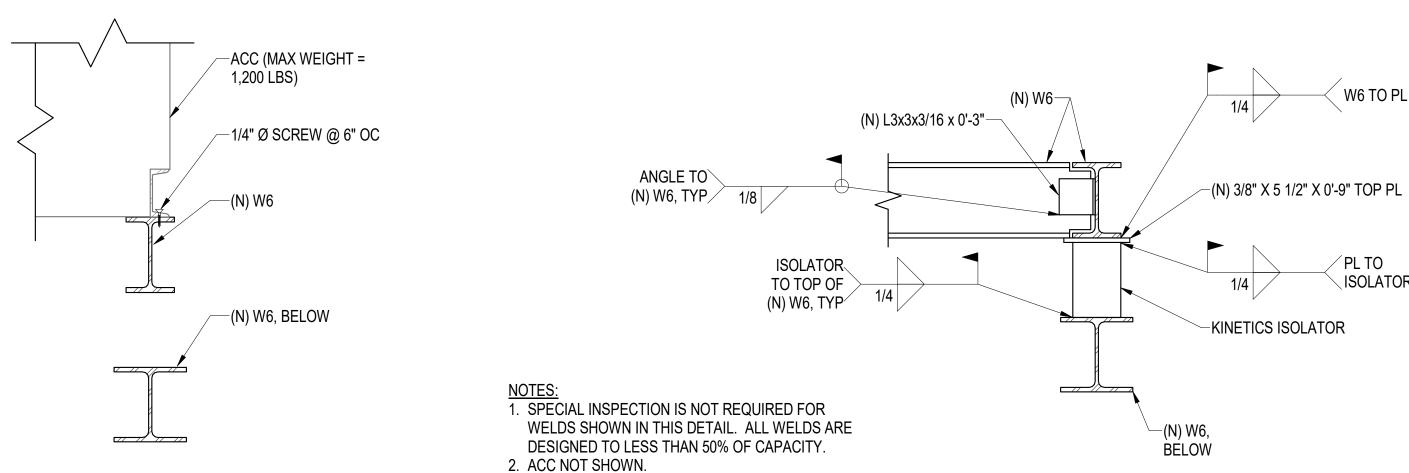

2 SECTION AT NEW ACC S506 1 1/2" = 1'-0"

SECTION AT FRAME/ISOLATOR CONNECTION S506 1 1/2" = 1'-0"

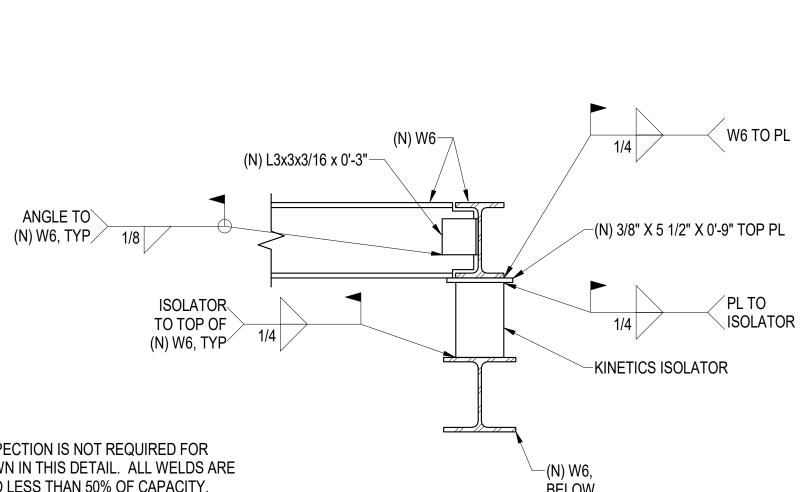

(N) PL 3/8" X 8" X 1'-0" ['] 1 1/2" / PIPE TO TYP (N) PIPE-© SII (E) FRAMING, BEYOND (N) 1/2" NITRILE BRG--(N) PL 3/8" X 8" X 1'-0" PAD BTWN PLATES −(N) BOLT, TYP (N) 1/4" STIFF PL, TYP, – EA SIDE OF WEB; WELD

(GRID)


√(E) W10, (E) W12 @ SIM 1" Ø ACCESS HOLE 1 1/2"_ TYP SECTION A-A 3 SIDES w/ 3/16" FILLET

-(N) 3/4" Ø BOLT, TYP, (4) TOTAL AT BEAM TYP GAGE

(E) W10, (E) W12 @ SIM;—

FLANGE WIDTH < 6" (VIF)

(N) 1/4" STIFF PL, TYP,— EÀ SIDE OF WEB; WELD 3 SIDES w/ 3/16" FILLET

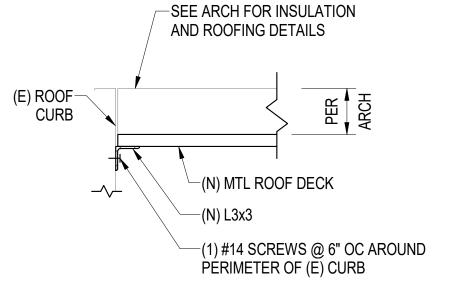

1 PLAN AT ABANDONED ROOF CURB S507

3/4" = 1'-0"

2 SECTION AT (N) JOIST TO CURB S507 1" = 1'-0"

MOA ePLANS STAMP

NOTIFICATION OF POTENTIAL HAZARDS

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COURT SYSTEM ADMIN BUILDING CAL UPGRADES ASKA CC WDEN A AL/ SNO

Revi	isions	
No.	Date	Description

1 INCH AT FULL SIZE IF NOT 1 INCH,

SCALE ACCOR	RDINGLY
Designed by:	E
Checked by:	
AMC Project:	2180
Date:	8/8/202

PERMIT DRAWINGS

Sheet Title

ABANDONED ROOF CURB DETAILS

Sheet Number

FΕ

FEC

FO

FOC

FOF

FOS

FURR

FT

GΑ

GALV

GWB

GYP

HM

HR

INSTALLED

OVERHEAD

PLYWOOD

REFERENCE

REQUIRED

SECTION

SIMILAR

SCHEDULE

STANDARD

STRUCTURAL

TOP OF BEAM

TOP OF STEEL

UNFINISHED

VERIFY IN FIELD

TYPICAL

WOOD

STEEL

PRESSURE TREATED LAMINATE

REFLECTED CEILING PLAN

REINFORCING BARS

ROUGH OPENING

SPECIFICATION

STAINLESS STEEL

TO BE DETERMINED

TOP OF CONCRETE

UNDERWRITERS LABORATORY

UNLESS NOTED OTHERWISE


CONC CONT CONTINUOUS OFOI CTR CENTER DIA DIAMETER DIM DIMENSION PLAM DWG DRAWING PLY EΑ EACH **ELEVATION** RCP ELEC **ELECTRICAL** REBAR EQUAL, EQUIPMENT REF EQ ETR **EXISTING TO REMAIN** REQD EX **EXISTING** R.O. FAC FACTORY SECT


FLUID APPLIED FLOORING SCHED FIRE EXTINGUISHER SPEC FIRE EXTINGUISHER CABINET FINISHED FLOOR FACE OF STD FACE OF CONCRETE STL FACE OF FINISH STRUCT FACE OF STUD TBD FOOT, FEET TOB **FURRING** TOC TOS GAUGE GALVANIZED TYP GYPSUM WALL BOARD UNFIN GYPSUM WALL BOARD UNO **HOLLOW METAL** HOUR HEIGHT WD

SYMBOLS




ROOM IDENTIFICATION Room name ROOM NAME 101 ROOM NUMBER AREA 150 SF

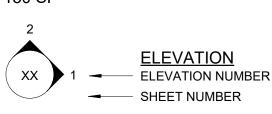

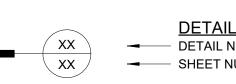

 DETAIL NUMBER → SHEET NUMBER **DOOR NUMBER**


REFER TO DOOR

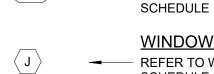

WINDOW TYPE REFER TO WINDOW SCHEDULE

<u>KEYNOTE</u>

REFER TO NOTES

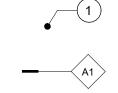

LISTED ON SHEET PARTITION TYPE INDICATOR REFER TO PARTITION ASSEMBLIES



GENERAL FINISH TYPE TAG REFER TO FINISH LEGEND

MATERIALS

CONCRETE (SECTION) GYPSUM SHEATHING (PLAN & SECTION) GYPSUM WALL BOARD (PLAN & SECTION) INSULATION, BATT (PLAN & SECTION) INSULATION, SEMI RIGID (PLAN & SECTION) INSULATION, RIGID, ROOF (PLAN & SECTION) INSULATION, SPRAY FOAM (PLAN & SECTION)

METAL (SECTION)

PLYWOOD, SHEATHING (SECTION) PLYWOOD (SECTION) WOOD, CONTINUOUS (SECTION)

WOOD, BLOCKING (SECTION)

GENERAL NOTES

- CONSTRUCTION SHALL BE IN COMPLIANCE WITH ALL APPLICABLE CODES AND REGULATIONS.
- CONTRACTOR TO VERIFY ALL EXISTING CONDITIONS PRIOR TO COMMENCEMENT OF WORK AND NOTIFY ARCHITECT OF ANY DISCREPANCIES WITH AS-BUILT CONDITIONS AS SHOWN IN THE DOCUMENTS.
- DIMENSIONS TO NEW PARTITIONS ARE FACE OF STUD AND FACE OF FINISH TO EXISTING PARTITIONS. "CLR" REFERS TO FACE OF FINISH EACH SIDE UNLESS NOTED
- WORK AREAS WILL BE LEFT CLEAN AND FREE OF ANY DEBRIS OR DUST AT THE END OF EACH SHIFT.
- ALL TOOLS, CONSTRUCTION MATERIALS, AND EQUIPMENT ARE TO BE PROPERLY STORED AT THE END OF EACH SHIFT. CONTRACTOR IS SOLELY RESPONSIBLE FOR THE SECURITY OF ALL SUCH ITEMS.
- THE CONTRACTOR SHALL CREATE A CLEAN, DRY SPACE TO STORE MATERIALS ON SITE TO ALLOW ACCLIMATION AS RECOMMENDED BY EACH MANUFACTURER.
- THE CONTRACTOR SHALL PROVIDE REFUSE SERVICES. A LOCATION NEAR THE BUILDING WILL BE DESIGNATED FOR THE DUMPSTER. DELIVERIES AND STORAGE REQUIREMENTS ARE TO BE COODINATED WITH OWNER'S FACILITIES PERSONNEL.
- PROTECT EXISTING-TO-REMAIN CONSTRUCTION FROM DAMAGE AT ALL TIMES DURING WORK.
- ALL ITEMS NOT IDENTIFIED FOR SALVAGE THAT ARE REMOVED AND IN GOOD CONDITION ARE TO BE PROTECTED AND DONATED - SEE SPEC. OWNER MAINTAINS FIRST RIGHT OF REFUSAL FOR ALL SUCH

MOA ePlan Stamp

NOTIFICATION OF POTENTIAL HAZARDS

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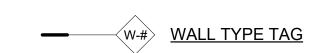



ARCHITECTURE DESIGN STRATEGY 3909 ARCTIC BLVD., STE 100 ANCHORAGE, AK 99503 907.561.5543

> G YSTEM UILDING RADES SBB M CH 1 AL NO ME

EXTERIOR WALL ASSEMBLIES

- REFER TO CONSTRUCTION PLAN, EXTERIOR ELEVATIONS, AND SPECIFICATIONS FOR ADDITIONAL INFORMATION, INCLUDING FINISHES.
- MATERIALS ARE LISTED FROM EXTERIOR TO INTERIOR SIDE OF ASSEMBLY. NEW OR ALTERED WALLS AND/OR PARTITIONS NOT TAGGED IN PLAN HAVE NON-TYPICAL ASSEMBLIES. SEE ASSOCIATED DETAILS FOR ADDITIONAL



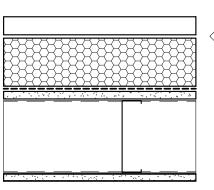

ASSEMBLY INFORMATION.




NEW (N) EXTERIOR WALL (PLAN VIEW)

- METAL PANEL WALL SYSTEM
- 1/2" AIR SPACE (STAND OFF CLIPS) 4" FIBERGLASS Z-FURRING (VERTICAL) W/
- 4" SEMI-RIGID ROCKWOOL INSULATION
- GLASS-MAT SHEATHING
- METAL SHEATHING AND FRAMING PER STRUCTURAL
- 5/8" TYPE X GWB (TYP), UNO

ROOF ASSEMBLIES


- REFER TO ROOF PLAN AND EXTERIOR ELEVATIONS FOR ADDITIONAL INFORMATION.
- MATERIALS ARE LISTED FROM EXTERIOR TO INTERIOR SIDE OF ASSEMBLY.

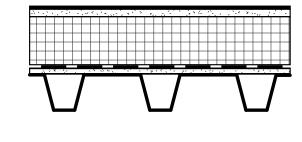



NEW ROOF - EPDM (SECTION VIEW)

- EPDM MEMBRANE GLASS-MAT COVER BOARD
- RIGID INSULATION (TAPERED, 6" MIN.) UNDERLAYMENT
- GLASS-MAT THERMAL BARRIER METAL DECKING - SEE STRUCT.

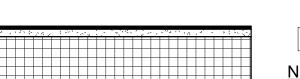



NEW ROOF ON EXISTING DECK - EPDM

- (SECTION VIEW)
- (N) EPDM MEMBRANE
- (N) GLASS-MAT COVER BOARD
- (N) RIGID INSULATION (TAPERED)
- (N) UNDERLAYMENT (E) THERMAL BARRIER
- (E) ROOF DECK

NOTE: WHERE TAPER KIT WILL NOT DISRUPT (E) VAPOR RETARDER, LEAVE AS IS AND TIE INTO (N) UNDERLAYMENT WHERE REQUIRED, PER MANF.

No. Date Description

> 1 INCH AT FULL SIZE IF NOT 1 INCH. SCALE ACCORDINGLY

Designed by: BAM Checked by: 21805 AMC Project: 08/08/2022 Date:

> **PERMIT DRAWINGS** Sheet Title GENERAL INFO,

Project Phase

ASSEMBLIES, **DETAILS**

Sheet Number A001

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CoA No. C0342 - 907.257.9100

JUSTIN M. SCANIO
No. A-140412
08.08.2022

701 E. Tudor Rd. Suite 250 Anchorage, AK 99503

21805

ARCHITECTURE DESIGN STRATEGY

3909 ARCTIC BLVD., STE 100 ANCHORAGE, AK 99503 907.561.5543

> ALASKA COURT SYSTEM SNOWDEN ADMIN BUILDING MECHANICAL UPGRADES

Revisions

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IF NOT 1 INCH,

Designed by: MC

Checked by: BAI

AMC Project: 2180

Date: 08/08/2022
Project Phase

Project Phase
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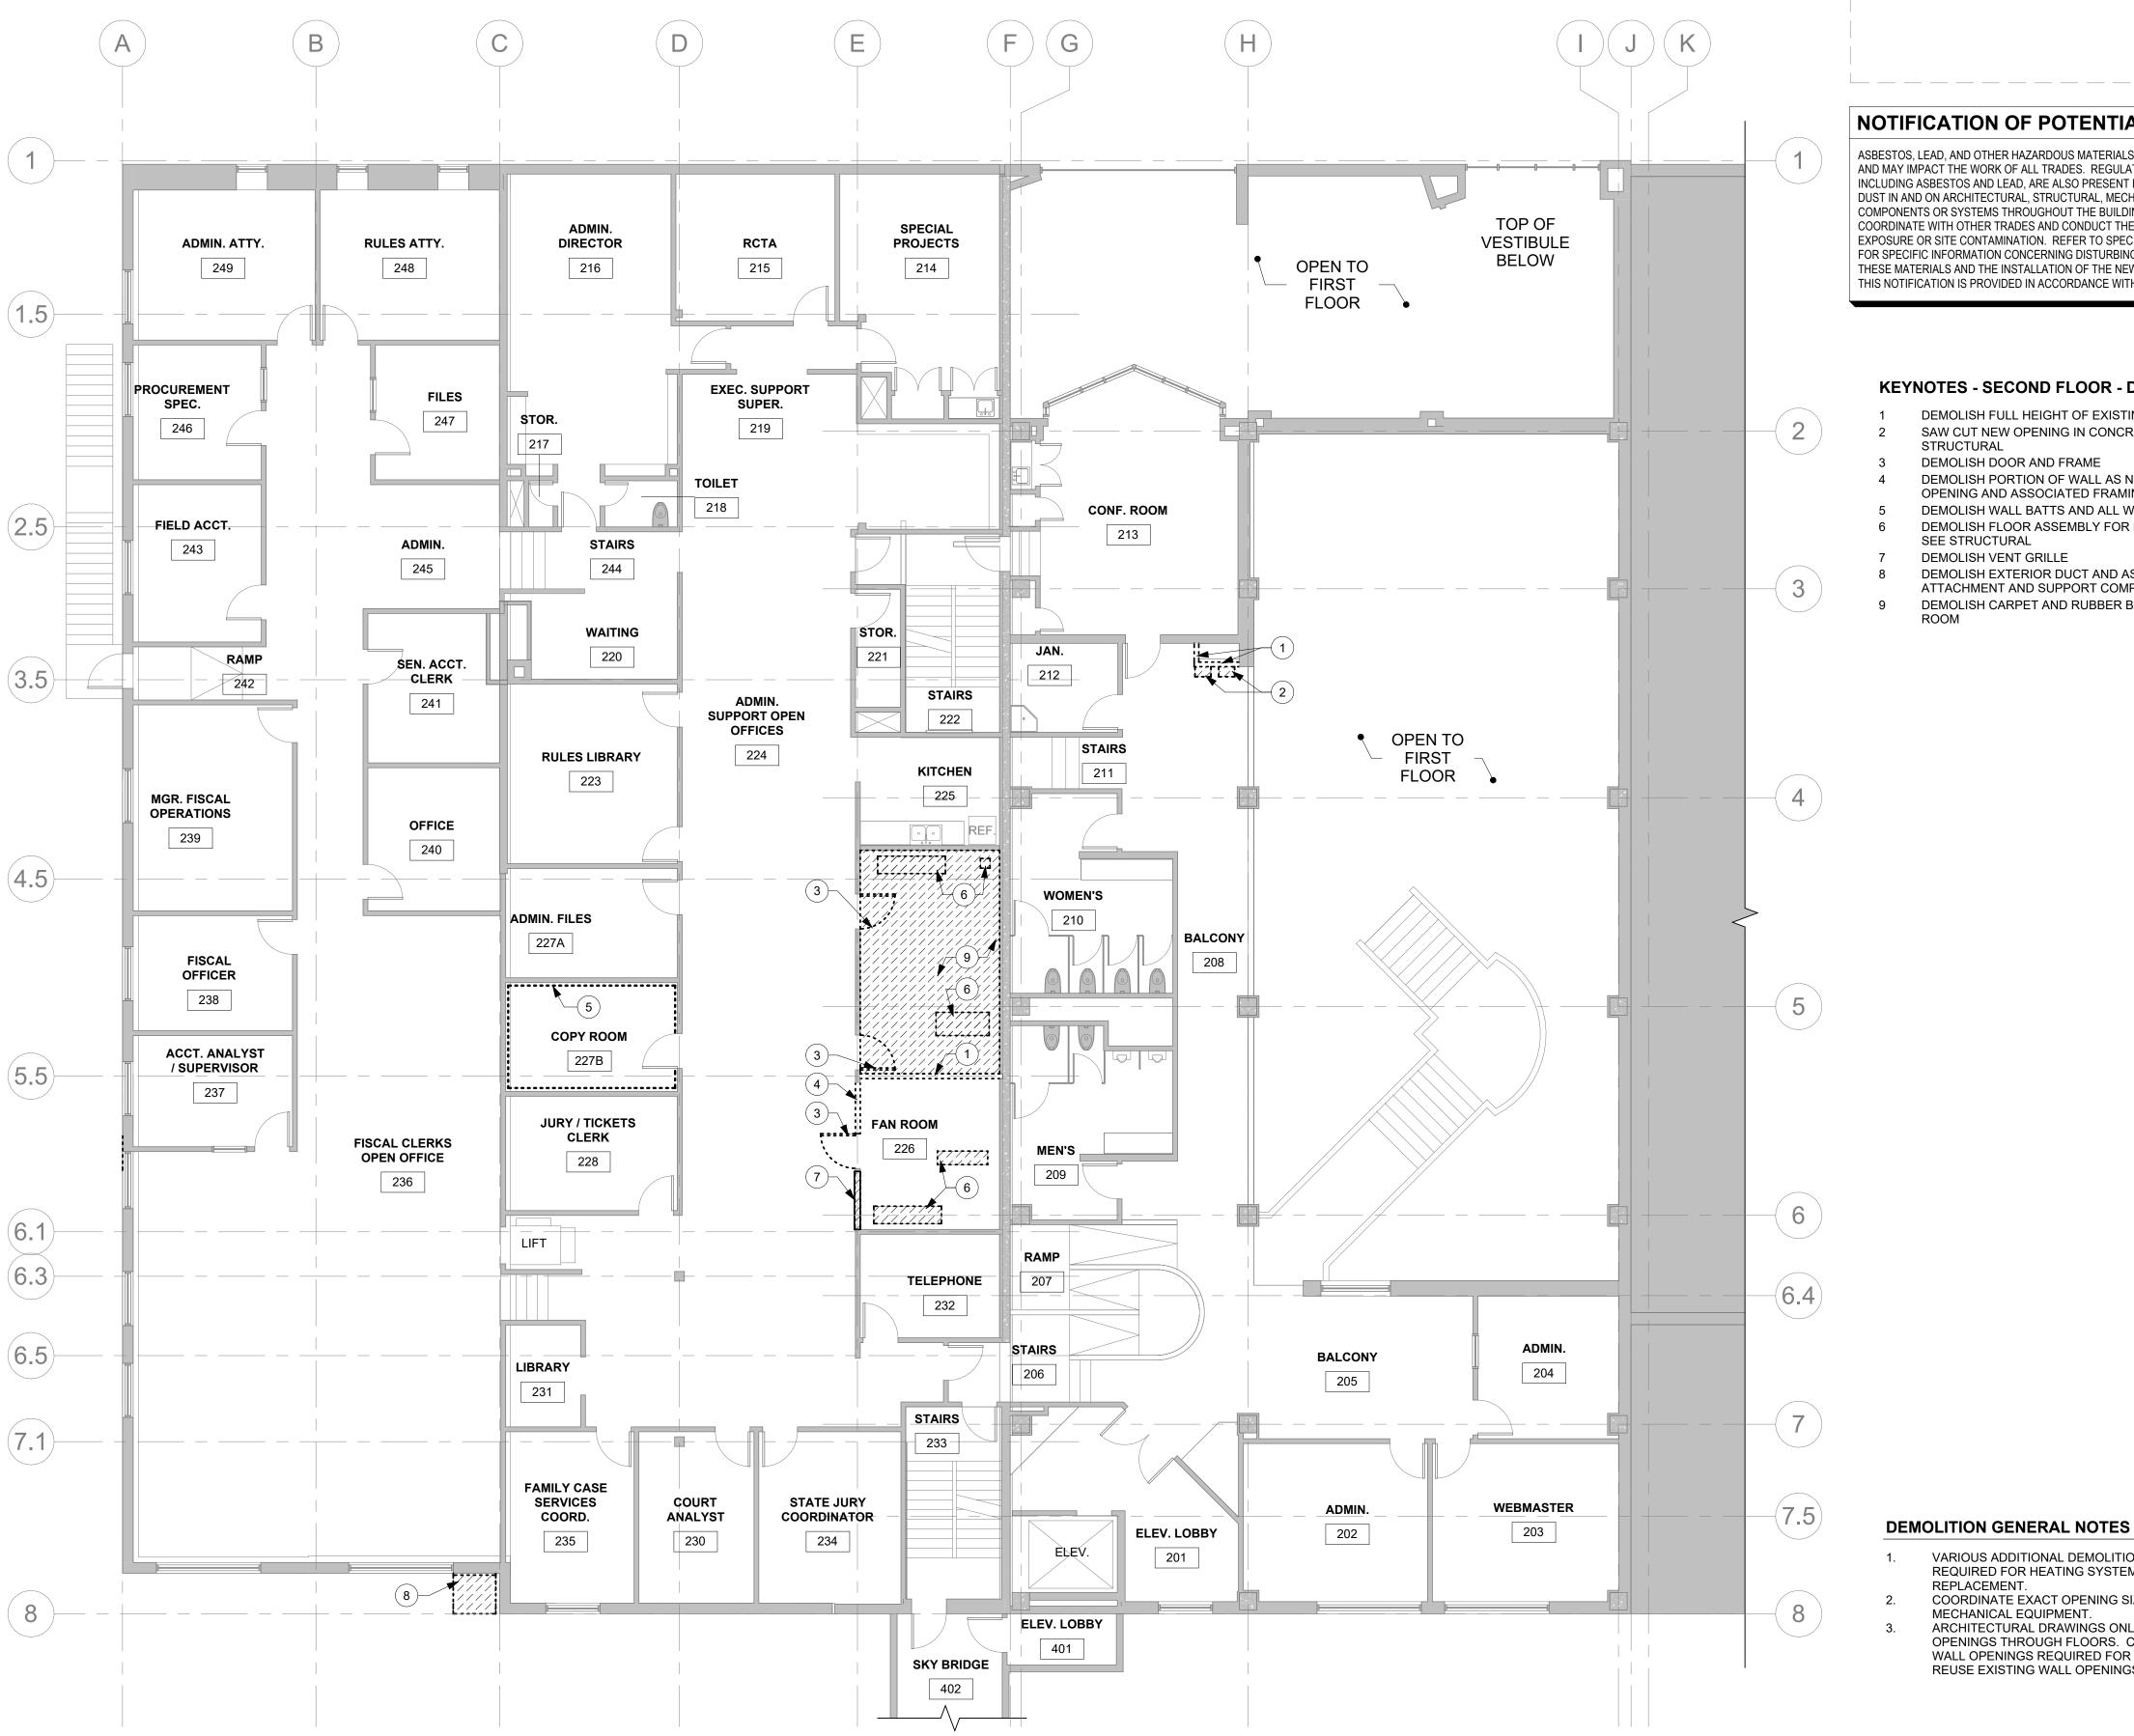
Sheet Title FIRST FLOOR PLAN -

DEMOLITION

Sheet Number

EXISTING TO BE DEMOLISHED

1 SECOND FLOOR PLAN - DEMOLITION 1/8" = 1'-0"



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NOTIFICATION OF POTENTIAL HAZARDS

ASBESTOS, LEAD, AND OTHER HAZARDOUS MATERIALS ARE PRESENT IN THE BUILDING AND MAY IMPACT THE WORK OF ALL TRADES. REGULATED AIR CONTAMINANTS, INCLUDING ASBESTOS AND LEAD, ARE ALSO PRESENT IN SETTLED AND CONCEALED DUST IN AND ON ARCHITECTURAL, STRUCTURAL, MECHANICAL, AND ELECTRICAL COMPONENTS OR SYSTEMS THROUGHOUT THE BUILDING. ALL TRADES SHALL COORDINATE WITH OTHER TRADES AND CONDUCT THEIR WORK TO PREVENT WORKER EXPOSURE OR SITE CONTAMINATION. REFER TO SPECIFICATION DIVISIONS 0, 1, AND 2 FOR SPECIFIC INFORMATION CONCERNING DISTURBING, REMOVING, AND DISPOSING OF THESE MATERIALS AND THE INSTALLATION OF THE NEW MATERIALS OR COMPONENTS. THIS NOTIFICATION IS PROVIDED IN ACCORDANCE WITH EPA AND OSHA REQUIREMENTS.

KEYNOTES - SECOND FLOOR - DEMOLITION

- DEMOLISH FULL HEIGHT OF EXISTING WALLS
- SAW CUT NEW OPENING IN CONCRETE FLOOR; SEE STRUCTURAL
- DEMOLISH DOOR AND FRAME
- DEMOLISH PORTION OF WALL AS NEEDED FOR NEW DOOR OPENING AND ASSOCIATED FRAMING
- DEMOLISH WALL BATTS AND ALL WALL FINISHES IN ROOM DEMOLISH FLOOR ASSEMBLY FOR NEW FLOOR OPENING;
- SEE STRUCTURAL DEMOLISH VENT GRILLE
- DEMOLISH EXTERIOR DUCT AND ASSOCIATED ATTACHMENT AND SUPPORT COMPONENTS
- DEMOLISH CARPET AND RUBBER BASE THROUGHOUT

SYSTEM BUILDING GRADES ASKA COURT S WDEN ADMIN E

AL, SNO ME

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JUSTIN M. SCANIO

08.08.2022

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SECOND FLOOR PLAN - DEMOLITION

Sheet Number

A202

- VARIOUS ADDITIONAL DEMOLITION OF FINISHES WILL BE REQUIRED FOR HEATING SYSTEM PIPING DEMOLITION AND REPLACEMENT.
- COORDINATE EXACT OPENING SIZES AND LOCATIONS WITH MECHANICAL EQUIPMENT.
- ARCHITECTURAL DRAWINGS ONLY INDICATE DUCT OPENINGS THROUGH FLOORS. COORDINATE ADDITONAL WALL OPENINGS REQUIRED FOR HVAC SYSTEM ROUTING. REUSE EXISTING WALL OPENINGS WHERE AVAILABLE.

PLAN LEGEND

EXISTING WALL

EXISTING TO BE DEMOLISHED

SKYBRIDGE

ROOF

FILES

304

D

NOTIFICATION OF POTENTIAL HAZARDS

ASBESTOS, LEAD, AND OTHER HAZARDOUS MATERIALS ARE PRESENT IN THE BUILDING AND MAY IMPACT THE WORK OF ALL TRADES. REGULATED AIR CONTAMINANTS, INCLUDING ASBESTOS AND LEAD, ARE ALSO PRESENT IN SETTLED AND CONCEALED DUST IN AND ON ARCHITECTURAL, STRUCTURAL, MECHANICAL, AND ELECTRICAL COMPONENTS OR SYSTEMS THROUGHOUT THE BUILDING. ALL TRADES SHALL COORDINATE WITH OTHER TRADES AND CONDUCT THEIR WORK TO PREVENT WORKER EXPOSURE OR SITE CONTAMINATION. REFER TO SPECIFICATION DIVISIONS 0, 1, AND 2 FOR SPECIFIC INFORMATION CONCERNING DISTURBING, REMOVING, AND DISPOSING OF THESE MATERIALS AND THE INSTALLATION OF THE NEW MATERIALS OR COMPONENTS. THIS NOTIFICATION IS PROVIDED IN ACCORDANCE WITH EPA AND OSHA REQUIREMENTS.

KEYNOTES - THIRD FLOOR & LOWER ROOF - DEMO.

- 1 SAW CUT CONCRETE SLAB TO ENLARGE OPENING; SEE STRUCTURAL
- DEMOLISH FIXED LADDER
- DEMOLISH WOOD FRAMED WALL, PARAPET, AND INTERIOR FURRING EXTENDING TO THE FLOOR SLAB
- DEMOLISH ROOF ASSEMBLY ABOVE EXISTING PLYWOOD DECK; DECK TO REMAIN
- DEMOLISH 48 INCH WIDE PORTION OF CMU WALL AT NEW STAIR (SEE 1/A1111)
- DEMOLISH FLOOR ASSEMBLY FOR NEW FLOOR OPENING; SEE STRUCTURAL; COORDINATE EXACT SIZE AND LOCATION WITH
- MECHANICAL

 8 DEMOLISH ROOF CURB WHERE EQUIPMENT IS DEMOLISHED
- 9 DEMOLISH EXTERIOR DUCT AND ASSOCIATED ATTACHMENT AND
- SUPPORT COMPONENTS

 10 DEMOLISH ROOF PENETRATION COMPONENTS AT DEMOLISHED
- CONDUIT AND PIPING

 11 DEMOLISH ROOF CURB CAP WHERE EQUIPMENT IS DEMOLISHED;
 EXISTING CURB TO REMAIN
- 12 DEMOLISH ROOF MEMBRANE AND TAPERED INSULATION LAYER WHERE NEW TAPERED INSULATION WILL BE INSTALLED
- 14 DEMOLISH EXISTING GWB FINISH AS NEEDED TO INSTALL NEW FIRESTOPPING SYSTEM BETWEEN FLOOR AND WALL
- 15 DEMOLISH PORTION OF WOOD WALL FOR NEW LOUVER PER
- 16 TEMPORARILY REMOVE AND REINSTALL FRAMING AND DECK TO MAKE OPENING FOR AHU INSTALLATION; ASSUME SMALLEST PIECE
- OF AHU IS 70"L x 84"W x 45" H

 DEMOLISH EXISTING EXTERIOR STUCCO AND PLASTER ON THIS
- DEMOLISH CARPET AND RUBBER BASE THROUGHOUT ROOM;
- REMOVE ADHESIVE FROM CONCRETE SUBSTRATE

 9 DEMOLISH DOOR LEAVES; FRAME TO REMAIN; SALVAGE
- 9 DEMOLISH DOOR LEAVES; FRAME TO REMAIN; SALVAGE HARDWARE FOR REUSE
- DEMOLISH INSULATION BETWEEN FLOOR AND WALL AS NEEDED FOR FIRESTOP JOINT INSTALLATION

DEMOLITION GENERAL NOTES

- 1. VARIOUS ADDITIONAL DEMOLITION OF FINISHES WILL BE REQUIRED FOR HEATING SYSTEM PIPING DEMOLITION AND
- COORDINATE EXACT OPENING SIZES AND LOCATIONS WITH MECHANICAL EQUIPMENT.
- ARCHITECTURAL DRAWINGS ONLY INDICATE DUCT OPENINGS THROUGH FLOORS. COORDINATE ADDITONAL WALL OPENINGS REQUIRED FOR HVAC SYSTEM ROUTING. REUSE EXISTING WALL OPENINGS WHERE AVAILABLE.

PLAN LEGEND

EXISTING WALL

EXISTING TO BE DEMOLISHED

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ALASKA COURT SYSTEM SNOWDEN ADMIN BUILDING MECHANICAL UPGRADES

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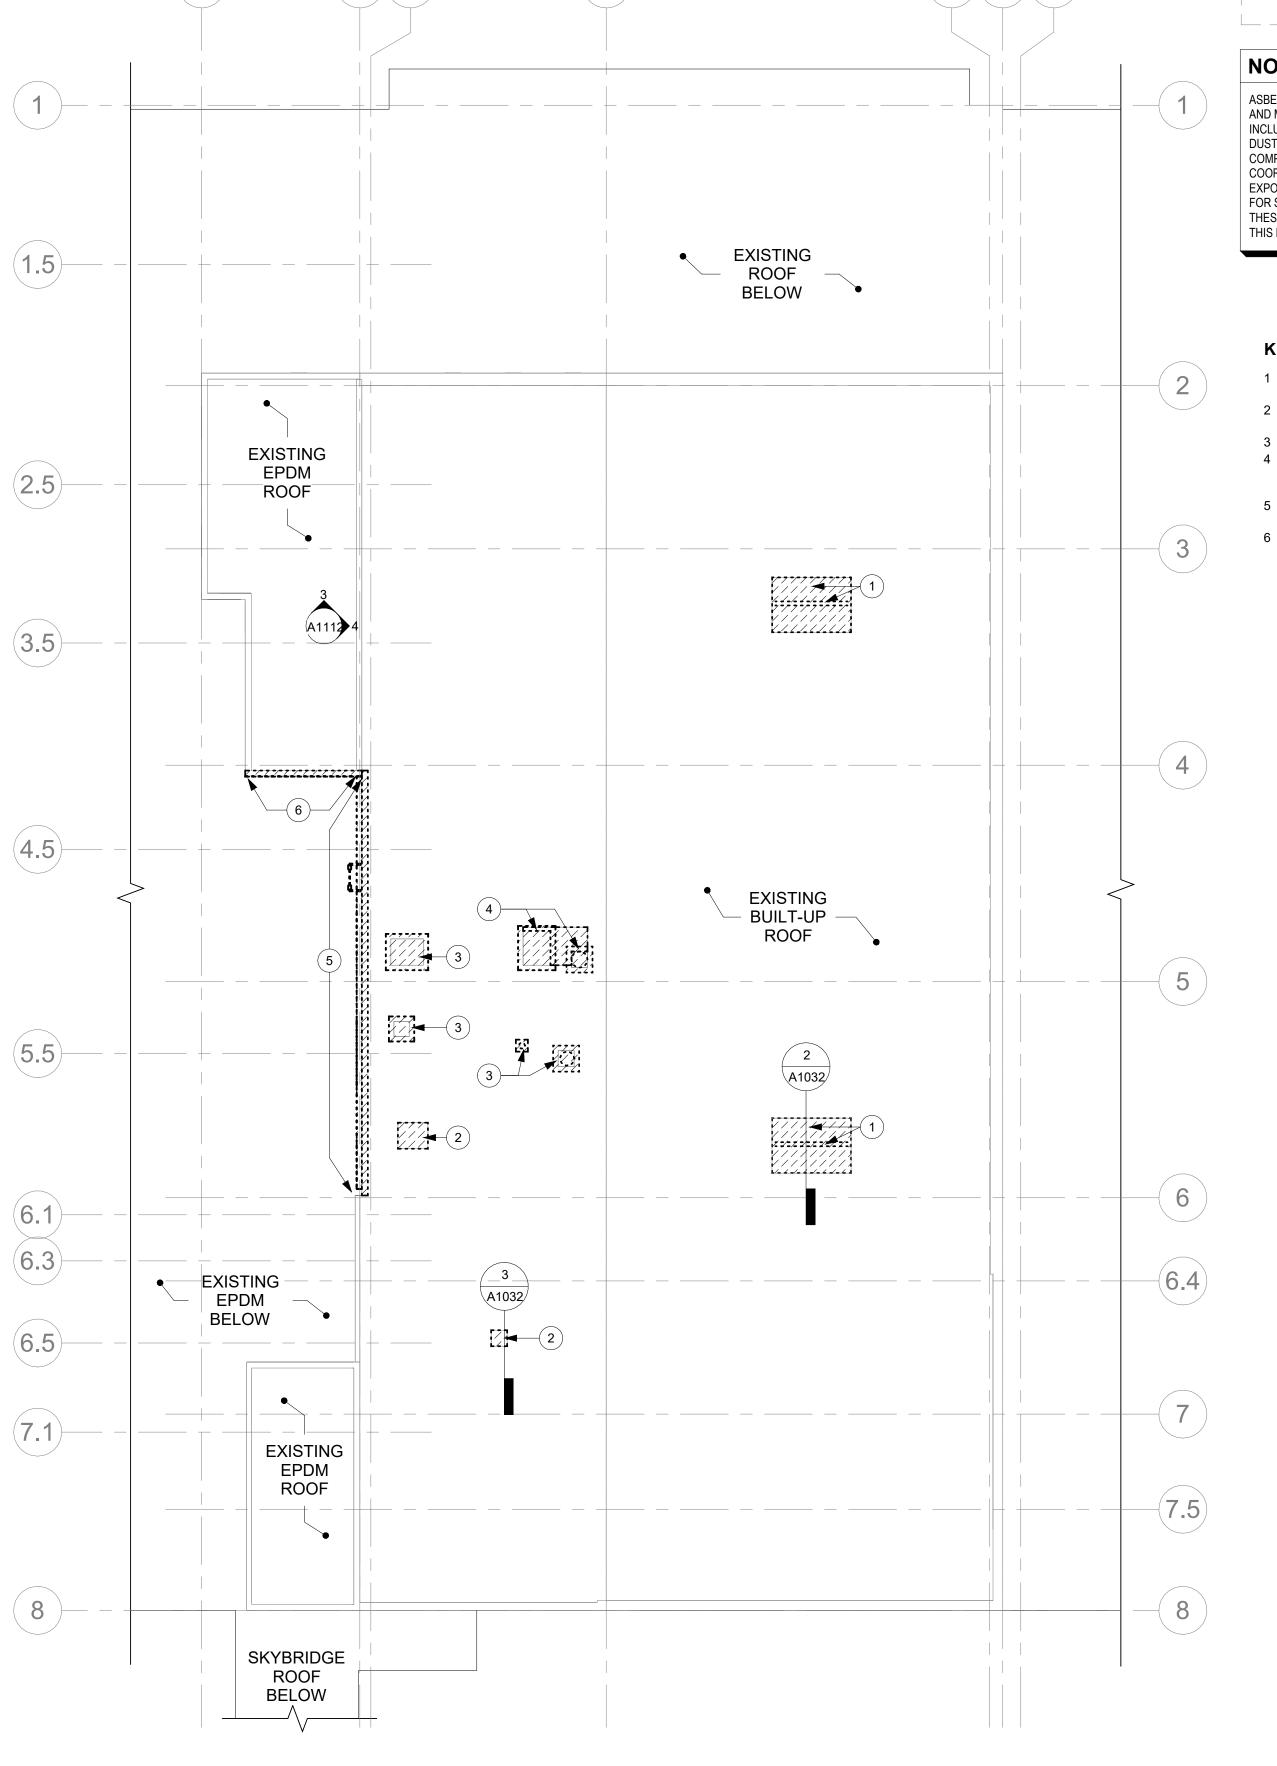
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Sheet Title THIRD FLOOR, LOWER ROOF PLAN -DEMOLITION

Sheet Number



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1 UPPER ROOF PLAN - DEMOLITION 1/8" = 1'-0"

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NOTIFICATION OF POTENTIAL HAZARDS

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KEYNOTES - UPPER ROOF - DEMOLITION

- DEMOLISH VENT DOORS AND HARDWARE COMPONENTS; DEMOLISH CENTER SUPPORT JAMB; LEAVE CURB IN PLACE DEMOLISH ROOF ASSEMBLY AS NEEDED FOR NEW DUCT
- PENETRATION
- DEMOLISH CURB CAP; CURB TO REMAIN
 DEMOLISH ROOF CURBS; DEMOLISH ROOF ASSEMBLY TO
 ENLARGE AND CONNECT OPENINGS FOR NEW DUCT
- DEMOLISH PARAPET AND PORTION OF EXISTING ROOF AS NEEDED FOR NEW PARAPET ALONG SEISMIC JOINT
- DEMOLISH PARAPET FLASHING AS NEEDED FOR INSTALLATION OF NEW SEISMIC JOINT

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Sheet Title

UPPER ROOF PLAN -

Sheet Number

DEMOLITION

['] 1/8" = 1'-0"

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SYSTEM BUILDING GRADES **ADMIN** WDEN A AL, SNO ME

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Sheet Title

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WALLS: (N) PAINT BASE: (N) 4" RESILIENT

1 SECOND FLOOR PLAN 1/8" = 1'-0"



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NOTIFICATION OF POTENTIAL HAZARDS

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KEYNOTES - SECOND FLOOR

- EXTEND WALL FRAMING TO UNDERSIDE OF FLOOR FRAMING ABOVE AT NORTH AND WEST WALLS OF FORMER COPY ROOM. EXTEND GWB FINISH TO UNDERSIDE OF FRAMING ON BOTH SIDES OF WALL; COORDINATE REQUIRED OPENINGS WITH MECHANICAL
- NEW HOUSEKEEPING PAD; SEE STRUCTURAL
- INSTALL NEW DOUBLE DOOR; PAINT TO MATCH SURROUNDING WALL
- INFILL WALL FRAMING AND PAINTED GWB FOR CONTINUOUS FINISH BOTH SIDES
- INSTALL GWB WALL FINISH THROUGHOUT ROOM TO EXTEND 4 INCHES ABOVE CEILING
- PAINT ENTIRE WALL BETWEEN ARROWS
- INFILL EXISTING OPENING WITH FIRE RATED ASSEMBLY WITH OPENINGS SIZED FOR NEW DUCT PENETRATIONS
- IN HATCHED SEGMENT, CONFIRM EXISTING PENETRATIONS ARE PROTECTED WITH FIRESTOPPING; PROVIDE FIRESTOPPING WHERE NOT ALREADY INSTALLED; PATCH WALL TO MAINTAIN FIRE RATING WHERE PENETRATIONS ARE FOUND ABANDONED OR ARE ABANDONED BY THIS WORK
- PATCH ALL HOLES REMAINING FROM EXTERIOR DUCT ATTACHMENT SO FINISH AND WEATHERTIGHTNESS ARE
 - CONFIGURE NEW WALLS TO AVOID EXISTING WOOD TRIM AT RAIL; FINISH AND PAINT TO MATCH SURROUNDING WALLS

FLOOR PLAN GENERAL NOTES

- SEE A001 FOR WALL ASSEMBLIES. SEE A1111 FOR DOOR, FRAME, AND HARDWARE INFORMATION.
- PATCH AND REPAIR ALL BLEMISHES OR PENETRATIONS
- REMAINING FROM DEMOLISHED OR RELOCATED FIXTURES, MATERIALS, OR EQUIPMENT TO LIKE NEW CONDITION.
- INSTALL REQUIRED FIRESTOPPING AT ALL NEW PENETRATIONS AND ALL NEWLY VACATED PENETRATIONS THROUGH FIRE RESISTANCE RATED ASSEMBLIES. REFER TO CODE PLANS ON G002.


PLAN LEGEND

NEW (N) CONSTRUCTION

EXISTING (E) WALL

FLOOR: (N) CERAMIC TILE
WALLS: (N) PAINT
BASE: (N) 4" BULLNOSE TILE

(N) ROOF MEMBRANE

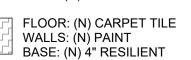

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> SYSTEM BUILDING GRADES ADMIN WDEN A

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Sheet Title SECOND FLOOR PLAN

Sheet Number

KEYNOTES - THIRD FLOOR & LOWER ROOF

- INFILL EXISTING OPENING IN CONCRETE FLOOR SEE STRUCT. INSTALL FIRE RATED WALLS AND FIRE RATED HORIZONTAL
- ASSEMBLY OVER OPENINGS IN CONCRETE FLOOR
- METAL STAIR WITH HANDRAILS
- INSTALL FIRESTOPPING AT SLAB EDGE FOR FULL LENGTH OF ROOM; EXTEND NORTH OF ROOM CONTINUOUSLY THROUGH ENCLOSED CHASE AND BEHIND COLUMN AT GRID 4
- INSTALL CERAMIC TILE FLOORING AND PAINTED GWB WALL FINISH THROUGHOUT ADDITION
- INSTALL TAPERED INSULATION AND ROOF MEMBRANE IN HATCHED
- AREA; TIE INTO EXISTING USING MANUFACTURER DETAILS INSTALL FIRE EXTINGUISHER MOUNTED TO WALL; TYPE 2A, 10BC
- PATCH ROOF ASSEMBLY AT DEMOLISHED CONDUIT AND PIPING INSTALL DOUBLE DOORS; INSULATED METAL PAINTED TO MATCH
- SIDING; SEE A1111 AND SPECS EXISTING ROOF CURB TO REMAIN; INFILL OPENING WITH COMPLETE ROOF ASSEMBLY SIM. TO ASSEMBLY R-1. MAINTAIN VAPOR BARRIER CONTINUITY BETWEEN EXISTING AND NEW.
- INFILL GWB PLENUM LID BELOW. PATCH ALL HOLES REMAINING FROM EXTERIOR DUCT ATTACHMENT SO FINISH AND WEATHERTIGHTNESS ARE
- INFILL PORTION OF EXISTING OPENING
- INSTALL ROOF WALKWAY PADS FROM EXISTING WALKWAY TO FIXED LADDER AND AROUND ROOF-MOUNTED EQUIPMENT AS
- CONFIRM FIRESTOPPING IS PROVIDED AT EXISTING FLOOR PENETRATIONS, AND INSTALL FIRESTOPPING AT UNPROTECTED PENETRATIONS THROUGHOUT ROOMS 307, 308, AND 309 AND ADJACENT CHASES
- INSTALL NEW FIXED LADDER ON (N) WALL; INSTALL BLOCKING FOR **ATTACHMENT**
- INSTALL EXPANSION JOINT AT JUNCTION BETWEEN NEW AND
- **EXISTING WALLS** INSTALL FLOOR OPENING WITH CURB ALL SIDES
- EXTEND WALL FRAMING AND FINISH TO UNDERSIDE OF STRUCTURE; PAINT ALL WALLS, AND INSTALL NEW RESILIENT BASE AROUND ROOM; APPLY WATERPROOFING SEALANT TO EXISTING CONCRETE SLAB.
- PAINT WALLS THROUGHOUT 307 AND 307A
- STRUCTURAL STEEL SUPPORTING EXPANDED OPENINGS IN THIS SLAB TO BE COATED WITH INTUMESCENT PAINT FOR 1-HOUR FIRE APPLY 5/8" TYPE X GWB OVER ENTIRE SOUTH WALL OF STAIR (GA
- FILE, WP 3510); SEE DETAILS FOR ADDITIONAL INFO.
- REPAIR AND REPLACE GWB WHERE DAMAGED AND INSTALL NEW CONTROL JOINTS; SEE ENLARGED PLANS AND DETAILS FOR MORE
- PAINT WALL TO MATCH SURROUNDING

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NOTIFICATION OF POTENTIAL HAZARDS

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FLOOR PLAN GENERAL NOTES

- SEE A001 FOR WALL ASSEMBLIES. SEE A1111 FOR DOOR, FRAME, AND HARDWARE
- INFORMATION. PATCH AND REPAIR ALL BLEMISHES OR PENETRATIONS
- REMAINING FROM DEMOLISHED OR RELOCATED FIXTURES, MATERIALS, OR EQUIPMENT TO LIKE NEW CONDITION. INSTALL REQUIRED FIRESTOPPING AT ALL NEW
- PENETRATIONS AND ALL NEWLY VACATED PENETRATIONS THROUGH FIRE RESISTANCE RATED ASSEMBLIES. REFER TO CODE PLANS ON G002.


PLAN LEGEND

NEW (N) CONSTRUCTION EXISTING (E) WALL

FLOOR: (N) CERAMIC TILE WALLS: (N) PAINT BASE: (N) 4" BULLNOSE TILE

(N) ROOF MEMBRANE

FLOOR: (N) CARPET TILE WALLS: (N) PAINT BASE: (N) 4" RESILIENT

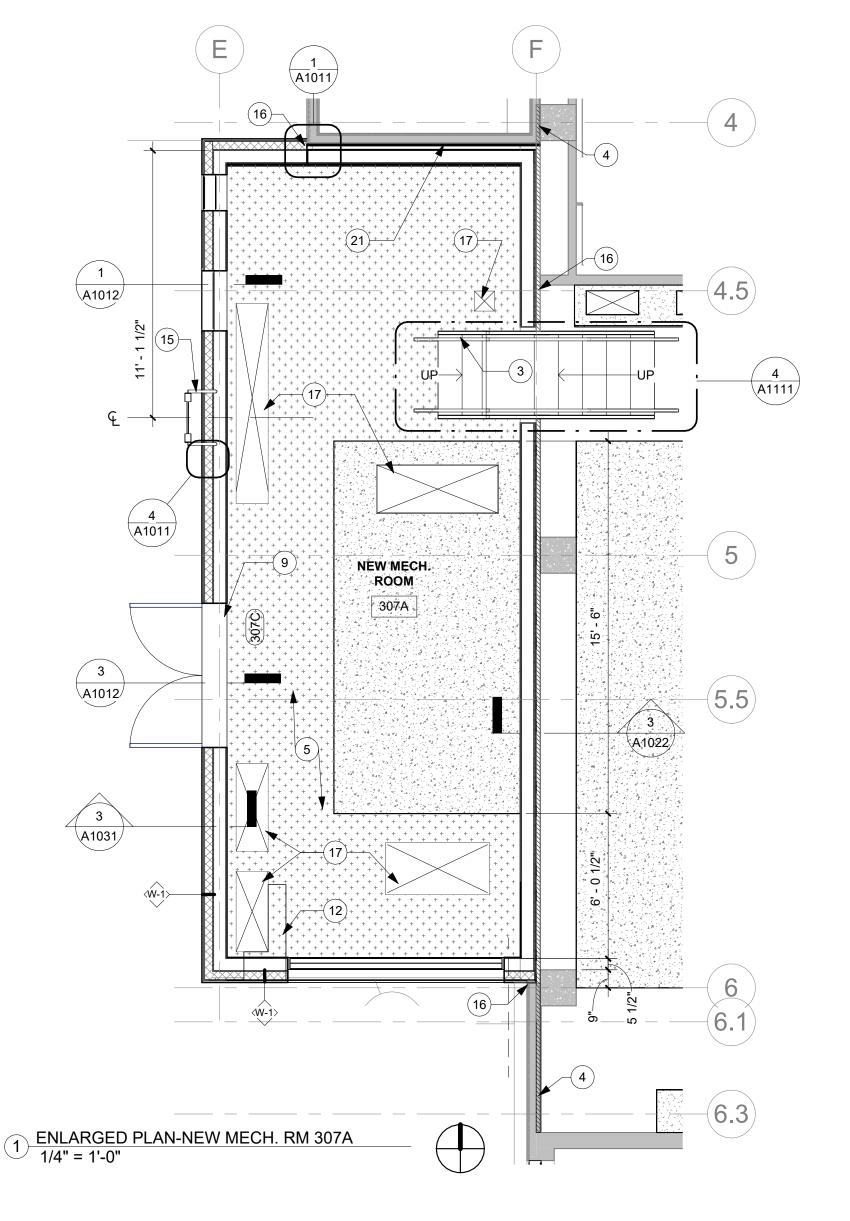







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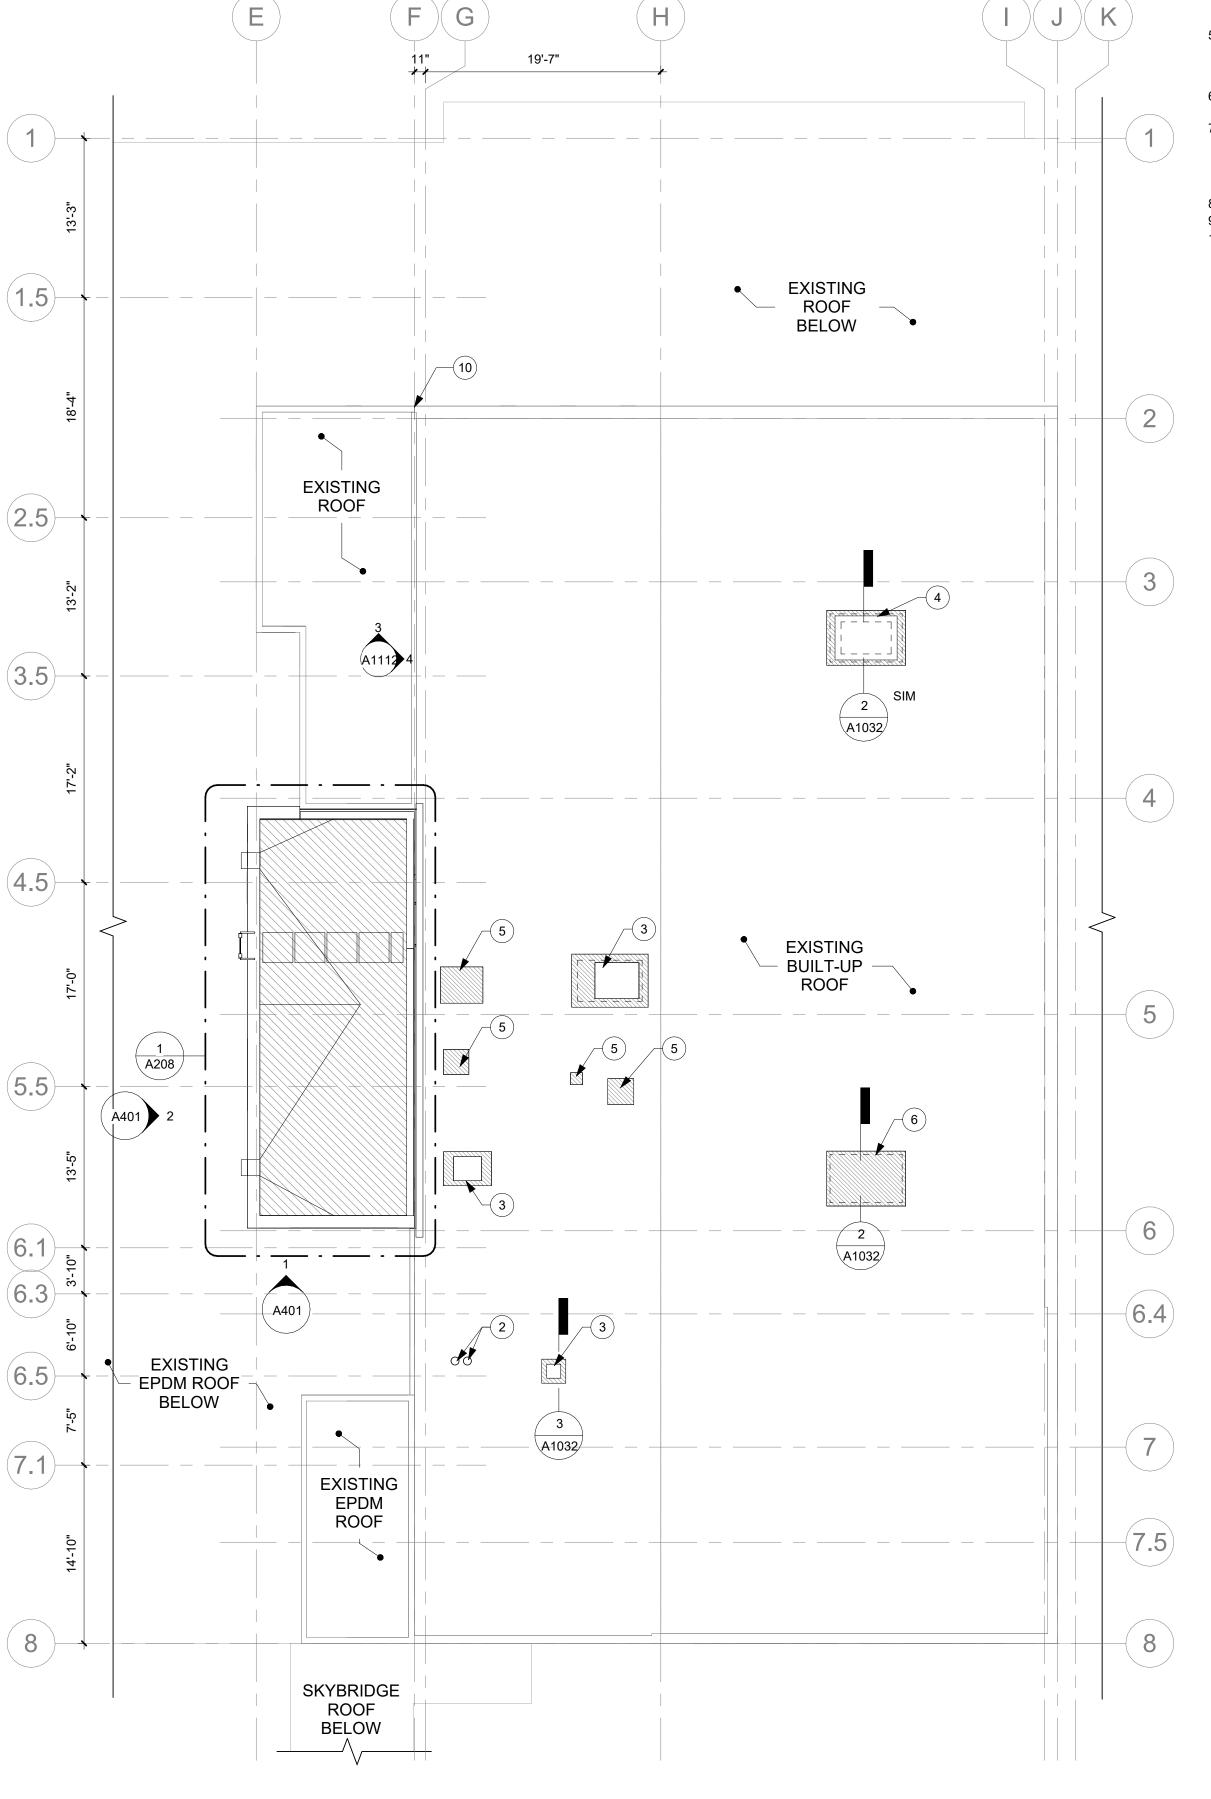
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LOWER ROOF PLAN

THIRD FLOOR,

Sheet Number **A207**



2 UPPER ROOF PLAN 1/8" = 1'-0"

KEYNOTES - UPPER ROOF

SCUPPER WITH DOWNSPOUT AND HEAT TRACE

2 CONSTRUCT ROOF CURB IN EXISTING ROOF FOR BOILER FLUE 3 CONSTRUCT ROOF CURB IN EXISTING ROOF FOR MECHANICAL

4 INFILL EXISTING SMOKE VENT CURB WITH COMPLETE ROOF ASSEMBLY; CONSTRUCT NEW CURB WITHIN EXISITNG SMOKE

VENT CURB
EXISTING ROOF CURB TO REMAIN; INFILL OPENING WITH
COMPLETE ROOF ASSEMBLY ON METAL DECK SIM. TO ASSEMBLY
R-1. MAINTAIN VAPOR BARRIER CONTINUITY BETWEEN EXISTING
AND NEW

INFILL EXISTING SMOKE VENT CURB WITH COMPLETE ROOF
ASSEMBLY; EXISTING MANUFACTURED CURB TO REMAIN IN PLACE
INSTALL EXPANSION JOINT BETWEEN ADDITION AND ADJACENT
CONSTRUCTION; JOINT TO EXTEND HORIZONTALLY ALONG ROOF
JUNCTURE AND VERTICALLY DOWN THE CORNERS AT EACH END;
INSTALLATION INSTRUCTIONS AND PRE-MFR TRANSITIONS AND
TERMINATIONS PER EXPANSION JOINT MFR.

TIE IN NEW PARAPET FLASHING TO EXISTING

INSTALL ROOF WALKWAY PADS

AT GRID F, NOTCH 1/2" VERTICAL CONTROL JOINT IN EXISTING DAMAGED PLASTER FINISH; FILL WITH FLEXIBLE SEALANT AND COVER WITH PRE-FINISHED ALUMINUM (V) CONTROL JOINT COVER. AT PARAPET, REMOVE EXISTING FLASHING AS NECESSARY TO INSTALL CONT. JOINT. AT BASE, TERMINATE AT TOP OF EXISTING ROOF MEMBRANE TERMINATION BAR AND PROVIDE CONTROL JOINT MFR RECOMMENDED FLASHING.

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FLOOR PLAN GENERAL NOTES

- SEE A001 FOR WALL ASSEMBLIES.
 SEE A1111 FOR DOOR, FRAME, AND HARDWARE
- SEE A1111 FOR DOOR, FRAME, AND HARDWARE INFORMATION.
 PATCH AND REPAIR ALL BLEMISHES OR PENETRATIONS
- REMAINING FROM DEMOLISHED OR RELOCATED FIXTURES,
 MATERIALS, OR EQUIPMENT TO LIKE NEW CONDITION.
- I. INSTALL REQUIRED FIRESTOPPING AT ALL NEW PENETRATIONS AND ALL NEWLY VACATED PENETRATIONS THROUGH FIRE RESISTANCE RATED ASSEMBLIES. REFER TO CODE PLANS ON G002.

PLAN LEGEND


NEW (N) CONSTRUCTION


EXISTING (E) WALL


FLOOR: (N) CERAMIC TILE
WALLS: (N) PAINT
BASE: (N) 4" BULLNOSE TILE

(N) ROOF MEMBRANE

FLOOR: (N) CARPET TILE WALLS: (N) PAINT BASE: (N) 4" RESILIENT

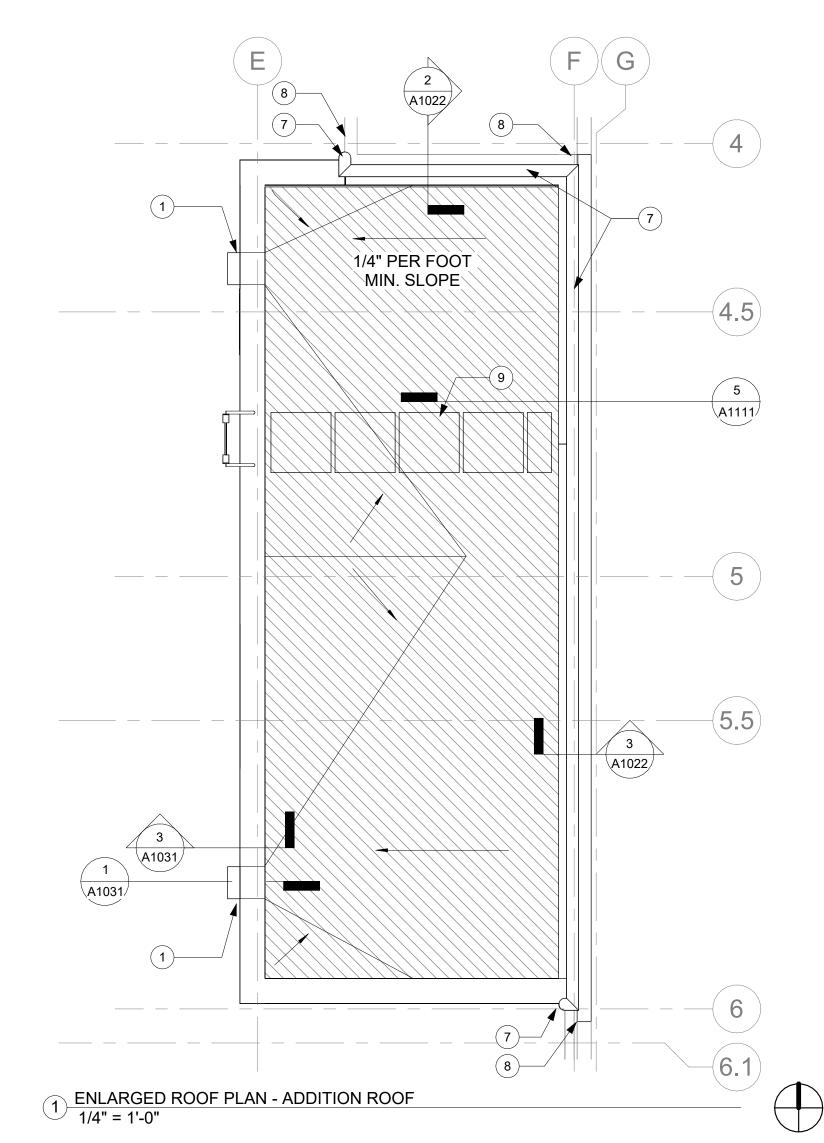

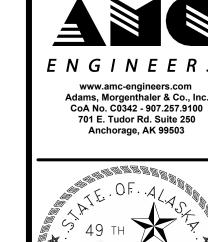

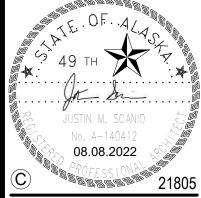



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ALASKA COURT SYSTEM SNOWDEN ADMIN BUILDIN MECHANICAL UPGRADES

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AMC Project: 21805
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Sheet Title
UPPER ROOF PLAN

Sheet Number

NOTIFICATION OF POTENTIAL HAZARDS

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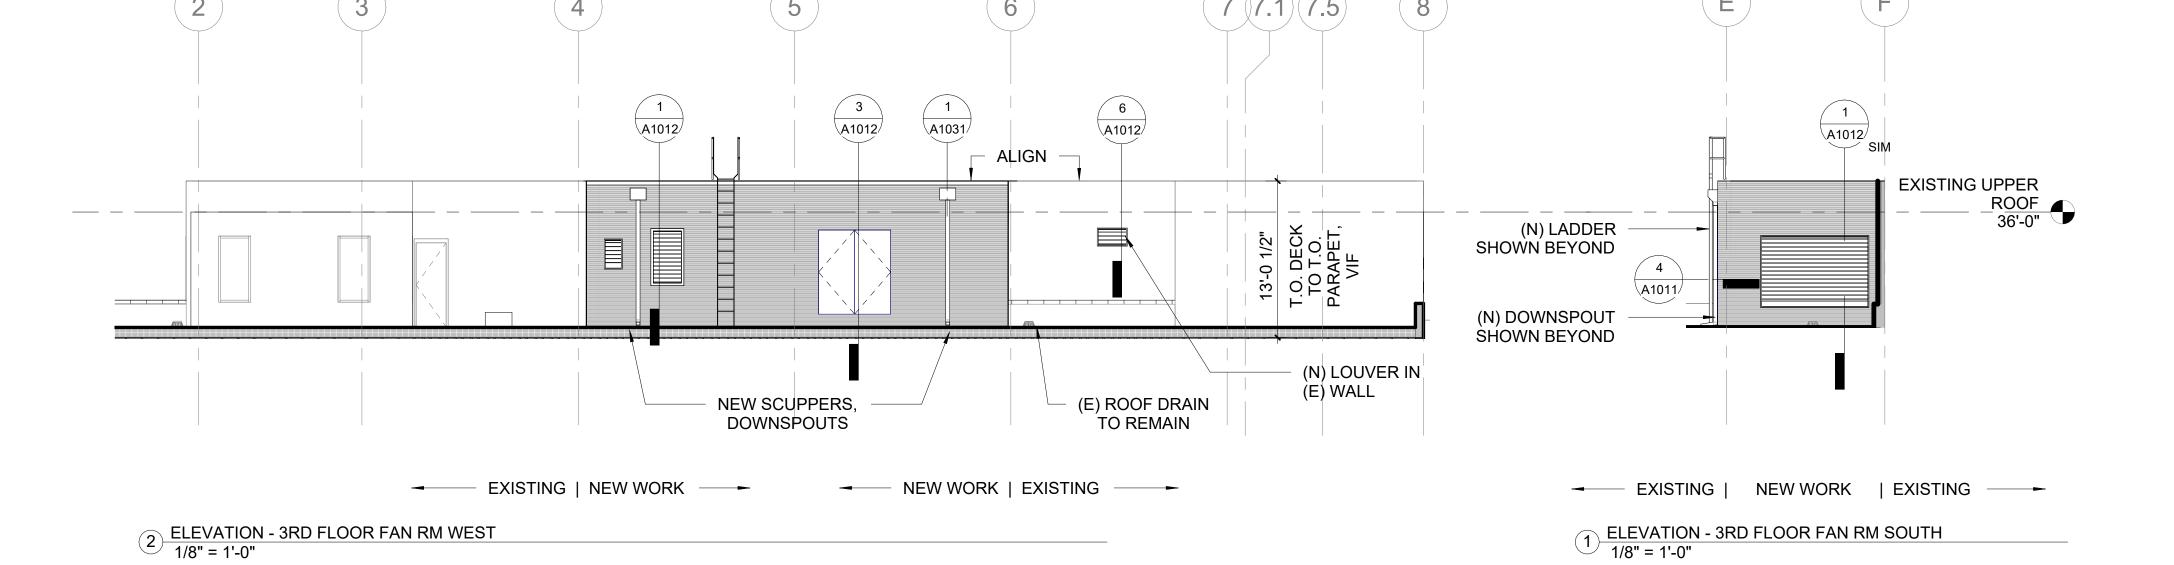
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Sheet Title ELEVATIONS

Sheet Number A401



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MICROGRAPHICS

NOTIFICATION OF POTENTIAL HAZARDS

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LOBBY

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ATRIUM (OPEN TO ABOVE)

ATRIUM (OPEN

TO ABOVE)

LOBBY

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MAIL

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REFLECTED CEILING PLAN GENERAL NOTES

- REMOVE AND REINSTALL EXISTING CEILING TILES AS NEEDED TO INSTALL NEW EQUIPMENT. REPLACE ANY TILES THAT ARE REMOVED AND HAVE EXISTING DAMAGE AS WELL AS ANY TILES THAT ARE DAMAGED IN THE COURSE OF THE WORK. WHERE 50% OR MORE OF THE TILES ARE REMOVED IN CEILINGS OVER 144 SF , THE CEILING MUST BE EVALUATED FOR COMPLIANCE WITH THE SEISMIC PROVISIONS OF ASCE 7. UPGRADE SEISMIC BRACING TO COMPLY WITH ASCE 7 AND THE REQUIREMENTS OF 2018 IEBC SECTION 302.8 AS LOCALLY AMENDED.
- PLANS DO NOT INDICATE ALL CEILING FIXTURES. REFER TO MECHANICAL AND ELECTRICAL DRAWINGS FOR ADDITIONAL CEILING FIXTURE, AND EQUIPMENT
- RELOCATE LUMINAIRES AND OTHER CEILING FIXTURES AS REQUIRED FOR NEW VENTILATION
- WHERE NEW ACT CEILINGS ARE DIRECTLY ADJACENT TO EXISTING, TIE NEW GRID INTO EXISTING AND ALIGN FOR CONTINUOUS, SEAMLESS APPEARANCE.
- SEE MECHANICAL AND ELECTRICAL DRAWINGS FOR FINAL LAYOUT OF DEMOLISHED AND NEW CEILING MOUNTED FIXTURES (INCLUDING LIGHT FIXTURES SUPPLY/RETURN FIXTURES, ETC.).

ADDITIVE ALTERNATES — — —

ADDITIVE ALTERNATE #1

DEMOLISH ALL 2'X4' ACT CEILINGS IN THE OUTLINED AREA. INSTALL NEW 2'X4' ACT CEILING IN SAME LOCATION AND HEIGHT AS DEMOLISHED 2'X4' ACT CEILINGS. TYPE C1(E) LOCATIONS SHALL BE REPLACED WITH TYPE C1, AND TYPE C2(E) SHALL BE REPLACED WITH TYPE C2.

ADDITIVE ALTERNATE #2

DEMOLISH ALL LIGHTING AND INSTALL NEW LIGHTING IN ALL LOCATIONS IN THE OUTLINED AREA. SEE ELECTRICAL FOR MORE

DEMO RCP LEGEND

C1(E) - EXISTING 2'x4' SUSPENDED ACT

C2(E) - EXISTING 2'x4' SUSPENDED ACT CEILING W/ TEGULAR EDGE "2X2 LOOK" TILES


DEMOLISH 2x4 SUSPENDED ACT CEILING AND LIGHTING

C4(E) - EXISTING GWB CEILING (SUSPENDED UNLESS NOTED OTHERWISE)

DEMOLISH GWB CEILING (SUSPENDED UNLESS NOTED OTHERWISE)

EXISTING LIGHT FIXTURE; SIZE AND TYPE VARY - SEE ELECTRICAL

DEMOLISH LIGHT FIXTURE; SIZE AND TYPE VARY - SEE ELECTRICAL.

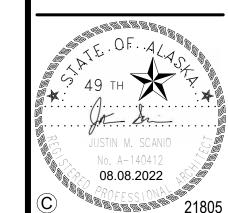

ARCHITECTURE DESIGN STRATEGY

3909 ARCTIC BLVD., STE 100 ANCHORAGE, AK 99503 907.561.5543

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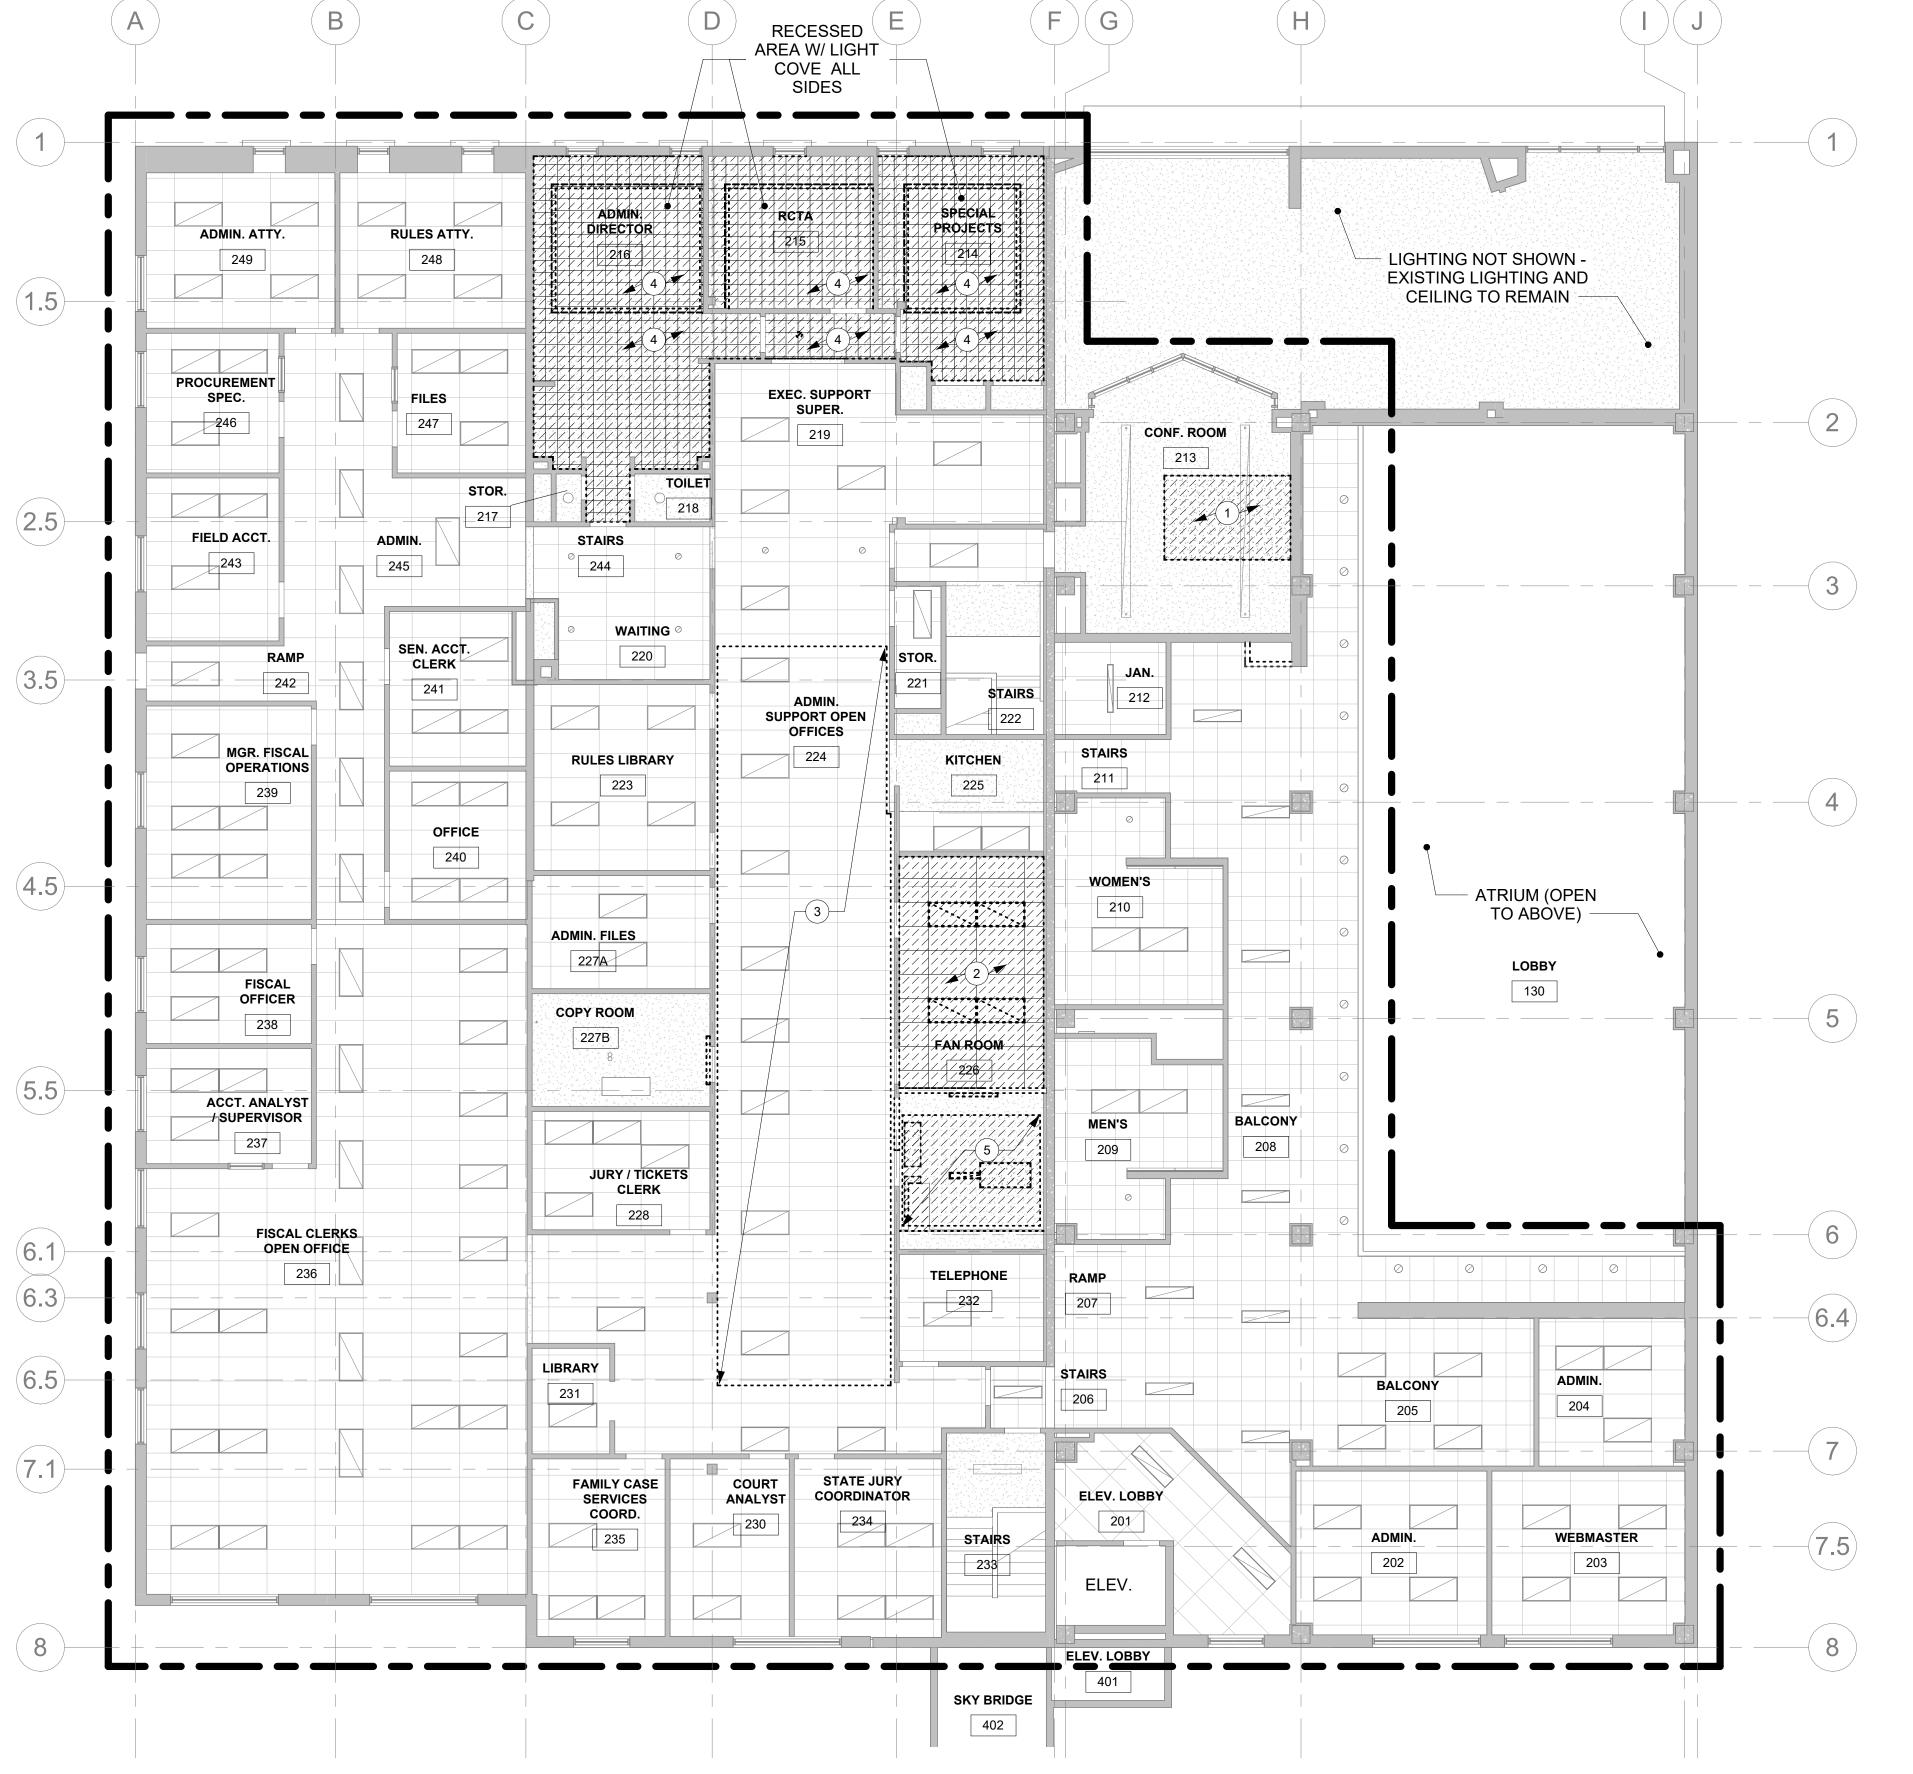
08/08/2022 Date: Project Phase

PERMIT DRAWINGS

FIRST FLOOR RCP -DEMOLITION

Sheet Number A901

1 SECOND FLOOR RCP - DEMOLITION 1/8" = 1'-0"



MOA ePlan Stamp

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KEYNOTES - SECOND FLOOR RCP - DEMOLITION

- 1 DEMOLISH GWB CEILING
- 2 DEMOLISH ACT GRID CEILING
- DEMOLISH GYPSUM BOARD ON BOTTOM OF STRUCTURE ABOVE SUSPENDED CEILING AS NEEDED FOR INSTALLATION OF SISTERED JOISTS PER STRUCTURAL
- DEMOLISH 12X12 ACOUSTICAL TILES AND CONCEALED GRID SUSPENSION SYSTEM; PLYWOOD FRAME WITH LIGHT COVE AND WOOD TRIM TO REMAIN
- DEMOLISH GWB CEILING WHERE REQUIRED FOR TEMPORARY REMOVAL OF FRAMING AND DECK ABOVE FOR AHU

REFLECTED CEILING PLAN GENERAL NOTES

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DEMO RCP LEGEND

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DEMOLISH GWB CEILING (SUSPENDED

EXISTING LIGHT FIXTURE; SIZE AND TYPE VARY - SEE ELECTRICAL

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DEMOLISH LIGHT FIXTURE; SIZE AND TYPE VARY - SEE ELECTRICAL.

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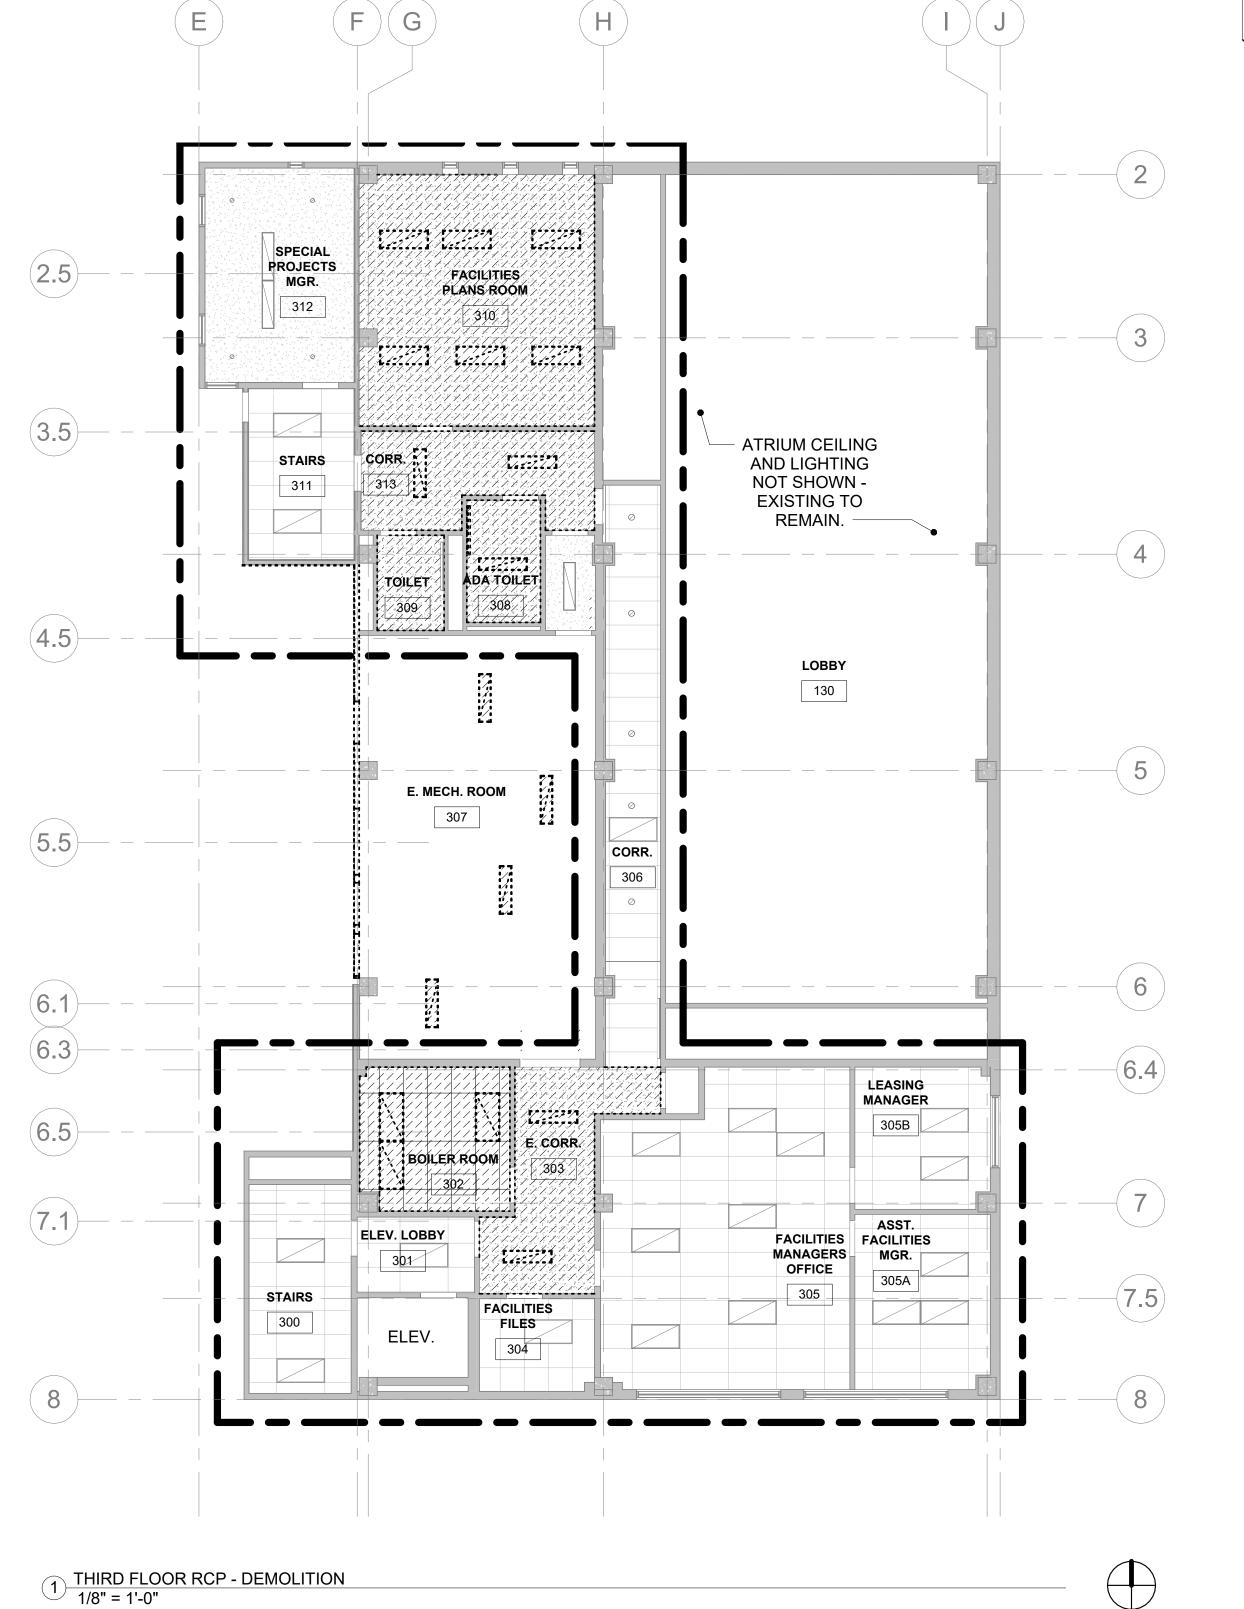
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AMC Project: 21805 08/08/2022 Date:

Project Phase PERMIT DRAWINGS

SECOND FLOOR RCP - DEMOLITION

Sheet Number



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NOTIFICATION OF POTENTIAL HAZARDS

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CEILING

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CEILING W/ TEGULAR EDGE "2X2 LOOK" TILES


DEMOLISH 2x4 SUSPENDED ACT CEILING AND LIGHTING


C4(E) - EXISTING GWB CEILING (SUSPENDED UNLESS NOTED OTHERWISE)

DEMOLISH GWB CEILING (SUSPENDED UNLESS NOTED OTHERWISE)

EXISTING LIGHT FIXTURE; SIZE AND TYPE VARY - SEE ELECTRICAL

DEMOLISH LIGHT FIXTURE; SIZE AND TYPE VARY - SEE ELECTRICAL.

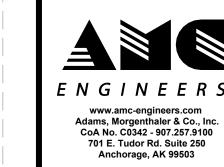

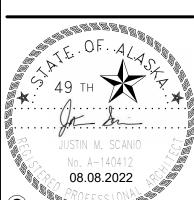

21805

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ALASKA COURT SYSTEM NOWDEN ADMIN BUILDING MECHANICAL UPGRADES

Revisions
No. Date Description

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Checked by: BAM
AMC Project: 21805
Date: 08/08/2022

Project Phase
PERMIT DRAWINGS

Sheet Title THIRD FLOOR RCP -DEMOLITION

Sheet Number

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HR OPEN

OFFICE

162

HR OPEN

OFFICE

HUMAN

RESOURCES

RECEPTION

123

LOBBY

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ATRIUM (OPEN

TO ABOVE)

VEST.

121

D

HR ANALYST

160

GENERALIST

161

HR DEPUTY

159

HR DIRECTOR

158

1) FIRST FLOOR RCP 1/8" = 1'-0"

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KEYNOTES - FIRST FLOOR RCP

- NEW CEILING AT LOWER HEIGHT THAN ORIGINAL; ADJUST SPRINKLERS AND OTHER CEILING FIXTURES AS NEEDED
- INSTALL STANDARD EDGE TERMINATION WHERE FORMERLY CONTINUOU ACT GRID WAS CUT

REFLECTED CEILING PLAN GENERAL NOTES

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ADDITIVE ALTERNATES — — —

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RCP LEGEND

C1(E) - EXISTING 2'x4' SUSPENDED ACT

C2(E) - EXISTING 2'x4' SUSPENDED ACT CEILING W/ TEGULAR EDGE "2X2 LOOK" TILES

C1 - NEW 2x4 ACOUSTIC CEILING TILE

C3 - NEW 1'x4' SUSPENDED ACT CEILING

C4(E) - EXISTING GWB CEILING

(SUSPENDED UNLESS NOTED OTHERWISE) C4 - NEW PAINTED GWB CEILING

(SUSPENDED UNLESS NOTED OTHERWISE) EXISTING LIGHT FIXTURE; SIZE AND TYPE

VARY - SEE ELECTRICAL NEW LIGHT FIXTURE; SIZE AND TYPE VARY -

SEE ELECTRICAL.

NEW VENTILATION SUPPLY OR RETURN; SIZE AND TYPE VARY - SEE MECHANICAL.

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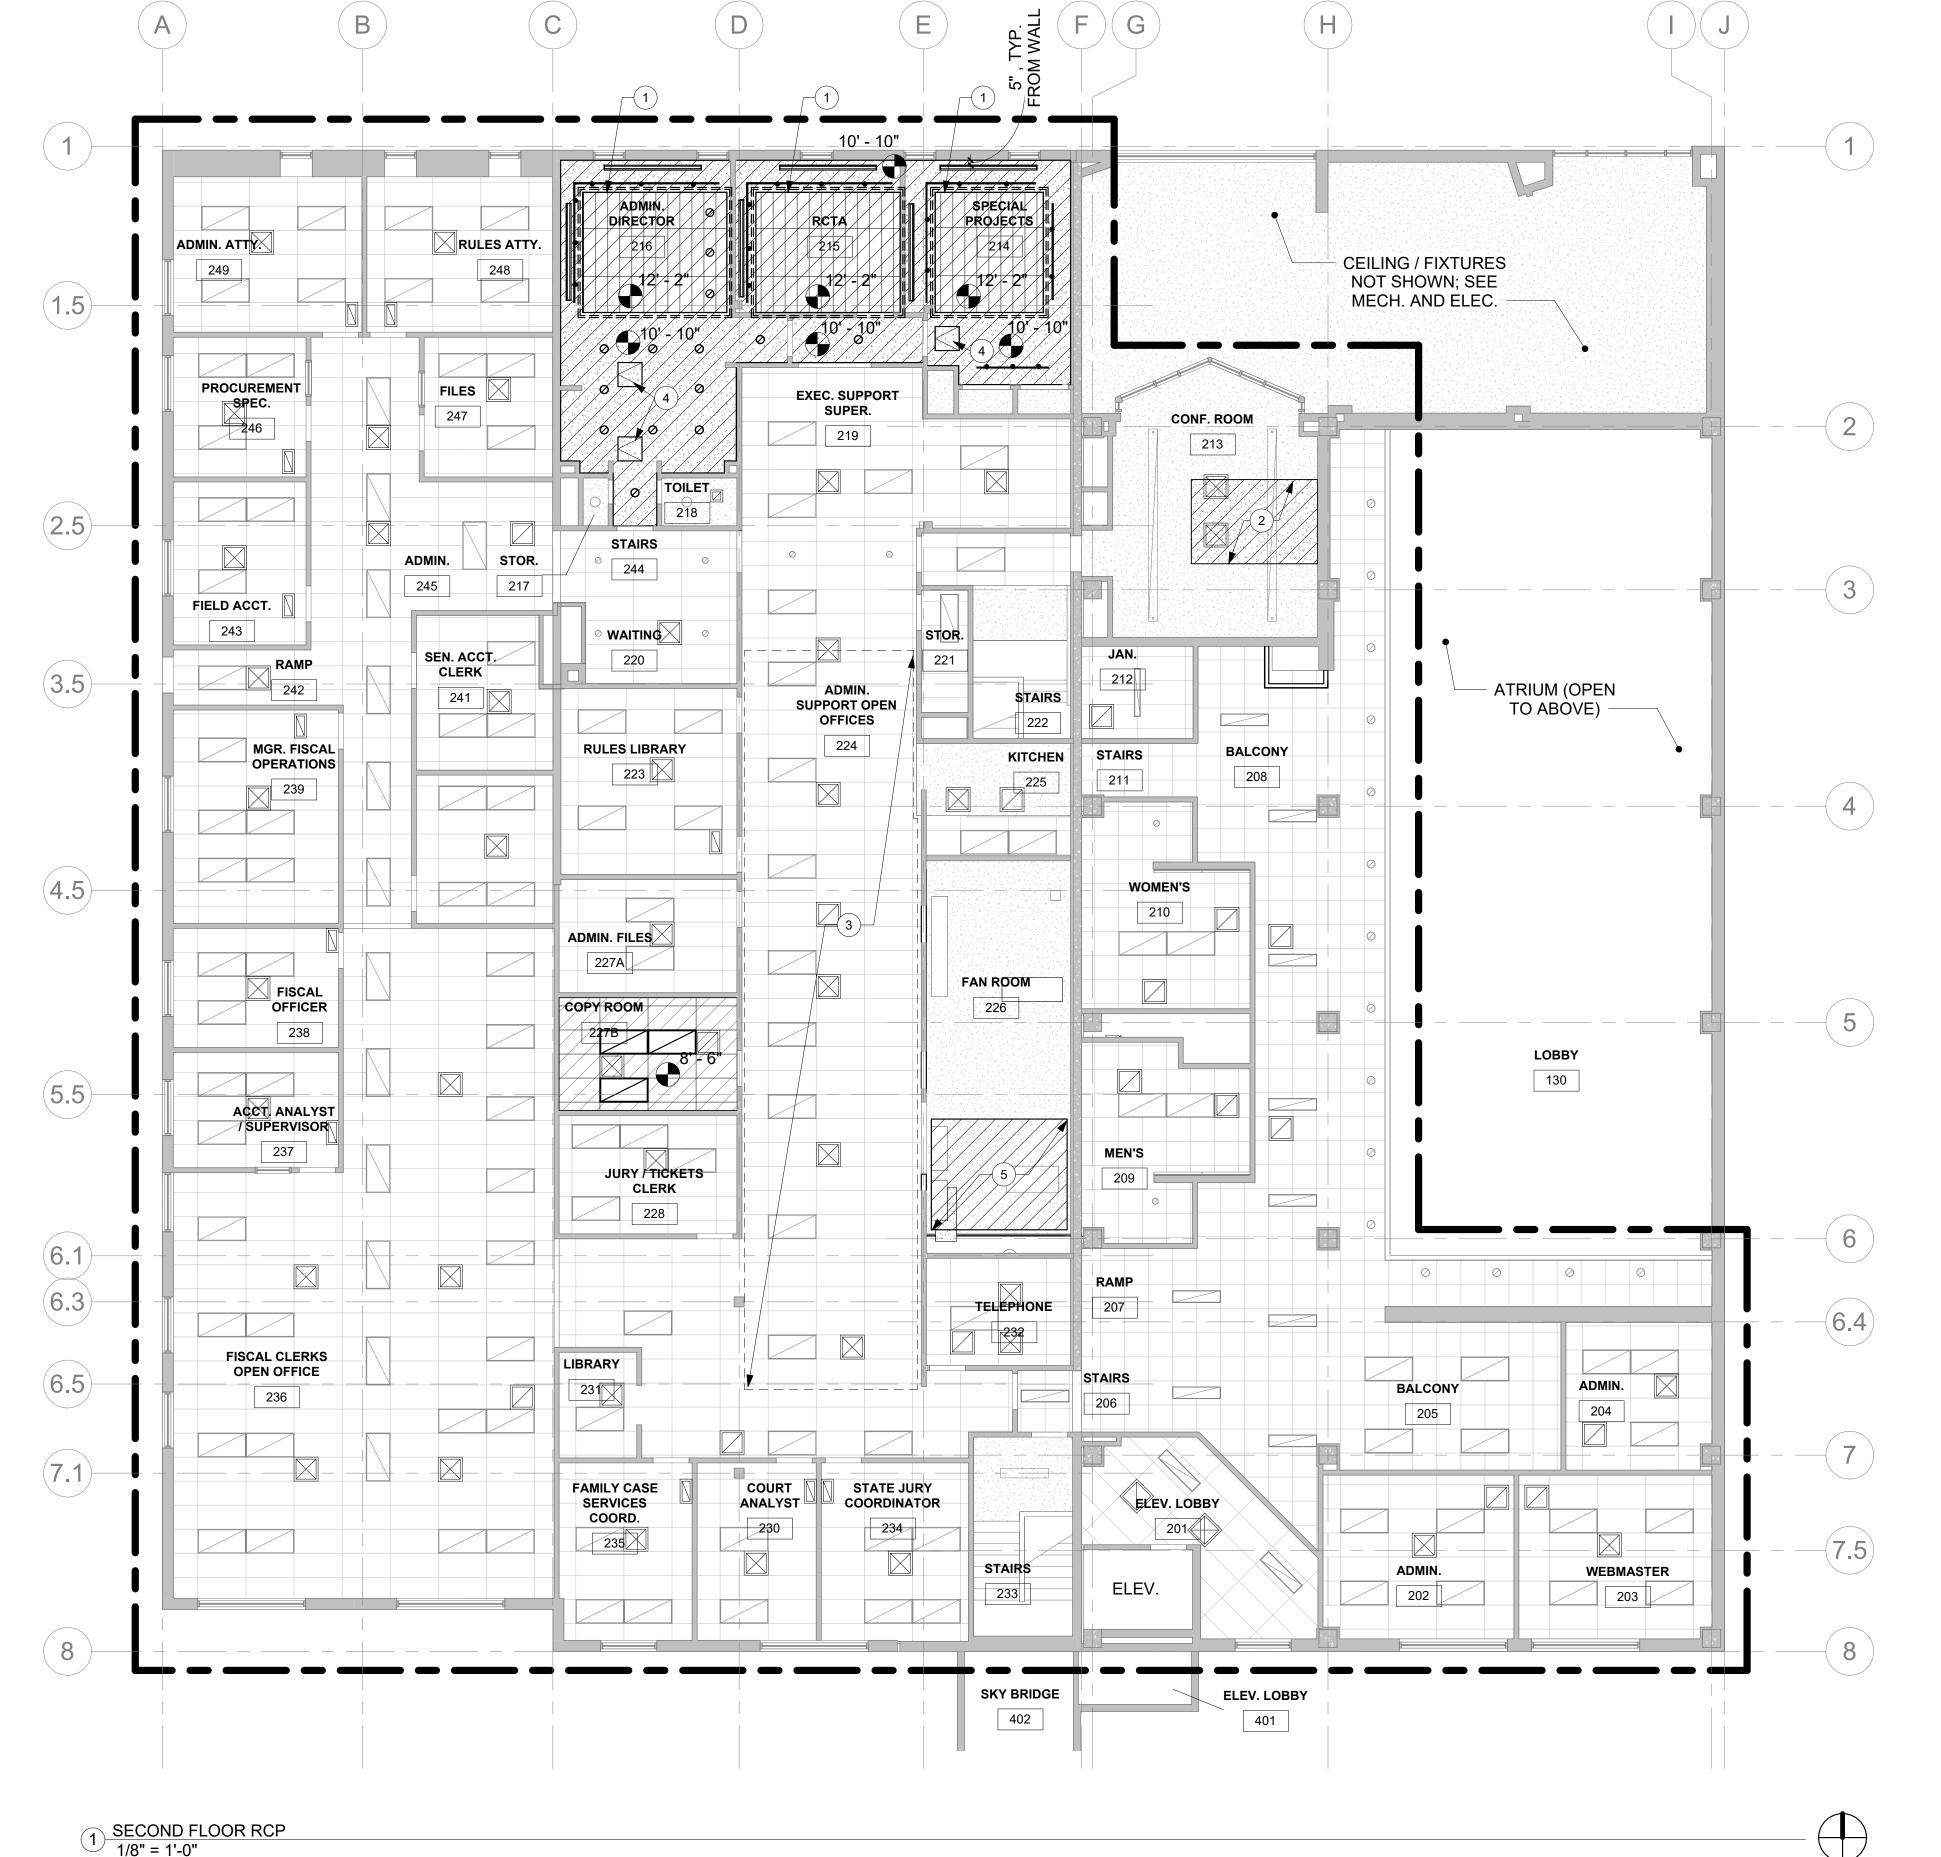
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08/08/2022 Date: Project Phase

PERMIT DRAWINGS

FIRST FLOOR RCP

Sheet Number



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KEYNOTES - SECOND FLOOR RCP

- 1 INSTALL NEW CEILING AROUND EXISTING RECESS/COVE STRUCTURE. INSTALL NEW LIGHTING IN COVER PER ELECTRICAL
- 2 PATCH GWB CEILING WHERE DEMOLISHED; MATCH AND FEATHER INTO SURROUNDING TEXTURE; PAINT ENTIRE CEILING
- INSTALL GWB ON UNDERSIDE OF JOISTS WHERE DEMOLISHED FOR STRUCTURAL WORK
- INSTALL 24"X24" ACCESS DOOR; PAINT TO MATCH
- SURROUNDING CEILING
- 5 PATCH GWB ON UNDERSIDE OF JOISTS WHERE ASSEMBLY WAS TEMPORARILY REMOVED FOR AHU INSTALLATION

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RCP LEGEND

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C3 - NEW 1'x4' SUSPENDED ACT CEILING

C4(E) - EXISTING GWB CEILING
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C4 - NEW PAINTED GWB CEILING (SUSPENDED UNLESS NOTED OTHERWISE)


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NEW VENTILATION SUPPLY OR RETURN; SIZE AND TYPE VARY - SEE MECHANICAL.

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907.561.5543

ASKA COURT SYSTEM WDEN ADMIN BUILDING CHANICAL UPGRADES

AL, SNO ME

Revisions

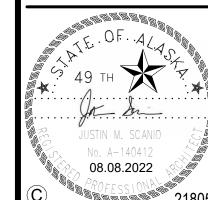No. Date Description

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Designed by: MG
Checked by: BAM
AMC Project: 21805

Date: 08/08/2022
Project Phase

PERMIT DRAWINGS

SECOND FLOOR RCP

G

FACILITIES PLANS ROOM

SPECIAL PROJECTS MGR.

1 THIRD FLOOR RCP 1/8" = 1'-0"

MOA ePlan Stamp

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KEYNOTES - THIRD FLOOR RCP

- 1 INSTALL NEW GWB CEILING ON METAL CHANNELS DIRECTLY TO THE BOTTOM OF EXISTING JOISTS; SEAL AROUND EDGES AND PENETRATIONS FOR SMOKE RESISTANCE
- 2 INSTALL 24X24 ACCESS DOOR; PAINT TO MATCH CEILING; COORDINATE OPENINGS WITH MECHANICAL
- 3 PAINT CURB INFILL STRUCTURE TO MATCH SURROUNDING

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(SUSPENDED UNLESS NOTED OTHERWISE)

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(SUSPENDED UNLESS NOTED OTHERWISE)

C3 - NEW 1'x4' SUSPENDED ACT CEILING

EXISTING LIGHT FIXTURE; SIZE AND TYPE VARY - SEE ELECTRICAL

NEW LIGHT FIXTURE; SIZE AND TYPE VARY - SEE ELECTRICAL.

NEW VENTILATION SUPPLY OR RETURN; SIZE AND TYPE VARY - SEE MECHANICAL.

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701 E. Tudor Rd. Suite 250
Anchorage, AK 99503



21805

ARCHITECTURE DESIGN STRATEGY 3909 ARCTIC BLVD., STE 100 ANCHORAGE, AK 99503 907.561.5543

ASKA COURT SYSTEM WDEN ADMIN BUILDING CHANICAL UPGRADES

AL.

Revisions
No. Date Description

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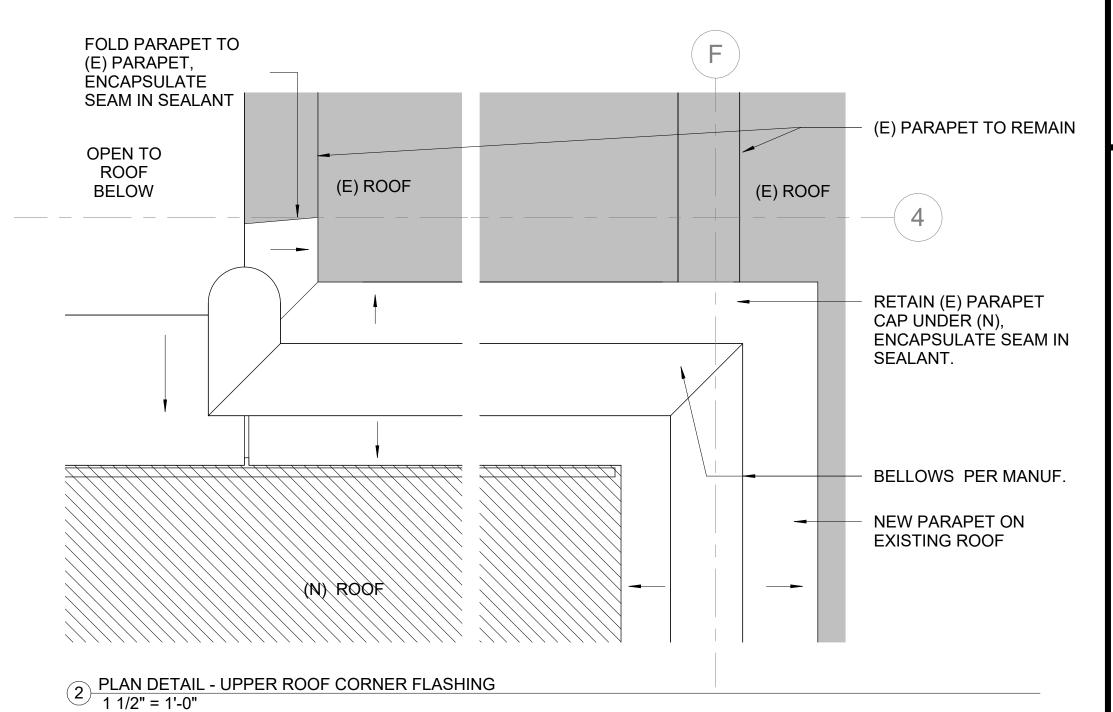
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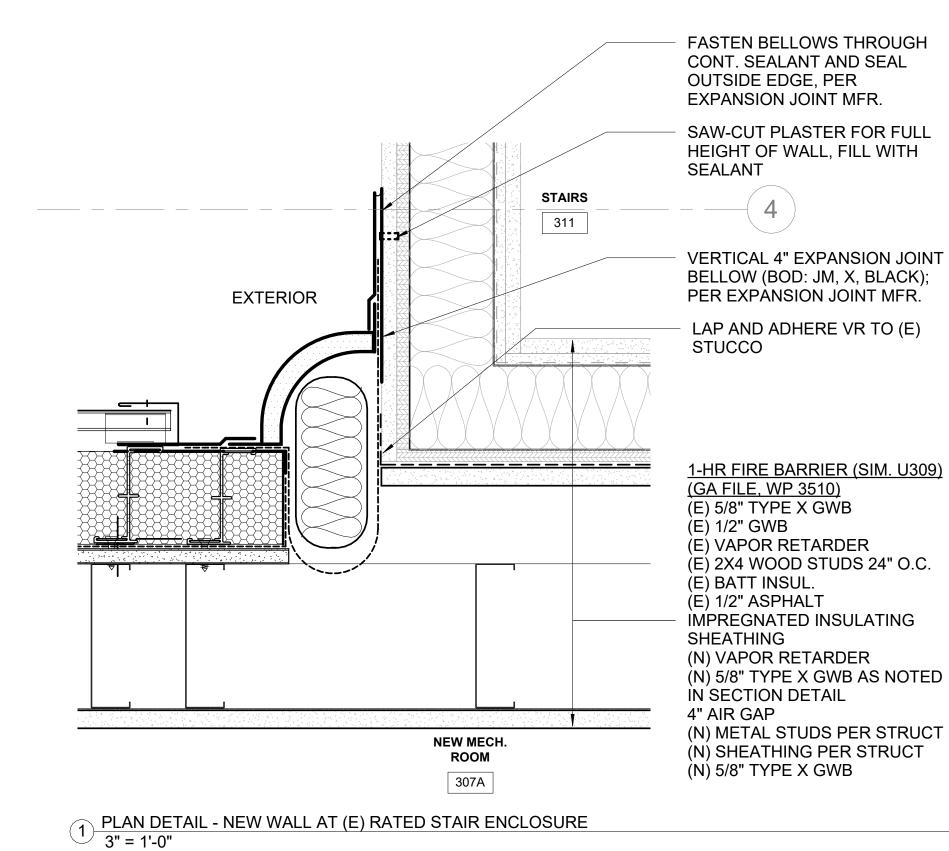
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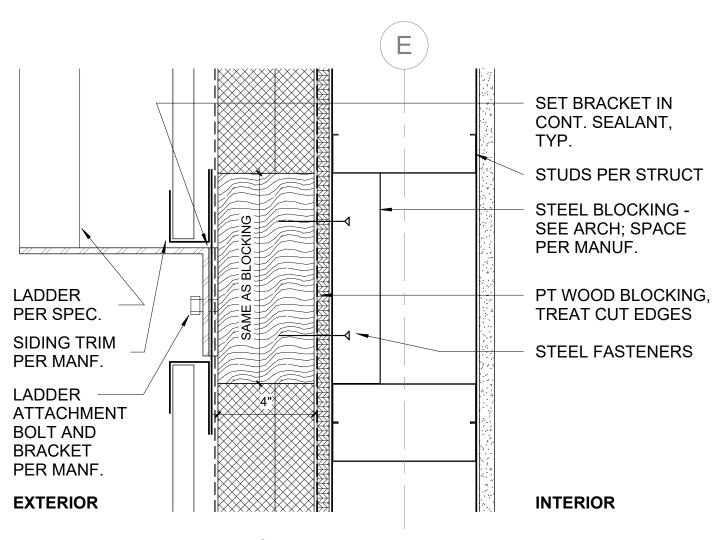
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THIRD FLOOR RCP

Sheet Number


ASBESTOS, LEAD, AND OTHER HAZARDOUS MATERIALS ARE PRESENT IN THE BUILDING AND MAY IMPACT THE WORK OF ALL TRADES. REGULATED AIR CONTAMINANTS, INCLUDING ASBESTOS AND LEAD, ARE ALSO PRESENT IN SETTLED AND CONCEALED DUST IN AND ON ARCHITECTURAL, STRUCTURAL, MECHANICAL, AND ELECTRICAL COMPONENTS OR SYSTEMS THROUGHOUT THE BUILDING. ALL TRADES SHALL COORDINATE WITH OTHER TRADES AND CONDUCT THEIR WORK TO PREVENT WORKER EXPOSURE OR SITE CONTAMINATION. REFER TO SPECIFICATION DIVISIONS 0, 1, AND 2 FOR SPECIFIC INFORMATION CONCERNING DISTURBING, REMOVING, AND DISPOSING OF THESE MATERIALS AND THE INSTALLATION OF THE NEW MATERIALS OR COMPONENTS. THIS NOTIFICATION IS PROVIDED IN ACCORDANCE WITH EPA AND OSHA REQUIREMENTS.







4 PLAN DETAIL - LADDER ATTACHMENT 3" = 1'-0"

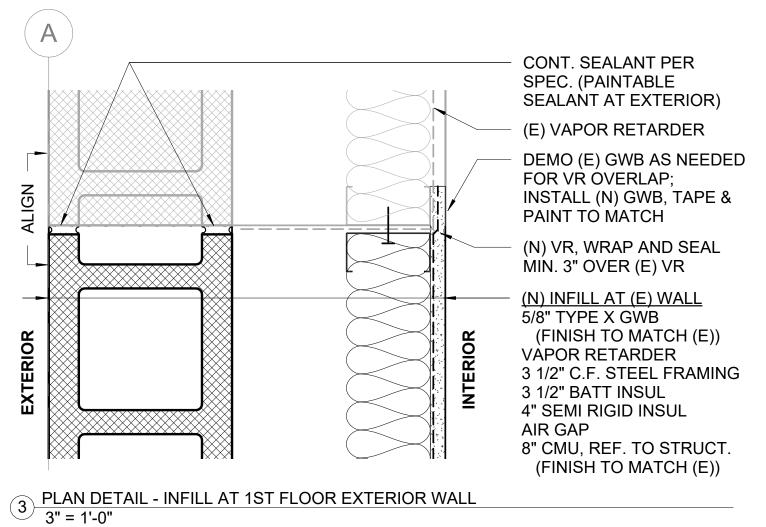

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ASKA COURT SYSTEM
WDEN ADMIN BUILDING
CHANICAL UPGRADES

Revisions

No. Date Description

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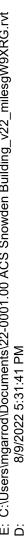
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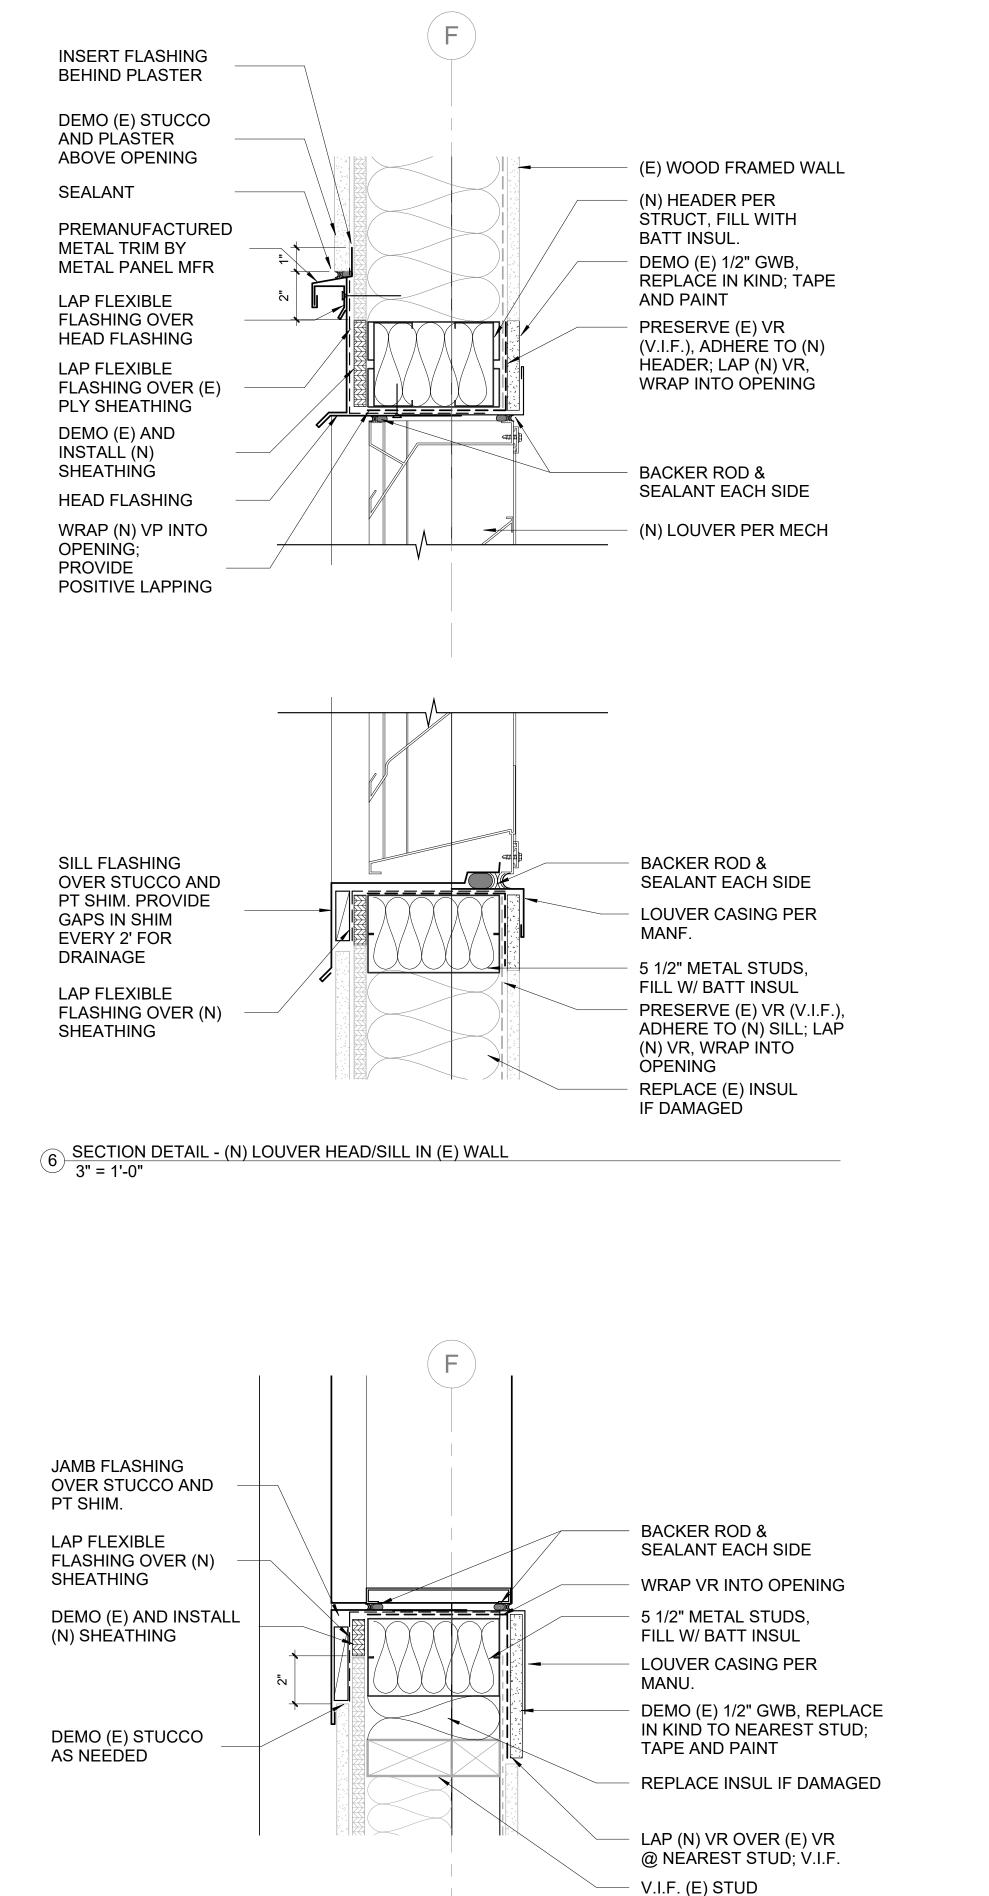
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Project Phase
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Sheet Title
EXTERIOR DETAILS PLAN

Sheet Number






LOCATION

5 PLAN DETAIL - (N) LOUVER JAMB IN (E) WALL 3" = 1'-0"

MOA ePlan Stamp

NOTIFICATION OF POTENTIAL HAZARDS

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2 PLAN DETAIL - NEW LOUVER JAMB 3" = 1'-0"

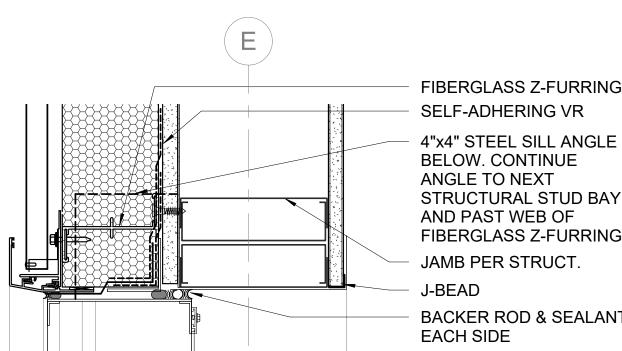FIBERGLASS Z-FURRING

2-1/2"x3" x2" HIGH STEEL

METAL DOOR ANCHOR

BENT MTL. DOOR TRIM

BACKER ROD & SEALANT

METAL DOOR AND FRAME

VERTICAL FIBERGLASS

SELF-ADHERING VAPOR

Z-FURRING BEYOND

STANDOFF CLIP PER

METAL SIDING MANF.

HEADER PER STRUCT

2-1/2"x3" x2" HIGH STEEL

METAL DOOR ANCHOR

BENT MTL. DOOR TRIM

BACKER ROD & SEALANT

ANGLE AT EACH HOLLOW

RETARDER

J-BEAD

EACH SIDE

WEATHERSTRIP

INSULATED HOLLOW

AUTO DOOR BOTTOM

STAINLESS STEEL

BED OF SEALANT

SILL PER STRUCT

SEALANT

METAL

METAL DOOR AND FRAME

THRESHOLD SET IN CONT.

WRAP VAPOR BARRIER, LIQUIFLASH SILL, TYP.

4"X4"X1/4" STEEL ANGLE

COUNTERFLASHING

INSULATION. MATCH

ROOF INSUL. TYPE.

5" THICK RIGID

INSULATED HOLLOW

J-BEAD

4 PLAN DETAIL - TYP. EXT. DOOR JAMB 3" = 1'-0"

3 SECTION DETAIL - TYP. EXT. DOOR HEAD/SILL 3" = 1'-0"

3" = 1'-0"


EACH SIDE

GASKETING


ANGLE AT EACH HOLLOW

SELF-ADHERING VR

JAMB PER STRUCT.

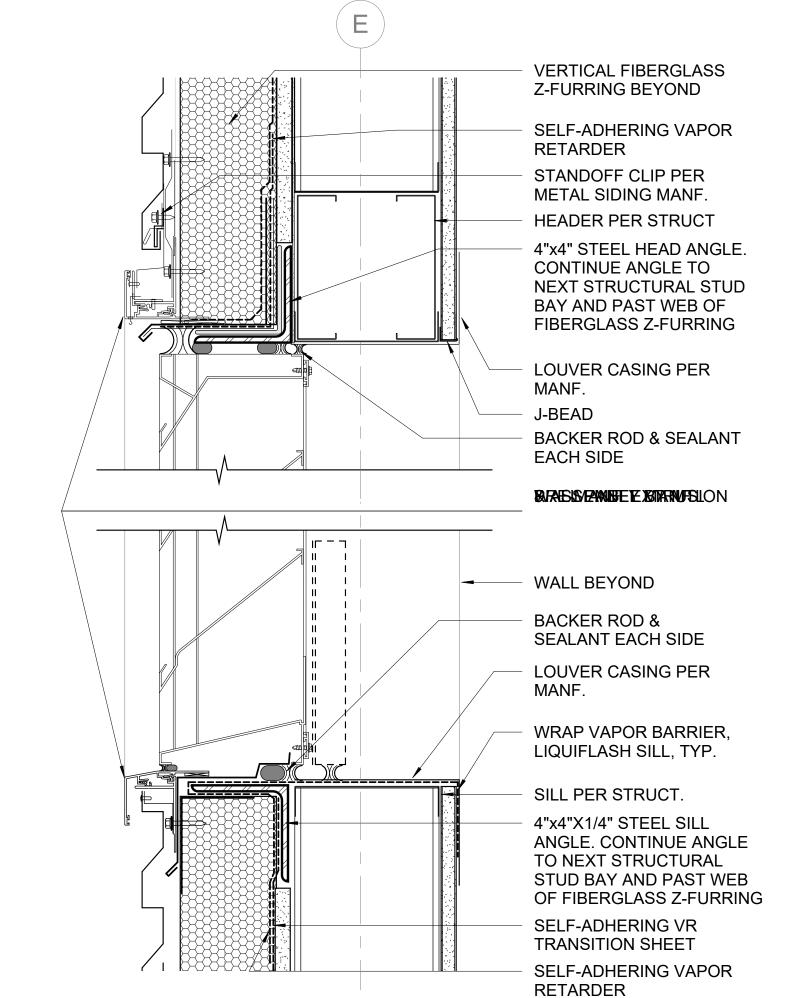

1 SECTION DETAIL - NEW LOUVER HEAD/SILL 3" = 1'-0"

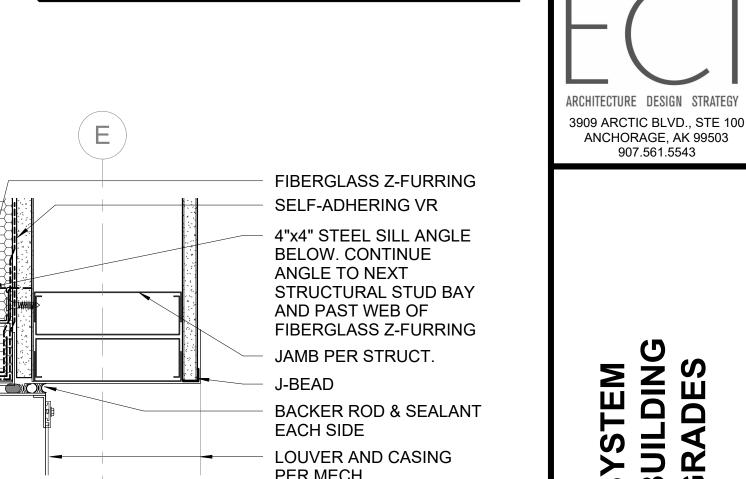

PER MECH.

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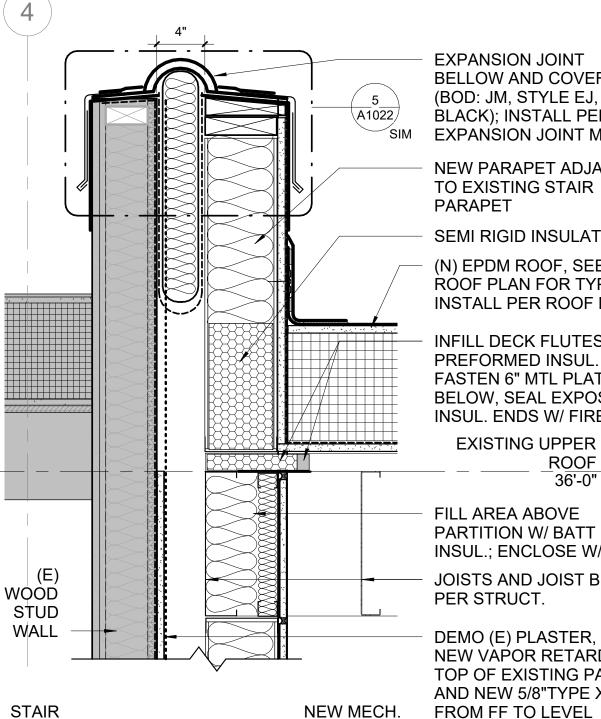
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Project Phase PERMIT DRAWINGS

Sheet Title EXTERIOR DETAILS -OPENINGS

Sheet Number A1012

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BELLOW AND COVER (BOD: JM, STYLE EJ, BLACK); INSTALL PER EXPANSION JOINT MFR. **NEW PARAPET ADJACENT**

SEMI RIGID INSULATION.

(N) EPDM ROOF, SEE **ROOF PLAN FOR TYPE;** INSTALL PER ROOF MFR.

INFILL DECK FLUTES W/ PREFORMED INSUL. FILL; FASTEN 6" MTL PLATE BELOW, SEAL EXPOSED INSUL. ENDS W/ FIRESTOP


EXISTING UPPER

FILL AREA ABOVE PARTITION W/ BATT INSUL.; ENCLOSE W/ GWB

JOISTS AND JOIST BLKG


DEMO (E) PLASTER, INSTALL NEW VAPOR RETARDER TO TOP OF EXISTING PARAPET AND NEW 5/8"TYPE X GWB FROM FF TO LEVEL INDICATED


2 SECTION DETAIL - PARAPET AT (E) STAIR AND (N) MECH RM 1 1/2" = 1'-0"

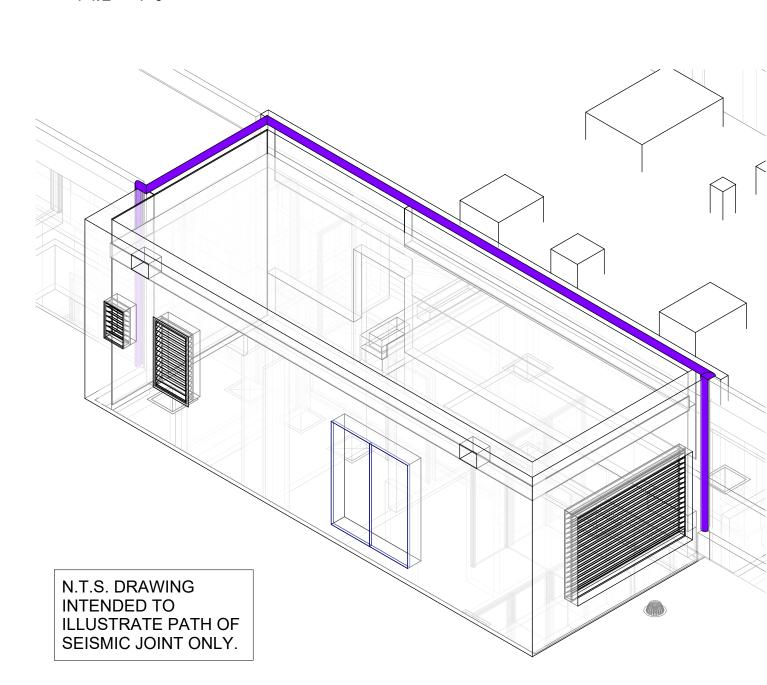

ROOM 307A

1 ISOMETRIC ILLUSTRATING EXPANSION JOINT

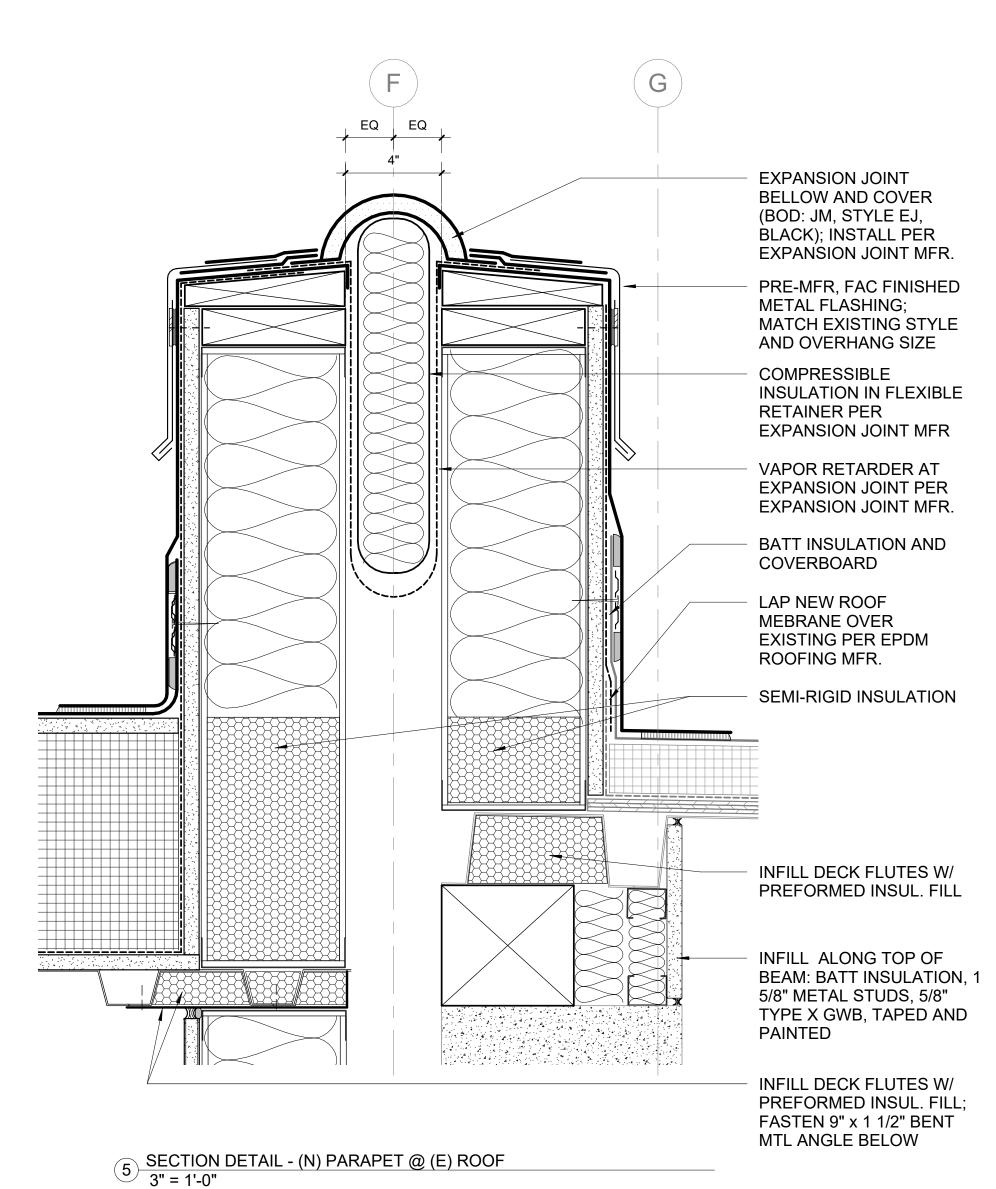

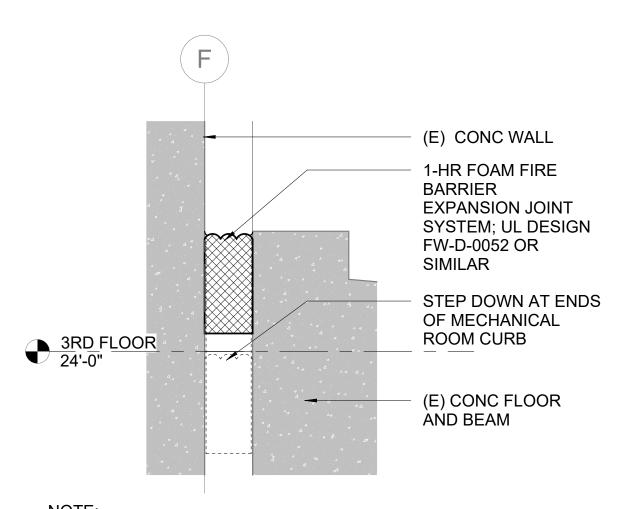

1. INSTALL PER LISTING AND MANUFACTURER INSTRUCTIONS. 2. AT ENDS, FIT SNUG AGAINST EXISTING BATT FILLER.

FIRESTOP JOINT SYSTEM AT (E) SLAB
3" = 1'-0"

3 NEW INT. WALL SECTION 1 1/2" = 1'-0"

NEW MECH. ROOM

307A

G

. MECH. ROOM

307

A1022

EXPANSION JOINT

BELLOW AND COVER

BLACK); INSTALL PER

EXPANSION JOINT MFR.

DOTTED DASHED LINES

WOOD STUD WALL AND

INDICATE DEMO OF (E)

PORTION OF ROOF

SEE STRUCT.

(E) CONC BEAM

(N) 4" FIRE-RATED

(N) 5/8" TYPE X GWB,

BOLT (N) BASE PLATE

TO (E) WALL PER

(E) CONC BLOCK

AS NEEDED

DEMO (E) FURRING

(E) CIP CONC WALL

(N) 2" FIRE-RATED

JOINT MFR.

ÈXPANSION JOINT AND

COVER PER EXPANSION

STRUCT

TAPE AND PAINT

EXPANSION JOINT PER

EXPANSION JOINT MFR.

INSULATION/COVER

BOARD; SEE STRUCT.

(BOD: JM, STYLE EJ,

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> YSTEM UILDING RADES SBB

SOL WDE AL.

Description

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Project Phase **PERMIT DRAWINGS**

Sheet Title **EXTERIOR DETAILS EXPANSION JOINTS**

Sheet Number

A1022


ROOF DETAIL NOTES


- ROOF MEMRANE DETAIL CONDITIONS ARE DESCRIBED FOR SCOPING PURPOSES. CONFIRM ACTUAL DETAILS AND PRODUCTS ARE IN ACCORDANCE WITH ROOF MEMBRANE MFR'S APPROVED DETAILS.
- AT ALL TIE-IN CONDITIONS CLEAN AND PREPARE EXISTING MEMBRANE AS REQUIRED IN ROOF MEMBRANE MFR'S APPROVED DETAILS.
- EXISTING ROOFING ASSUMED EPDM. VIF. WHERE ROOF VAPOR BARRIER IS DEMOLISHED, ENSURE POSITIVE LAP AND SEAL BETWEEN (E) AND (N) VAPOR

MOA ePlan Stamp

NOTIFICATION OF POTENTIAL HAZARDS

ASBESTOS, LEAD, AND OTHER HAZARDOUS MATERIALS ARE PRESENT IN THE BUILDING AND MAY IMPACT THE WORK OF ALL TRADES. REGULATED AIR CONTAMINANTS, INCLUDING ASBESTOS AND LEAD, ARE ALSO PRESENT IN SETTLED AND CONCEALED DUST IN AND ON ARCHITECTURAL, STRUCTURAL, MECHANICAL, AND ELECTRICAL COMPONENTS OR SYSTEMS THROUGHOUT THE BUILDING. ALL TRADES SHALL COORDINATE WITH OTHER TRADES AND CONDUCT THEIR WORK TO PREVENT WORKER EXPOSURE OR SITE CONTAMINATION. REFER TO SPECIFICATION DIVISIONS 0, 1, AND 2 FOR SPECIFIC INFORMATION CONCERNING DISTURBING, REMOVING, AND DISPOSING OF THESE MATERIALS AND THE INSTALLATION OF THE NEW MATERIALS OR COMPONENTS. THIS NOTIFICATION IS PROVIDED IN ACCORDANCE WITH EPA AND OSHA REQUIREMENTS.

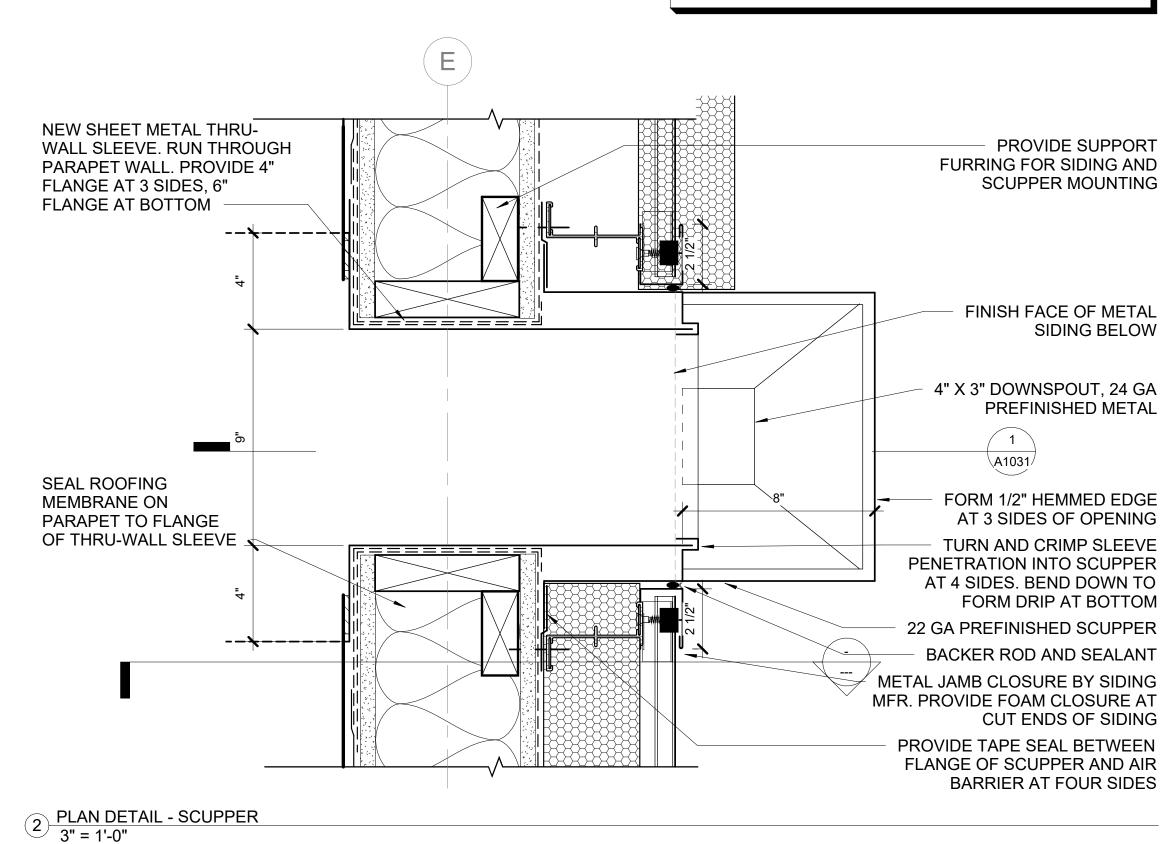

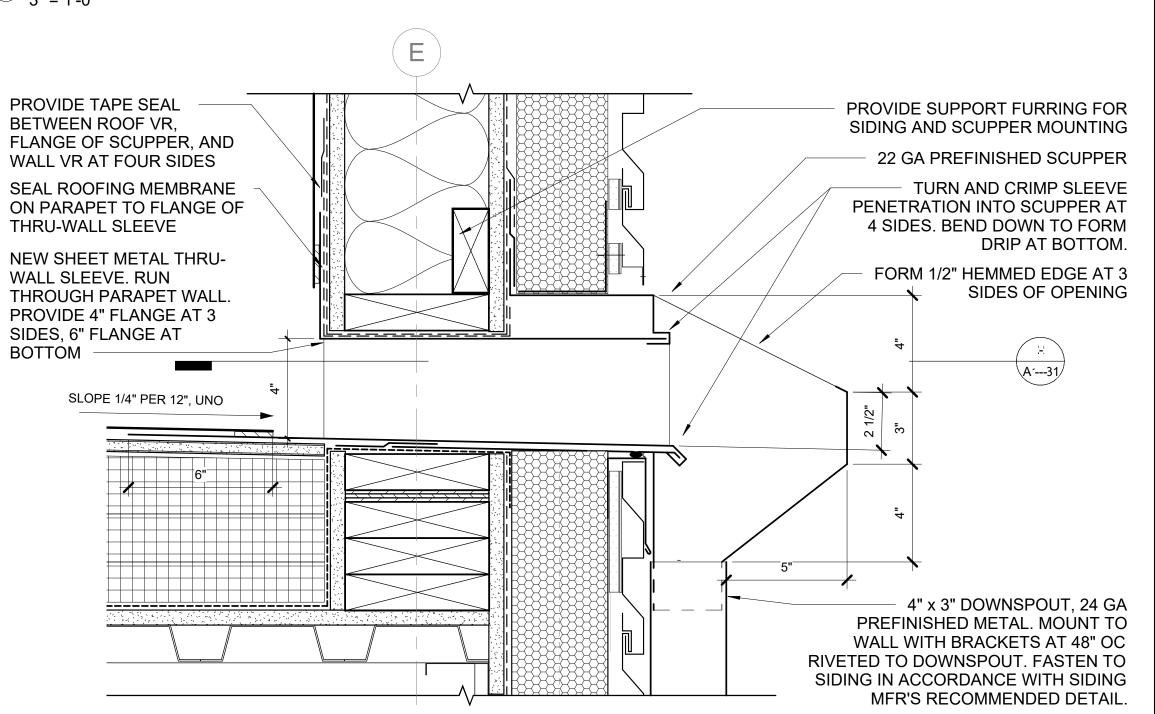

1 SECTION DETAIL - SCUPPER 3" = 1'-0"







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YSTEM UILDING RADES SBB ŌQ, WD CH AL NO ME

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Project Phase **PERMIT DRAWINGS**

EXTERIOR DETAILS ROOF

Sheet Number

A1031


2. AT ALL TIE-IN CONDITIONS CLEAN AND PREPARE EXISTING MEMBRANE AS REQUIRED IN ROOF MEMBRANE MFR'S APPROVED DETAILS.

EXISTING ROOFING ASSUMED EPDM, VIF.
 WHERE ROOF VAPOR BARRIER IS DEMOLISHED, ENSURE POSITIVE LAP AND SEAL BETWEEN (E) AND (N) VAPOR


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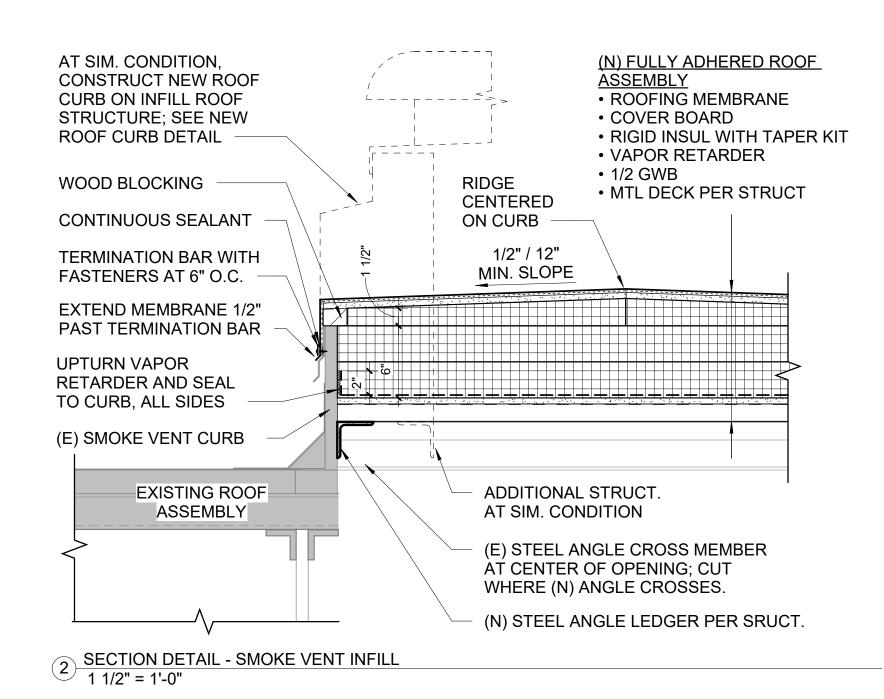
NOTIFICATION OF POTENTIAL HAZARDS


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[/] 1 1/2" = 1'-0"



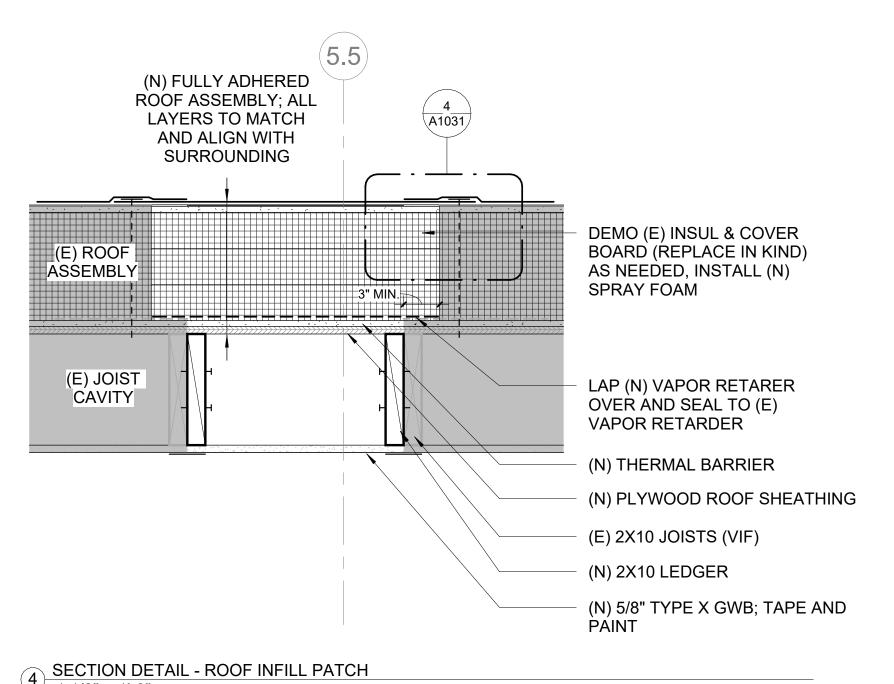

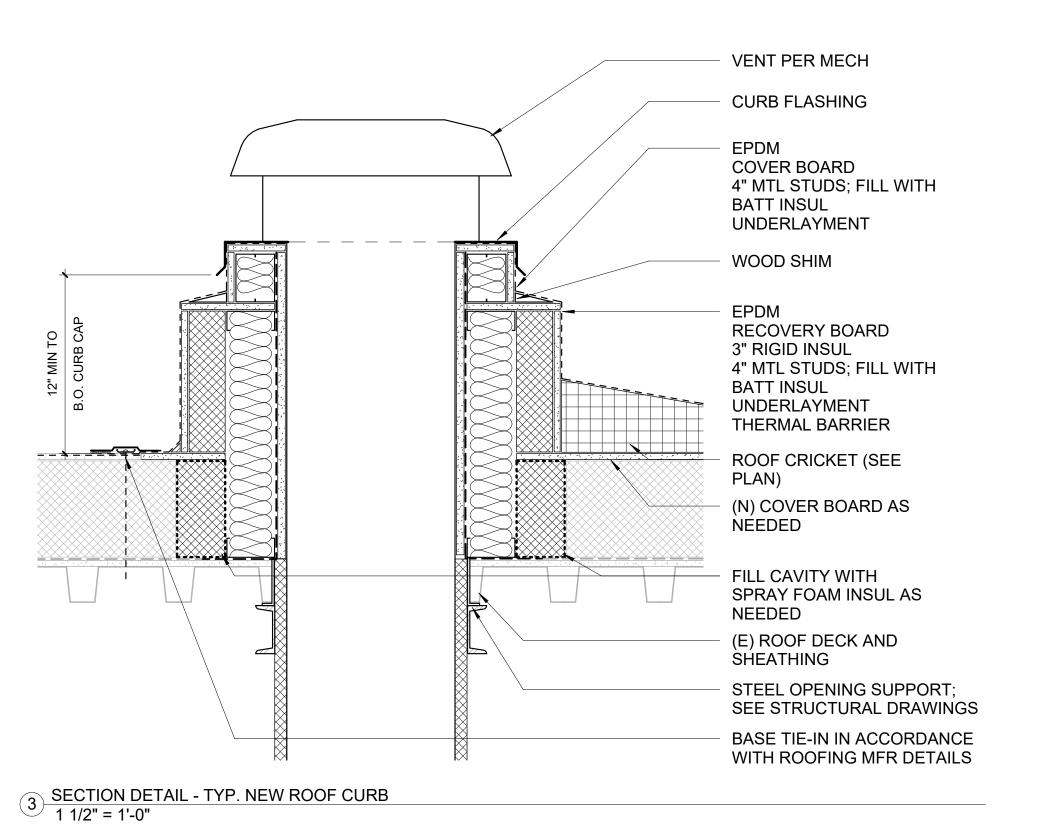

EXISTING STRUCTURE SIM. ALONG GRID C

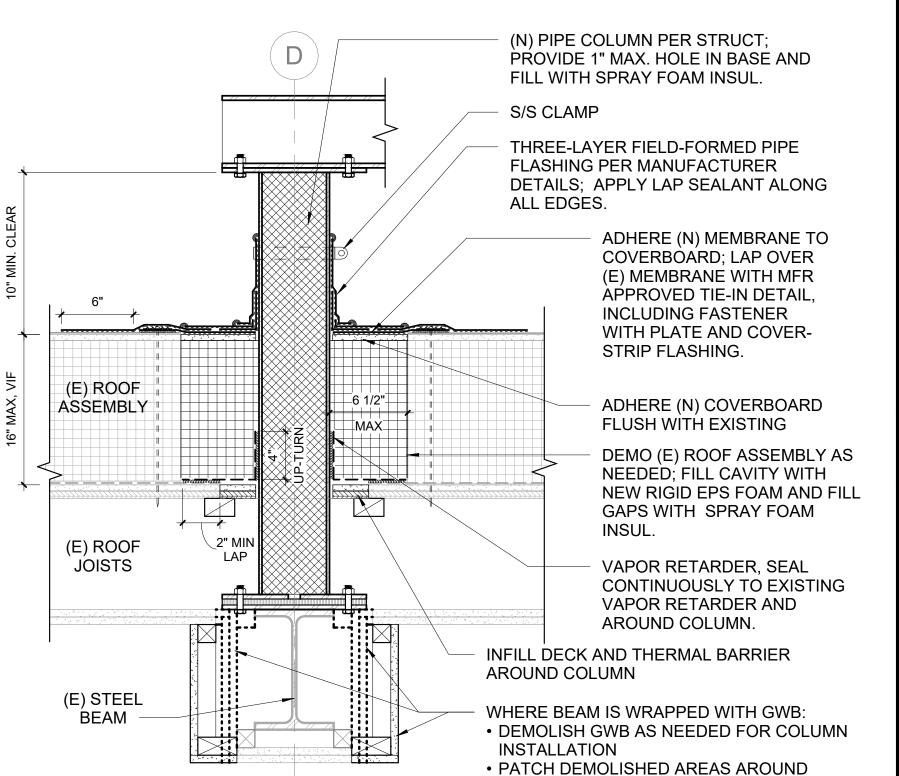1 SECTION DETAIL - TYP. COLUMN PENETRATION 1 1/2" = 1'-0"

NEW STRUCTURE WITH SINGLE 5/8" TYPE

X GWB LAYER.

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No. A-140412
08.08.2022
21805

ARCHITECTURE DESIGN STRATEGY

ARCHITECTURE DESIGN STRATEGY 3909 ARCTIC BLVD., STE 100 ANCHORAGE, AK 99503 907.561.5543

> YSTEM UILDING RADES

ALASKA COURT SYS SNOWDEN ADMIN BUI MECHANICAL UPGRA

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AMC Project: 21805

Date: 08/08/2022

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Project Phase
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Sheet Title
EXTERIOR DETAILS ROOF
PENETRATIONS

Sheet Number

A1032

HARDWARE: EXISTING TO BE REINSTALLED ON NEW DOOR AND EXISTING FRAME.

DOOR 227B

DOOR: ETR.

FRAME: ETR.

HARDWARE: ETR EXCEPT FOR LOCKSET.

a. COORDINATE WITH OWNER REGARDING REQUIRED FUNCTION OF HARDWARE. IF EXISTING HARDWARE FUNCTION NEEDS TO CHANGE, VERIFY IF HARDWARE FROM DEMOLISHED DOORS CAN BE USED.

DOORS 307A & 307B

DOOR: NEW IHM SINGLE DOOR, FLUSH; SEE SPEC.

FRAME: ETR.

HARDWARE a. EXISTING TO BE REINSTALLED ON NEW DOOR AND EXISTING

b. NEW ACOUSTIC GASKETTING AND AUTO DOOR BOTTOMS.

<u>DOOR</u>: NEW IHM DOUBLE DOOR, FLUSH; SEE SPEC.

FRAME: NEW IHM FRAME. 2" PROFILE: SEE SPEC AND DETAILS. HARDWARE: NEW HARDWARE; SEE HW GROUP AND DETAILS.

• 6 EA HEAVY DUTY BUTTS

1 EA AUTO FLUSH BOLT SET

1 EA MORTISE LOCKSET (ACTIVE DOOR)

2 EA HEAVY DUTY CLOSERS WITH INTEGRATED STOP

2 EA KICKPLATES

 8 EA PERIMETER WEATHER STRIP (BRUSH), INTERIOR SIDE 1 EA EXTERIOR SADDLE THRESHOLD

DOOR, FRAME, & HARDWARE INFORMATION

GENERAL DOOR & FRAME INFORMATION:

A. SEE PROJECT MANUAL FOR DOOR & FRAME SPECIFICATIONS.

SEE DETAILS FOR ADDITIONAL INFORMATION.

C. SEE CODE SHEET FOR FIRE RATING OF WALL / PARTITION. IF APPLICABLE, MATCH DOOR / FRAME RATING ACCORDINGLY.

GENERAL HARDWARE INFORMATION: A. ALL HARDWARE TO BE GRADE 1

SEE CODE SHEET FOR FIRE RATING OF WALL / PARTITION. WHERE APPLICABLE, MATCH HARDWARE RATING ACCORDINGLY.

C. ALL HARDWARE, INCLUDING CORES, TO HAVE FINISH

MATCHING EXISTING HARDWARE AS CLOSE AS POSSIBLE; VIF. D. ALL LOCKSETS AND LEVER SETS SHALL HAVE LEVER TYPE HANDLES.

ALL LOCKSETS TO HAVE INTERCHANGEABLE CYLINDERS.

ALL LOCKS SHOULD BE KEYED AND MASTERKEYED INTO THE MASTERKEY SYSTEM. COORDINATE WITH OWNER. PROVIDE KEYS PER LOCK AND ADDITIONAL MASTERKEYS. QUANTITIES TO BE DECIDED BY OWNER. COORDINATE AND VERIFY REKEYING PLAN WITH OWNER.

G. SALVAGE EXISTING HARDWARE FROM DEMOLISHED DOORS TO ALLOW FOR TEMPORARY HARWARE STOCK. DISPOSE OF UNUSED SALVAGED HARDWARE AFTER NEW AND EXISTING HARDWARE IS INSTALLED.

MOA ePlan Stamp

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DOOR & HARDWARE ABBREVIATIONS

ALUMINUM E/EX **EXISTING EXISTING TO REMAIN FLUSH** FAC **FACTORY** FIBERGLASS REINFORCED POLYESTER HOLLOW METAL HW HARDWARE **INSULATED HOLLOW METAL** KD KNOCK DOWN MANUFACTURER MTL METAL NEW PAINT STAINLESS STEEL STL STEEL

WD

WOOD



WD

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C

DOOR AS SCHEDULED

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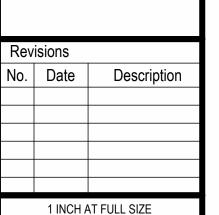
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ARCHITECTURE DESIGN STRATEGY

3909 ARCTIC BLVD., STE 100

ANCHORAGE, AK 99503

907.561.5543




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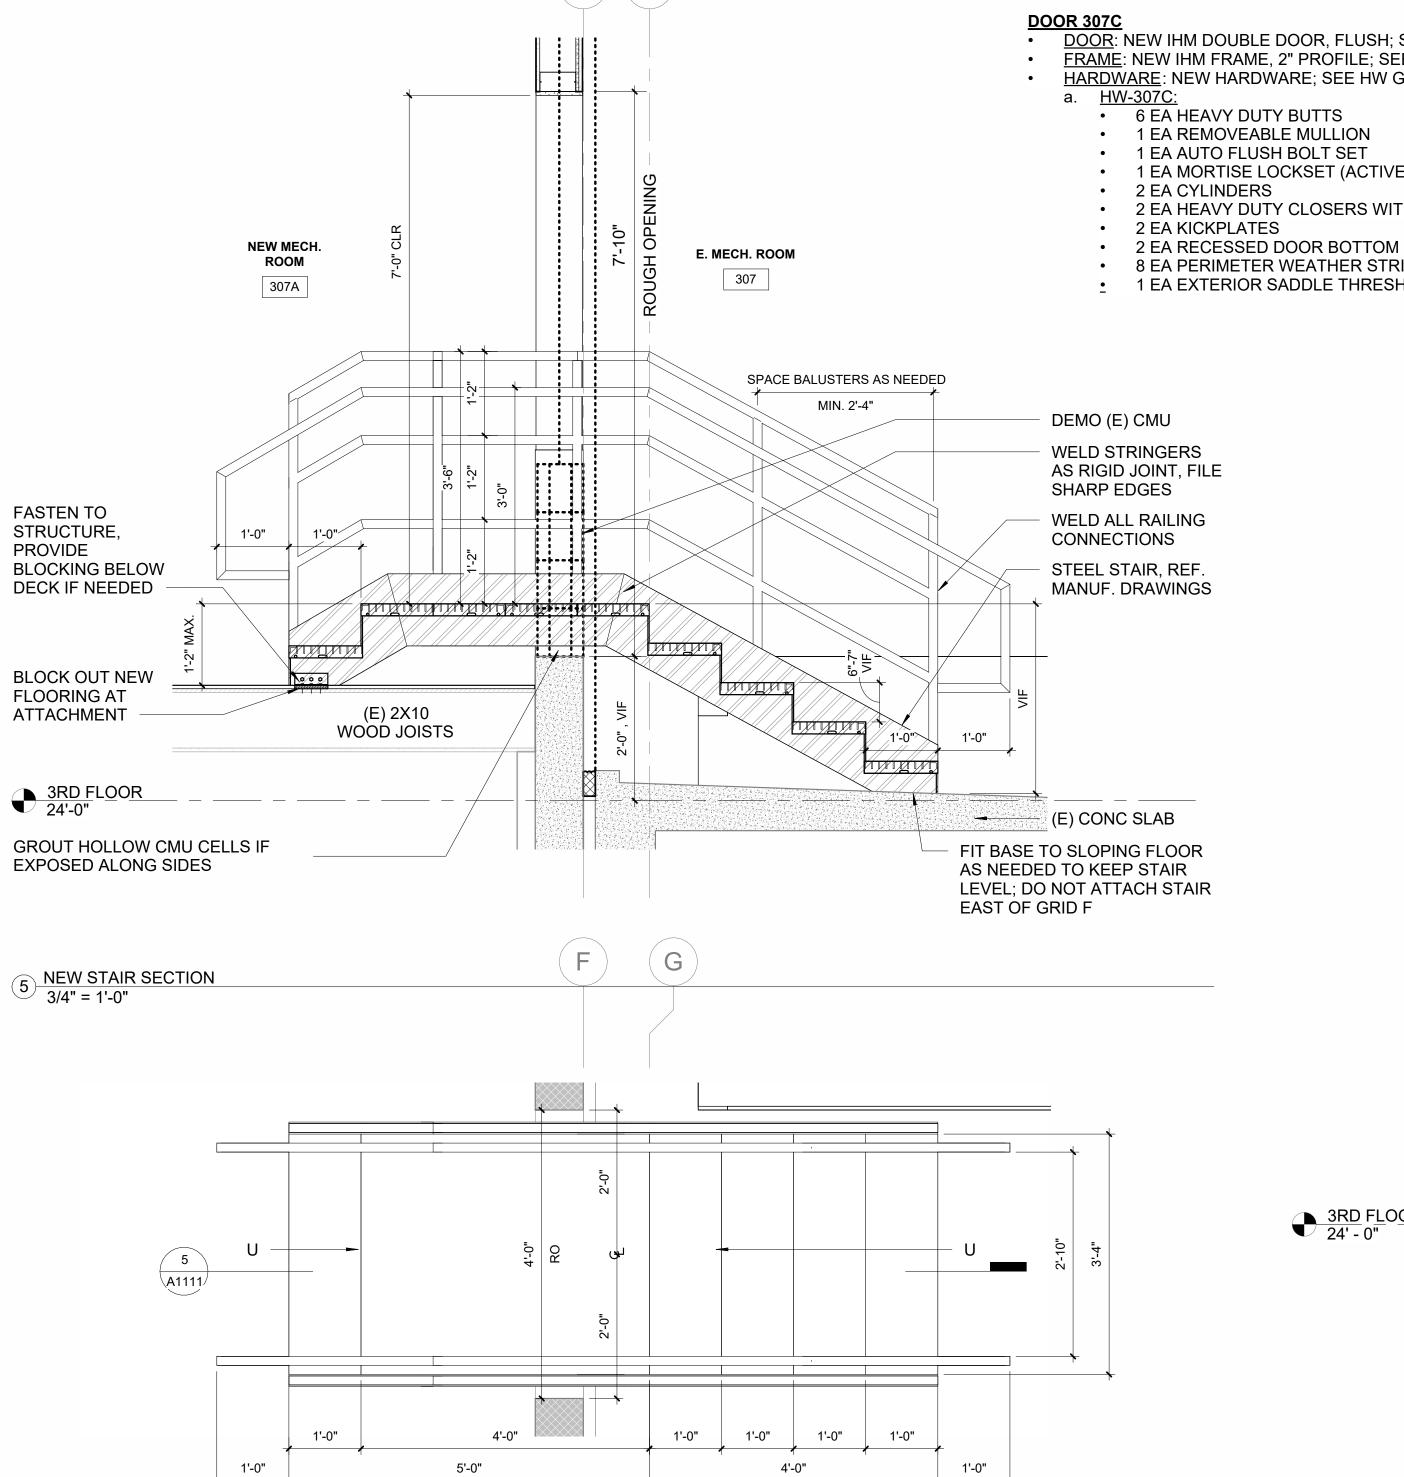
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Project Phase **PERMIT DRAWINGS**

Sheet Title **INTERIOR DETAILS &** DOOR HARDWARE NOTES


Sheet Number A1111



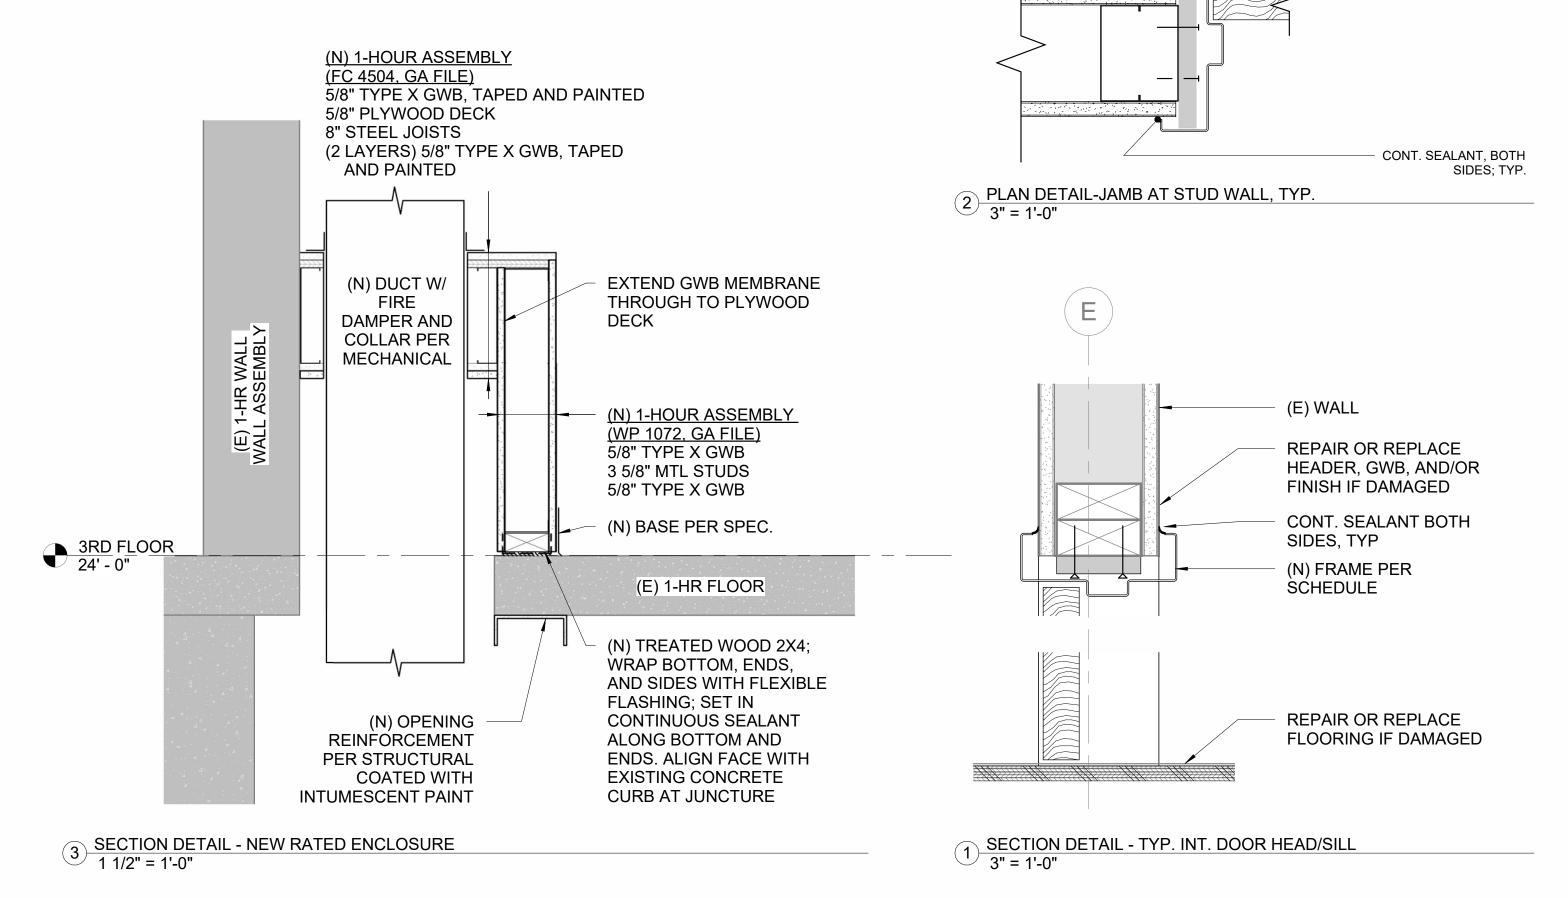

4 ENLARGED STAIR PLAN
3/4" = 1'-0"

G

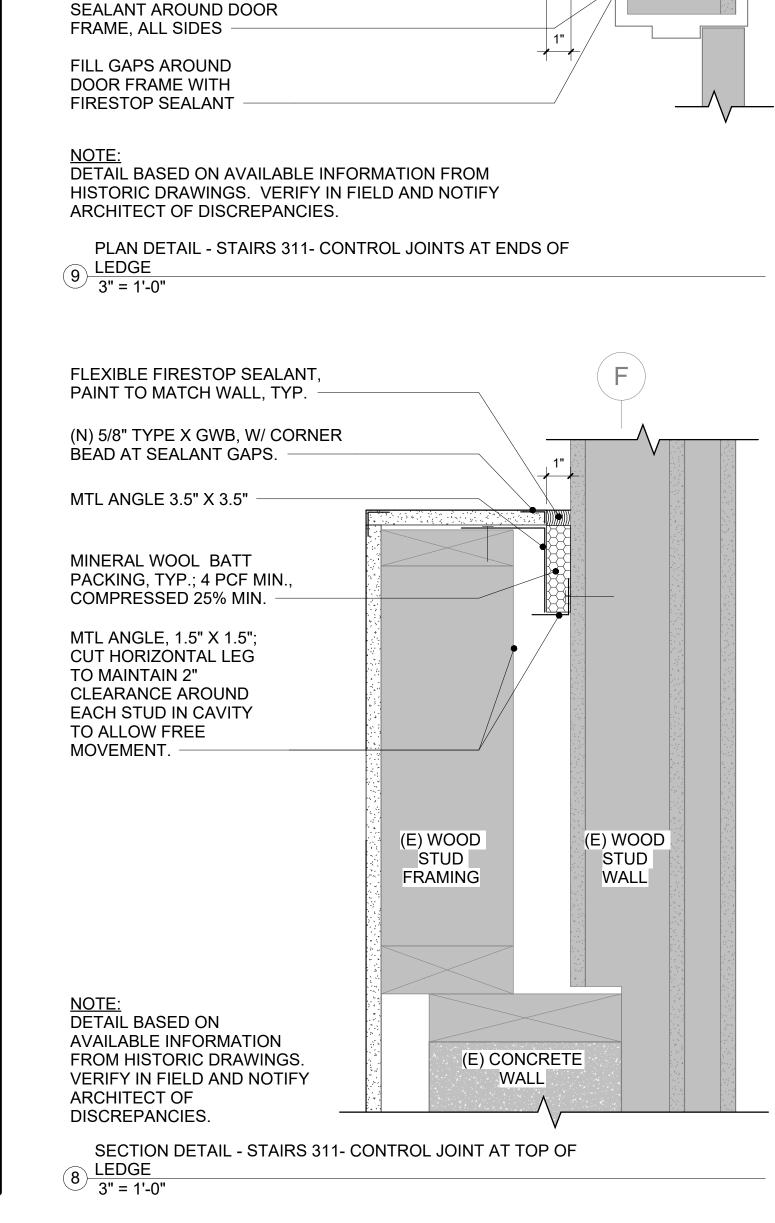

(E) CMU /

CONCRETE

WALL

(E) 1-HR

WALL

IF (E) GWB DOES NOT

W/ 5/8" TYPE X GWB.

FLEXIBLE FIRESTOP

SEALANT, PAINT TO

(N) 5/8" TYPE X GWB, W/

MINERAL WOOL BATT

METAL FURRING TO

FURRING DEPTH, TYP.

ATTACHMENT; FASTEN

ONLY TO DOOR JAMB

FLEXIBLE, PAINTABLE

FRAMING

MATCH EXISTING

FIELD FORMED MTL ANGLE FOR GWB

PACKING, TYP.; 4 PCF MIN.,


COMPRESSED 25% MIN.

MATCH WALL, TYP.


CORNER BEAD AT

SEALANT GAPS.

EXTEND TO WALL, INFILL

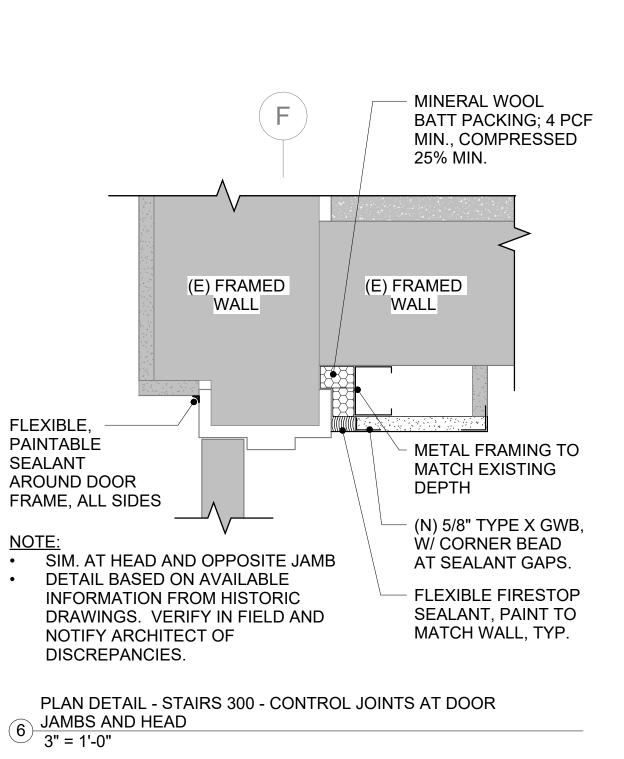



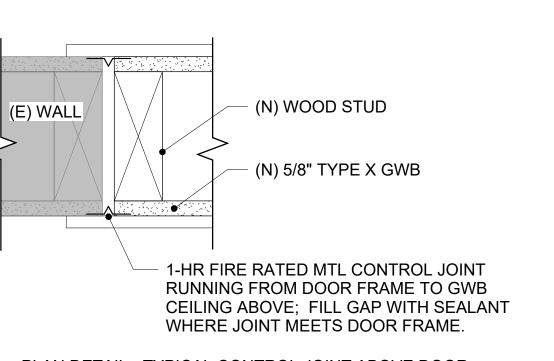

5 PLAN DETAIL - TYPICAL CONTROL JOINT ABOVE DOOR 3" = 1'-0"


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G

CORR.

313



(N) CONTROL

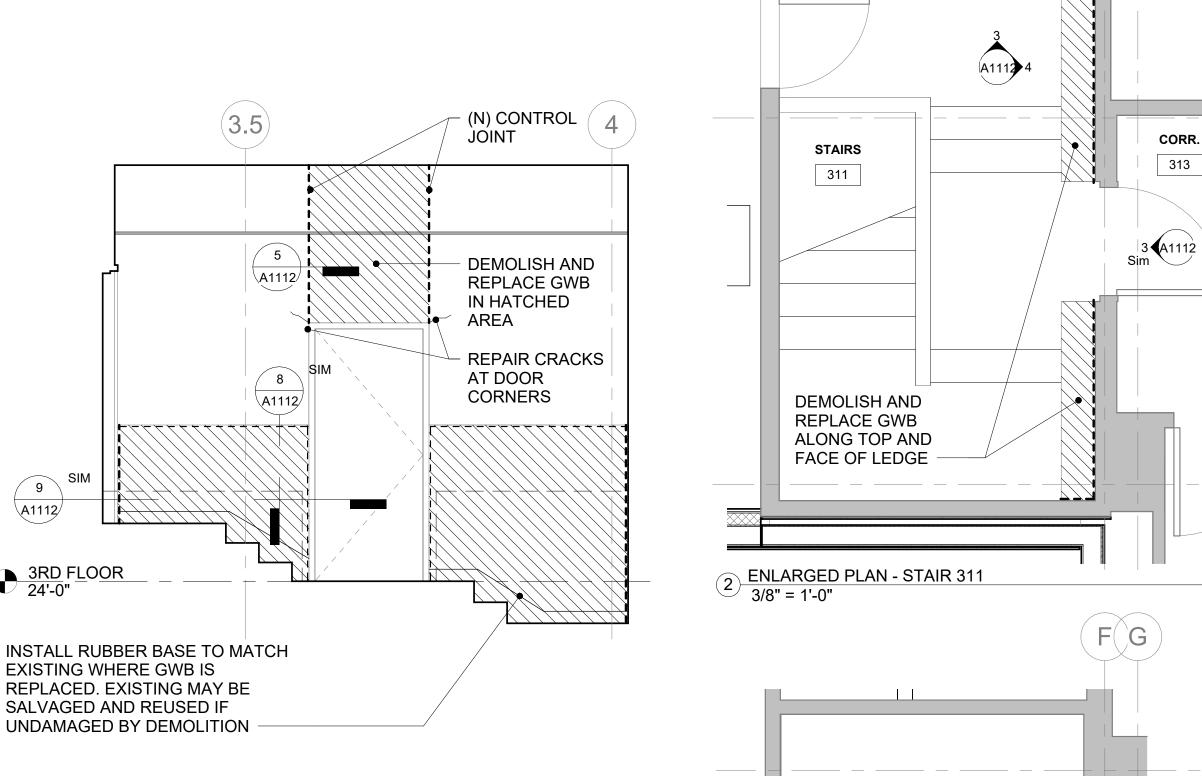JOINTS BOTH

SIDES OF WALL

DEMOLISH AND

REPLACE GWB

SIDES OF WALL

REPAIR CRACKS

IN HATCHED

AREA BOTH

AT DOOR

CORNERS

3.5

3RD FLOOR 24'-0"

REMOVE AND

NEEDED FOR

CONTROL JOINT

INSTALLATION

REINSTALL

CEILING AS

EXISTING WHERE GWB IS

SALVAGED AND REUSED IF


REPLACED. EXISTING MAY BE

UNDAMAGED BY DEMOLITION


4 INTERIOR ELEVATION - STAIRS 311 - EAST 3/8" = 1'-0"

3 INTERIOR ELEVATION - STAIRS 311 - NORTH 3/8" = 1'-0"

\A1112

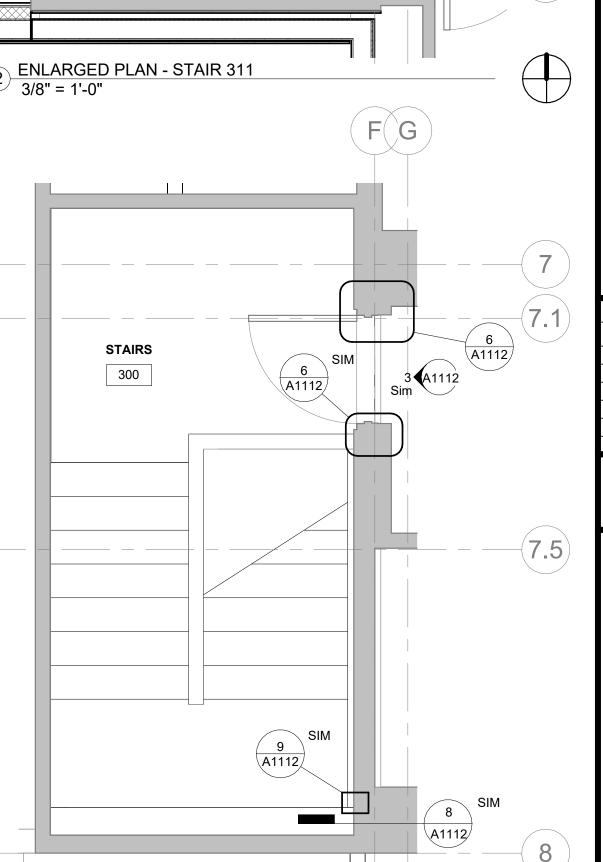

1 ENLARGED PLAN - STAIR 300 3/8" = 1'-0"

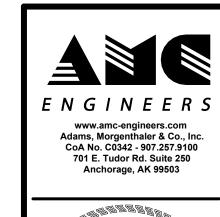



ARCHITECTURE DESIGN STRATEGY 3909 ARCTIC BLVD., STE 100 ANCHORAGE, AK 99503

907.561.5543

YSTEM UILDING RADES S E DMIN CHANIC AL. NO ME

Description

1 INCH AT FULL SIZE IF NOT 1 INCH, SCALE ACCORDINGLY

Designed by: Checked by: 21805 AMC Project: 08/08/2022 Date:

Project Phase **PERMIT DRAWINGS**

Sheet Title INTERIOR DETAILS -STAIRWAY CONTROL JOINTS

Sheet Number

SHEET INDEX

L1.0 SITE & LANDSCAPE PLAN L2.0 SITE PLAN DETAILS

L2.0 SITE PLAN DETAILS L2.1 SITE PLAN DETAILS

LOCATION MAP



MOA ePlans Stamp

NOTIFICATION OF POTENTIAL HAZARDS

ASBESTOS, LEAD, AND OTHER HAZARDOUS MATERIALS ARE PRESENT IN THE BUILDING AND MAY IMPACT THE WORK OF ALL TRADES. REGULATED AIR CONTAMINANTS, INCLUDING ASBESTOS AND LEAD, ARE ALSO PRESENT IN SETTLED AND CONCEALED DUST IN AND ON ARCHITECTURAL, STRUCTURAL, MECHANICAL, AND ELECTRICAL COMPONENTS OR SYSTEMS THROUGHOUT THE BUILDING. ALL TRADES SHALL COORDINATE WITH OTHER TRADES AND CONDUCT THEIR WORK TO PREVENT WORKER EXPOSURE OR SITE CONTAMINATION. REFER TO SPECIFICATION DIVISIONS 0, 1, AND 2 FOR SPECIFIC INFORMATION CONCERNING DISTURBING, REMOVING, AND DISPOSING OF THESE MATERIALS AND THE INSTALLATION OF THE NEW MATERIALS OR COMPONENTS. THIS NOTIFICATION IS PROVIDED IN ACCORDANCE WITH FPA AND OSHA REQUIREMENTS.



LANDSCAPE SCHEDULE


QTY	SYMBOL	SCIENTIFIC NAME	COMMON NAME	SIZE
1	ВРМ	BETUALA PAPYRIFERA (MULTI-STEM)	WHITE PAPER BIRCH MULTI-STEM	2" CAL.
6		SPIREA BETULIFOLIA 'TOR'	TOR BIRCHLEAF SPIREA	18" HT.
6	⊙ SJ	SPIREA JAPONICA 'ANTHONY WATERER'	ANTHONY WATERER SPIREA	24" HT.

SITE AND LANDSCAPE NOTES

- 1. ALL PLANT MATERIAL SHALL CONFORM TO AMERICAN STANDARD FOR NURSERY STOCK, ANSI Z60.1 (LATEST EDITION).
- 2. ALL WORK SHALL BE IN ACCORDANCE WITH MUNICIPALITY OF ANCHORAGE STANDARD SPECIFICATIONS (M.A.S.S.) UNLESS NOTED DIFFERENTLY ON SHEET NOTES OR IN SPECIAL PROVISIONS.
- 3. CONTRACTOR SHALL CALL LOCAL DIG LINE TO VERIFY UNDERGROUND UTILITY LOCATIONS PRIOR TO DIGGING. CONTRACTOR IS RESPONSIBLE FOR ANY UNDERGROUND UTILITY DAMAGE.
- 4. THE CONTRACTOR SHALL HAVE ADEQUATE STORAGE SPACE FOR PLANT MATERIAL PRIOR TO THE SITE BEING READY FOR INSTALLATION. PLANT MATERIAL SHALL BE MAINTAINED AND WATERED THOROUGHLY PRIOR TO INSTALL.
- 5. NOTIFY THE OWNER'S REPRESENTATIVE FOR INSPECTION OF ALL TREES, SHRUBS, AND PERENNIALS PRIOR TO BRINGING MATERIAL TO THE PROJECT SITE. ANY PLANT MATERIAL SHOWING SIGNS OF DAMAGE, DISEASE, SCARRING, OVER-PRUNING, OR NOT MEETING THE ANSI Z60.1 STANDARDS SHALL BE REJECTED AND REPLACED AT NO COST TO THE OWNER. ANY SUBSTITUTIONS MUST BE APPROVED BY OWNER'S REPRESENTATIVE.
- 6. ALL TREES AND SHRUBS MUST HAVE NURSERY TAGS INTACT AND VISIBLE AT THE TIME OF THE INITIAL INSPECTION.
- 7. IF THERE IS A DISCREPANCY BETWEEN THE QUANTITY OF PLANTS IN THE GRAPHIC REPRESENTATION AND THE CALLOUTS OR SCHEDULE THE REPRESENTATION WITH THE HIGHEST AMOUNT OF PLANTS SHALL GOVERN.
- CONTRACTOR SHALL NOTIFY OWNER'S REPRESENTATIVE OF ANY SITE CONDITIONS THAT REQUIRE MODIFICATIONS PRIOR TO INSTALLATION.
- . INSTALL MOOSE PROTECTION FENCE AROUND ALL NEW DECIDUOUS TREES IMMEDIATELY FOLLOWING PLANTING.
 MAINTAIN FOR EXTENT OF WARRANTY PERIOD.
- 10. PLANTING BEDS TO RECEIVE 18" DEPTH TOPSOIL AND 3" DEPTH SHREDDED BARK MULCH THROUGHOUT BEDS. BASE OF FENCE TO RECEIVE 3" DEPTH ROCK MULCH OVER LANDSCAPE FABRIC.
- 11. ALL PLANTING BEDS SHALL RECEIVE SHREDDED BARK MULCH AT THREE INCH DEPTH.
- 12. MAINTENANCE, INCLUDING BUT NOT LIMITED TO WATERING, WEEDING, FERTILIZING, AND MOWING, SHALL BE PERFORMED ONCE PLANT MATERIAL HAS BEEN INSTALLED AND THROUGHOUT THE MAINTENANCE AND WARRANTY PERIOD PER M.A.S.S.

ENGINEERS

www.amc-engineers.com
Adams, Morgenthaler & Co., Inc.
CoA No. C0342 - 907.257.9100
701 E. Tudor Rd. Suite 250
Anchorage AK 99503

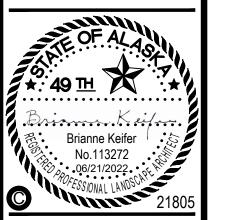

ALASKA COURT SYSTEM SNOWDEN ADMIN BUILDIN MECHANICAL UPGRADES

Revisior	ne	
	ate	Description
→ I	IF NO	T FULL SIZE T 1 INCH, CCORDINGLY
Designe		

Checked by:

AMC Project: 21805

Date: 6/24/2022

Project Phase
PERMIT DRAWINGS

Sheet Title

Sheet Title SITE AND LANDSCAPE PLAN

Sheet Number

L1.0

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PLANT TREE WITH TRUNK

OF ROOTBALL WITH SOIL.

ADJACENT SURFACE PER

- LIGHTLY TAMP SOIL AROUND

BRACE TREE. DO NOT OVER

PLANTING HOLE HAS BEEN

BACKFILLED, POUR WATER

AROUND THE ROOT BALL TO

COMPACT. WHEN THE

SETTLE THE SOIL.

- PLACE ROOTBALL ON

COMPACTED MOUND TO

PREVENT SETTLEMENT.

UN-EXCAVATED OR

THE ROOT BALL IN 6" LIFTS TO

PLANTING PLAN. KEEP

MATERIAL 3" CLEAR OF

TRUNK FLARE.

FLARE VISIBLE AT FINISHED

GRADE. DO NOT COVER TOP

OF ALAS Driame Neyw Brianne Keifer No.113272

ENGINEERS

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21805

YSTEM SUILDING RADES

S B B OUR CHANIC/ AL/ SNO/ ME(

Revisions No. Date Description

1 INCH AT FULL SIZE IF NOT 1 INCH,

SCALE ACCORDINGLY


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AMC Project: 6/24/2022 Date:

Sheet Title

Sheet Number

NOTIFICATION OF POTENTIAL HAZARDS

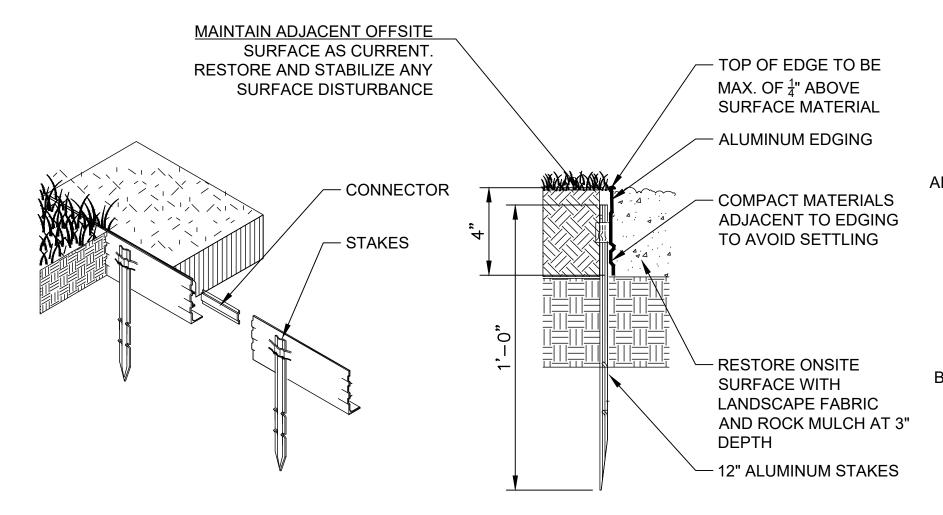


LANDSCAPE EDGING SHALL BE "CURV-RITE, INC." BLACK, ALUMINUM, ONE-EIGHTH INCH $\binom{1}{8}$ ") THICKNESS BY FOUR INCH (4") DEPTH PER M.A.S.S. SECTION 75.06

LANDSCAPE EDGING

REMOVE BURLAP, WIRE LIGHTLY TAMP SOIL BASKETS AND POTS AROUND THE ROOT BALL IN 6" LIFTS TO BRACE MULCH PER PLANTING SHRUB. DO NOT OVER PLAN. 3" DEPTH COMPACT. WHEN THE THROUGHOUT PLANTING PLANTING HOLE HAS BED. KEEP MULCH 3" BEEN BACKFILLED, AWAY FROM STEMS. POUR WATER AROUND THE ROOT BALL TO DEPTH VARIES SETTLE THE SOIL. DEPENDING ON ROOTBALL DEPTH. PLANT BACKFILL WITH TOPSOIL. WITH ROOT CROWN AT SOIL SURFACE

SHRUB PLANTING

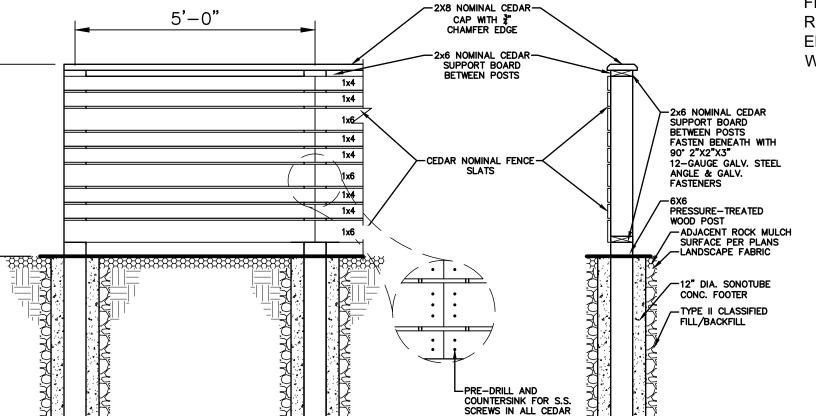

WOOD SCEEN FENCE

MOOSE PROTECTION FENCING SHALL BE REMOVED AT THE END OF THE WARRANTY PERIOD STEEL T-POSTS 9-FEET TALL WITH SAFETY CAPS, EMBED AT LEAST 14"-18" IN GROUND FOR SUFFICIENT STURDY INSTALLATION OR AS **DETERMINED BY THE** OWNER'S REPRESENTATIVE.

- FENCE FABRIC: 16-GAUGE, 5-FOOT HEIGHT, WITH 1" X 1.5" MAXIMUM OPENING, VINYL COASTED WIRE MESH. USE METAL TIES TO SECURE POSTS.

8 FOOT DIAMETER **MOOSE PROTECTION FENCE**

TREE STAKING SHALL BE AT THE -

CONTRACTOR BASED ON SITE

CONDITIONS. ANY DOWNED

CONTRACTOR TO REPLACE.

THE END OF THE WARRANTY

SHALL MEET THE REQUIREMENTS

SUBSECTION G-WOOD STAKES

ROUND-TOPPED SOIL BERM 4" -

CONSTRUCTED AROUND THE

AT ROOT BALL PERIPHERY.

TIMES THE DIAMETER OF THE ROOT

PLANTING PIT SHALL BE THREE

BALL. BACKFILL WITH TOPSOIL

ROOTBALL. BERM SHALL BEGIN

REMOVE BURLAP.

NOTE: INSTALL ON ALL DECIDUOUS

TREES.

HIGH 8' WIDE ABOVE ROOT

BALL SURFACE SHALL BE

IN M.A.S.S. SECTION 75.02,

ARTICLE 2.2 MATERIALS,

AND TIES.

DECIDUOUS TREE PLANTING

STAKING SHALL BE REMOVED AT

PERIOD. TREE STAKES AND TIES

RESPONSIBILITY OF THE

DISCRETION OF THE

TREES WILL BE THE

Project Phase **PERMIT DRAWINGS**

SITE AND LANDSCAPE DETAILS

w w w . a m c - e n g i n e e r s . c o m Adams, Morgenthaler & Co., Inc. CoA No. C0342 - 907.257.9100 701 E. Tudor Rd. Suite 250 Anchorage, AK 99503


Brianne Keifer No.113272 • .06/21/2022 • .06/21/2022 21805

SYSTEM BUILDING GRADES

ALASKA CC SNOWDEN AI MECHANICA


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RESERVED SIGN R7-8, ANY 12" X 18" TIME VAN ACCESSIBLE R7-8A, NO PARKING 12" X 6" SIGN R7P-101 12" X 18" EXISTING — GRADE

- 1. ALL CAR ACCESSIBLE SPACES SHALL HAVE A R7-8 SIGN AND ALL VAN ACCESSIBLE SPACES SHALL HAVE A R7-8A SIGN. THE SIGNS SHALL BE CENTERED ON 8 FOOT PARKING STALLS.
- 2. INSTALL A "NO PARKING" SIGN (R7P-101) CENTERED IN FRONT OF THE ACCESSIBLE ACCESS AISLÉ ON THE FACE OF BUILDING.
- 3. VAN ACCESSIBLE ACCESS AISLES ARE 8 FEET WIDE.
- 4. ALL TRAFFIC MARKINGS TO BE 4-INCH WHITE PAINT WITH THE EXCEPTION OF ACCESSIBLE TRAFFIC MARKINGS SHALL BE 4-INCH BLUE FOR SPACES/ AISLE STRIPING, AND INCLUDE CONCRETE PARKING BUMPERS.

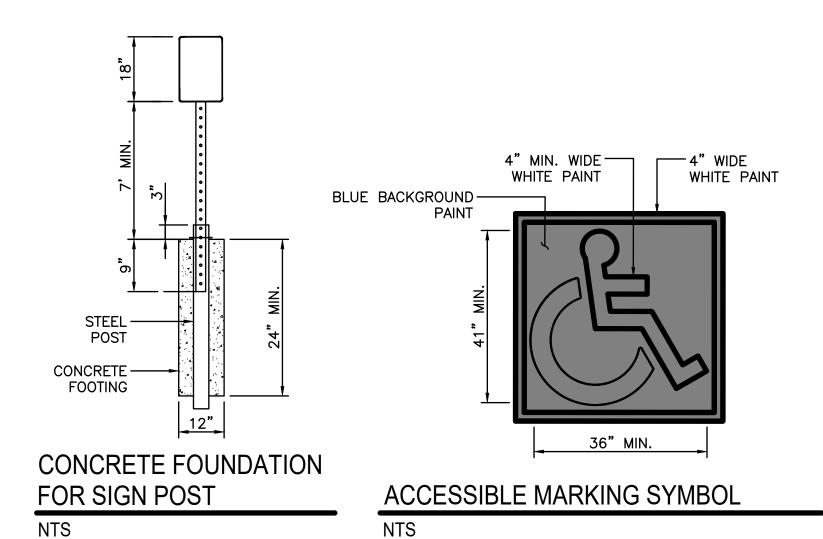

ADA ACCESSIBLE PARKING SIGNAGE

NTS

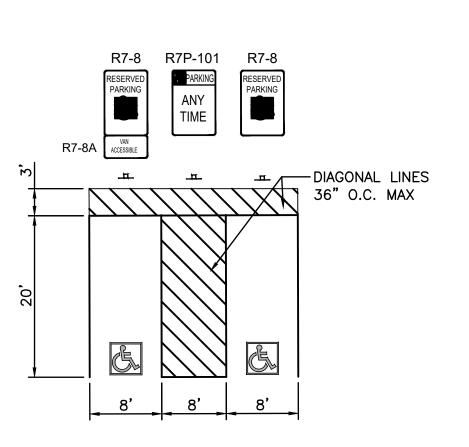ACCESSIBLE PARKING STRIPING AND SIGNAGE

Description

1 INCH AT FULL SIZE IF NOT 1 INCH, SCALE ACCORDINGLY

Designed by: AMC Project:

> Project Phase PERMIT DRAWINGS

6/24/2022

Sheet Title SITE AND LANDSCAPE DETAILS

Sheet Number **L2.1** **GENERAL**

DESCRIPTION

SYMBOL

PLUMBING

SYMBOL

ABBR.

DESCRIPTION

GENERAL PIPING

DESCRIPTION

SYMBOL

ABBR.

ABBREVIATIONS

INCHES MERCURY


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MOA ePlans Stamp

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ALASKA COURT SYSTEM SNOWDEN ADMIN BUILDING MECHANICAL UPGRADES

Rev	isions	
lo.	Date	Description

1 INCH AT FULL SIZE

IF NOT 1 INCH,
SCALE ACCORDINGLY

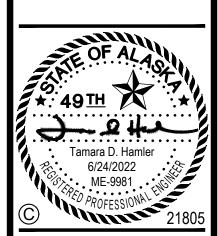Designed by:	TBD/MPL
Checked by:	TDH
AMC Project:	21805
Date:	6/24/2022
Droject Dhoop	

Project Phase
PERMIT DRAWINGS

Sheet Title LEGEND AND ABBREVIATIONS

Sheet Number

M001

	PLUMBING FIXTURE CONNECTION SCHEDULE													
SYMBOL	FIXTURE	WASTE (INCH)	VENT (INCH)	HW (INCH)	CW (INCH)	ELECTRICAL	REMARKS, BASIS OF DESIGN							
FD-1	FLOOR DRAIN	3	2	_	_	_	CAST IRON BODY WITH HEAVY DUTY ADJUSTABLE NICKEL BRONZE TOP, VANDAL PROOF SCREWS, TRAP PRIMER CONNECTION. JAY R. SMITH 2005Y.							
FD-2	FLOOR DRAIN	3	2	_	_	_	CAST IRON BODY WITH HEAVY DUTY ADJUSTABLE NICKEL BRONZE TOP, VANDAL PROOF SCREWS, WIDE FLANGE FOR WOOD DECK, TRAP PRIMER CONNECTION MIFAB FD230-WF.							
TP-1	ELECTRONIC TRAP PRIMER	_	-	_	1/2	120V	ELECTRONIC PRIMER VALVE WITH VACUUM BREAKER, DISTRIBUTION UNIT, INTERNAL BACKFLOW PROTECTION. PPP SP-500.							
TV-1	CENTRAL TEMPERING VALVE	_	-	1	1	110V RECEPTACLE	AUTOMATIC TEMPERING VALVE, SIDE SUPPLY INLETS, BOTTOM OUTLET. ARMSTRONG THE BRAIN DRV25.							

	MISCELLAN	EOUS EC	QUIPM	ENT SCHEDULE							
SYMBOL	LOCATION	ELECTRICAL (A,V,PH)	WEIGHT (LBS)	REMARKS, BASIS OF DESIGN							
AS-1	BOILER ROOM 302	_	300	COMBINATION AIR/DIRT HYDRAULIC SEPARATOR: 4 INCH FLANGED CONNECTIONS, INTERGRAL AIR VENT, BLOW DOWN VALVE, 150 PSIG WORKING PRESSURE AT 270 DEG F. 1FT PRESSURE DROP AT 190 GPM; VELOCITY 4.8 FEET PER SECOND. SPIROTHERM VDX400FA.							
AS-2	E. MECH. ROOM 307	_	150	COMBINATION AIR/DIRT SEPARATOR: 2-1/2 INCH FLANGED CONNECTIONS, INTERGRAL AIR VENT, BLOW DOWN VALVE, 150 PSIG WORKING PRESSURE AT 270 DEG F. 1FT PRESSURE DROP AT 48 GPM; VELOCITY 3.2 FEET PER SECOND. SPIROTHERM VDT250FA.							
WH-1	BOILER ROOM 302	10KW,208V,1	600	ELECTRIC WATER HEATER: 50 GAL STORAGE, 41 GPH RECOVERY AT 100 DEG F RISE, DUAL 5 KW HEATING ELEMENTS WITH SIMULTANEOUS OPERATION. RHEEM ELD80—TB.							
WH-2	AUDIO AREA 145	51A,208V,1	20	POINT OF USE ELECTRIC TANKLESS WATER HEATER, 1.2 GPM AT 70 F TEMP RISE. AO SMITH C2VA-120E.							
NT-1	BOILER ROOM 302	-	30	CONDENSATE NEUTRALIZER: 32 GALLON PER HOUR CAPACITY, AGGREGATE CALCIUM CARBONATE NEUTRALIZING MEDIUM, GALVANIZED STEEL MOUNTING ASSEMBLY. JJM BOILERWORKS JM-40.							
AC-1A	TELECOM 131	208V,1 1.0 MCA	40	SPLIT SYSTEM AIR CONDITIONING SYSTEM: NOMINAL 1.5 TON CAPACITY, WALL MOUNTED EVAPORATOR UNIT. R-410A REFRIGERANT, REMOTE CONTROLLER, INTEGRAL CONDENSATE PUMP. MITSUBISHI TPKA-A0181HA7.							
AC-1B	FAN ROOM 226	208V,1 11 MCA 28 MOCP	120	SPLIT SUSTEM AIR CONDITIONING SYSTEM: REMOTE CONDENSING UNIT. INVERTER DRIVEN TWIN ROTARY COMPRESSOR, PROPELLER FAN, ELECTRONIC EXPANSION VALVE. MITSUBISHI TRUY-A0181KA7.							

F	AIR COOLED CONDENSING UNIT SCHEDULE												
SYMBOL	LOCATION	ELECTRICAL (FLA,V,PH)	CAPACITY (TONS)	FLUID	WEIGHT (LBS)	REMARKS, BASIS OF DESIGN							
ACC-1	ROOF	62,208,3 68 MCA 90 MOP	15 Nominal	R-410A	1,200	AIR COOLED DIRECT EXPANSION CONDENSING UNIT: DUAL CIRCUIT, 45 DEG SUCTION TEMP, 205.6 MBH TOTAL COOLING CAPACITY AT 74DB/60WB. AAON CFA-015 SERIES.							
ACC-2	ROOF	62,208,3 68 MCA 90 MOP	15 Nominal	R-410A	1,200	AIR COOLED DIRECT EXPANSION CONDENSING UNIT: DUAL CIRCUIT, 45 DEG SUCTION TEMP, 205.6 MBH TOTAL COOLING CAPACITY AT 74DB/60WB. AAON CFA-015 SERIES.							
ACC-3	ROOF	55,208,3 60 MCA 80 MOP	13 NOMINAL	R-410A	1,200	AIR COOLED DIRECT EXPANSION CONDENSING UNIT: DUAL CIRCUIT, 45 DEG SUCTION TEMP, 159.2 MBH TOTAL COOLING CAPACITY AT 74DB/60WB. AAON CFA-013 SERIES.							
ACC-4	ROOF	55,208,3 60 MCA 80 MOP	13 NOMINAL	R-410A	1,200	AIR COOLED DIRECT EXPANSION CONDENSING UNIT: DUAL CIRCUIT, 45 DEG SUCTION TEMP, 159.2 MBH TOTAL COOLING CAPACITY AT 74DB/60WB. AAON CFA-013 SERIES.							

	BOILER SCH	IEDULE				
SYMBOL	LOCATION	MOTOR (FLA,V,PH)	INPUT (MBH)	OUTPUT (MBH)	WEIGHT (LBS)	REMARKS, BASIS OF DESIGN
BLR-1	BOILER ROOM 302	20,230,1	2,000	1,920	1,900 (WET)	CONDENSING NATURAL GAS BOILER ARRAY: FOUR 500 MBH MODULES IN A SINGLE CABINET, 20:1 TURNDOWN, 80 PSI MAXIMUM WORKING PRESSURE, INTEGRAL BOILER CONTROLS, 4" FLANGED STRAINER, CONDENSATE NEUTRALIZER, 75 PSI RELIEF VALVE. RIELLO MODEL AR 2000.

	EXPANSION	TANK S	CHEDUL	.E		
SYMBOL	LOCATION	ACCEPTANCE VOL (GAL)	TANK VOL (GAL)	PRE-CHARGE (PSIG)	WEIGHT (LBS)	REMARKS, BASIS OF DESIGN
ET-1	BOILER ROOM 302	34	68	12	800	HYDRONIC HEATING SYSTEM EXPANSION TANK: ASME STAMPED, STEEL SHELL WITH HEAVY DUTY BUTYL REMOVABLE BLADDER, FULL ACCEPTANCE. 125 PSIG MAXIMUM WORKING PRESSURE, 240 DEG F MAXIMUM OPERATING TEMPERATURE. BASE MOUNTED IN VERTICAL POSITION. AMTROL AX-120V.
ET-2	E. MECH. ROOM 307	3.2	6.4	50	70	GLYCOL HEATING EXPANSION TANK: ASME STAMPED, STEEL SHELL WITH BUTYL BLADDER, 125 PSI WORKING PRESSURE 240 DEG F MAXIMUM OPERATING TEMPERATURE. AMTROL AX-10-DD.
ET-3	BOILER ROOM 302	3.2	6.4	40	80	DOMESTIC HOT WATER EXPANSION TANK: STEEL SHELL WITH BUTYL BLADDER, 150 PSI WORKING PRESSURE, 200 DEG F MAXIMUM OPERATING TEMPERATURE. AMTROL THERM—X—TROL ST—12—C.

PUMP SCHEDULE													
SYMBOL	LOCATION	SERVICE	FLUID	TEMP. (DEG F)	GPM	HEAD (FEET)	MOTOR (HP,V,PH)	REMARKS BASIS OF DESIGN					
PMP-1 PMP-2	BOILER ROOM 302	BUILDING HEATING CIRC	WATER	180	190	50	5,208,3 (2) VSDS	IN-LINE CENTRIFUGAL PUMP: 4.9" IMPELLER, 53% MIN. EFF., 3,450 RPM. TACO 1935.					
PMP-3 PMP-4	E. MECH. ROOM 307	HEATING COIL CIRC	50% PG	150	48	45	3,208,1	IN-LINE CIRCULATOR PUMP: ECM MOTOR, SELF-SENSING. TACO VR25H.					
PMP-5	E. MECH. ROOM 307	HC-4 CIRC	50% PG	150	27	10	3/4,208,1	IN-LINE CIRCULATOR PUMP: ECM MOTOR, SELF-SENSING. TACO VR15M.					
PMP-6	BOILER ROOM 302	DOMESTIC HOT WATER RECIRC	DOMESTIC WATER	120	2	10	1/8,120,1	IN-LINE CIRCULATOR PUMP: STAINLESS STEEL CONSTRUCTION. TACO 009-SF5.					

	HEAT EXCHANGER SCHEDULE													
SYMBOL	LOCATION	HOT SIDE FLUID	GPM	TEMP IN (DEG F)	TEMP OUT (DEG F)	MAX WPD (PSI)	COLD SIDE FLUID	GPM	TEMP IN (DEG F)	TEMP OUT (DEG F)	MAX WPD (PSI)	MIN OUTPUT (MBH)	WEIGHT (LBS)	REMARKS BASIS OF DESIGN
HX-1	E. MECH. ROOM 307	WATER	46	180	160	3.0	50% PG	48	138	160	3.0	475	100	BRAZED PLATE TYPE: WALL MOUNT TABS, (50) 316L SS PLATES B&G BP423-50.

NOTIFICATION OF POTENTIAL HAZARDS


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	LOUVER/H	100	SCHE	DULE				
SYMBOL	UNIT AND USAGE	SCFM	SIZE WIDTH X HT (INCH)	MIN FREE AREA (SF)	MAX FREE AREA VEL (FPM)	MAX APD (INCH WC)	WEIGHT (LBS)	REMARKS, BASIS OF DESIGN
LV-1	AHU-1 / AHU-2 / AHU-3 OSA INTAKE	19,400	108 X 72	31.7	620	0.07	250	LOUVER: 6" THICK EXTRUDED ALUMINUM, 37.5 DEGREE DRAINABLE BLADES WITH BIRD SCREEN RUSKIN ELF6375DX.
LV-2	RF-2 RELIEF	6,600	30 X 54	6.2	1,100	0.16	100	SAME AS LV-1, EXCEPT SIZE.
LV-3	SCF-1 OSA INTAKE	1,200	18 X 30	1.8	670	0.08	50	SAME AS LV-1, EXCEPT SIZE.
LV-4	EF-1 RELIEF	2,300	18 X 36	2.3	1,040	0.15	50	SAME AS LV-1, EXCEPT SIZE.
LV-5A	AHU-1 RELIEF	3,600	60 X 42	9.3	350	0.03	100	EXISTING LOUVER TO REMAIN.
LV-5B	AHU-1 RELIEF	2,400	44 X 40	5.5	430	0.03	50	SAME AS LV-1, EXCEPT SIZE. COORDIN. SIZE WITH EXISTING OPENING.
HD-1	SCF-1 RELIEF	1,200	14 X 14	1.5	890	0.11	60	ROOF MOUNTED RELIEF HOOD: SPUN ALUMINUM WITH CURB CAP, GALVANIZED BIRDSCREEN, AND MOTORIZED RELIEF DAMPER. GREENHECK FGR.
HD-2	AHU-3 RELIEF	4,900	24 X 28	4.7	1,050	0.15	100	SAME AS HD-1, EXCEPT SIZE.
HD-3	AHU-4 RELIEF	3,500	30 X 48	10	350	0.03	100	SAME AS HD-1, EXCEPT SIZE AND HING BASE.
HD-4	AHU-4 INTAKE	5,500	36 X 40	10	550	0.07	150	ROOF MOUNTED INTAKE HOOD: SPUN ALUMINUM WITH CURB CAP, GALVANIZED BIRDSCREEN. GREENHECK FGI.

SYMBOL	LOCATION	USE	SCFM	SP (INCH WC)	FAN RPM	MOTOR (HP,V,PH)	WEIGHT (LBS)	REMARKS BASIS OF DESIGN
EF-1	NEW MECH. ROOM 307A	GENERAL EXHAUST	2,300	1.00	1,464	1,120,1	140	INLINE EXHAUST FAN: DIRECT DRIVE, CENTRIFUGAL SQUARE INLINE FAN, VARI-GREEN ECM MOTOR. GREENHECK SQ-160HP-VG.
RF-2	NEW MECH. ROOM 307A	AHU-2 RELIEF	6,600	1.00	1,554	3,208,3 (VSD)	200	INLINE RELIEF FAN: DIRECT DRIVE. GREENHECK SQ-18-07.

	TERMIN	IAL H	IEATI	NG (JNIT	SCHED	ULE		
SYMBOL	LOCATION	OUTPUT (MBH)	FLUID	FLOW (GPM)	MAX WPD (FEET)	FLUID TEMP IN/OUT (DEGREES F)	MOTOR (HP,V,PH)	WEIGHT (LBS)	REMARKS, BASIS OF DESIGN
UH-1	NEW MECH. ROOM 307A	19.7	WATER	3.0	0.3	180/160	1/25,115,1	34	HORIZONTAL UNIT HEATER: 630 CFM, AIR DEFLECTORS, SAFETY GUARD. MODINE HC-33.
UH-2 UH-3 UH-4	LEVEL 1	10.0	WATER	1.1	0.3	180/160	1/20,115,1	-	EXISTING HORIZONTAL UNIT HEATER TO REMAIN.
CUH-1	E. VEST 140	9.0	WATER	1.0	0.3	180/160	1/15,120,1	ı	EXISTING CABINET UNIT HEATER TO REMAIN.
FT-1	SEE PLANS	_	WATER	_	_	180/160	_	_	EXISTING BASEBOARD FINNED TUBE: BALANCE GPM.



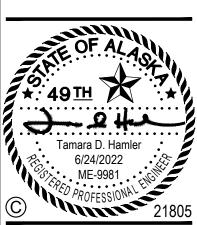

ALASKA COURT SYSTEM SNOWDEN ADMIN BUILDING MECHANICAL UPGRADES

0.	Date	Description									
	1 INCH AT FULL SIZE										
-	-	-									
	IF NOT 1 INCH,										

SCALE ACCO	,
signed by:	TBD/MPL
ecked by:	TDH
IC Project:	21805

AMC Project:	21805
Date:	6/24/2022
Project Phase PERMIT DRA	WINGS

Sheet Title SCHEDULES

Sheet Number

M002

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Tamara D. Hamler

6/24/2022 ME-9981 PROFESSIONAL 21805

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1 INCH AT FULL SIZE IF NOT 1 INCH, SCALE ACCORDINGLY

Designed by:	TBD/MPI
Checked by:	TDH
AMC Project:	2180
Date:	6/24/2022
Desired Disease	

Project Phase PERMIT DRAWINGS

Sheet Title SCHEDULES

Sheet Number

NOTIFICATION OF POTENTIAL HAZARDS

ASBESTOS, LEAD, AND OTHER HAZARDOUS MATERIALS ARE PRESENT IN THE BUILDING AND MAY IMPACT THE WORK OF ALL TRADES. REGULATED AIR CONTAMINANTS, INCLUDING ASBESTOS AND LEAD, ARE ALSO PRESENT IN SETTLED AND CONCEALED DUST IN AND ON ARCHITECTURAL, STRUCTURAL, MECHANICAL, AND ELECTRICAL COMPONENTS OR SYSTEMS THROUGHOUT THE BUILDING. ALL TRADES SHALL THESE MATERIALS AND THE INSTALLATION OF THE NEW MATERIALS OR COMPONENTS. THIS NOTIFICATION IS PROVIDED IN ACCORDANCE WITH EPA AND OSHA REQUIREMENTS.

> TITUS | CEILING SUPPLY DIFFUSER: ALUMINUM, MODULAR MCD-AA CORE, ADJUSTABLE PATTERN, SQUARE NECK, COORDINATE BORDER TYPE WITH RCP.

> > WITH EXTRACTOR AND 22.5 DEGREE THROW.

WITH EXTRACTOR AND 22.5 DEGREE THROW.

TITUS PLENUM SLOT DIFFUSER: STEEL, 1 SLOT, 1" WIDTH, TBDI-80 ADJUSTABLE GASKETED BLADES, INSULATED PLENUM.

EGGCRATE GRID, COORDINATE BORDER TYPE

EGGCRATE GRID, COORDINATE BORDER TYPE

TITUS | RETURN GRILLE: ALUMINUM 1/2" X 1/2" X 1/2"

PAR-AA ALUMINUM, 3/16" HOLES ON STAGGARD CENTERS.

WITH EXTRACTOR AND 22.5 DEGREE THROW.

BALANCE AIRFLOW TO INDICATED CFM.

TITUS EXHAUST GRILLE: ALUMINUM 1/2" X 1/2" X 1/2"

EGGCRATE GRID, COORDINATE BORDER TYPE

TITUS TRANSFER GRILLE: ALUMINUM 1/2" X 1/2" X 1/2" 50F EGGCRATE GRID, COORDINATE BORDER TYPE

TITUS RETURN SLOT GRILLE: 1 SLOT, 2" WIDTH, INSULATED

EXISTING RETURN GRILLE, CLEAN AND WIPE GRILLE SURFACE.

COORDINATE BORDER TYPE WITH RCP.

RETURN GRILLE: ALUMINUM 1/2" X 1/2" X 1/2"

EXISTING SUPPLY DIFFUSER, CLEAN AND WIPE DIFFUSER SURFACE. BALANCE AIRFLOW TO INDICATED CFM.

SAME AS SA, EXCEPT SIZE.

SAME AS SA, EXCEPT SIZE.

SAME AS SA, EXCEPT SIZE.

TITUS CEILING DIFFUSER: ALUMINUM, 24X24 TDC-AA | MODULE, ROUND NECK, LAY-IN

TITUS ALUMINUM DUCT MOUNTED GRILLE

TITUS PERFORATED RETURN GRILLE:

271FL SINGLE DEFLECTION, 3/4" SPACING,

FL-20 RETURN HOOD AND LIGHT SHIELD.

WITH RCP.

WITH RCP.

50F

TITUS SAME AS EA, EXCEPT SIZE.

SINGLE DEFLECTION, 3/4" SPACING,

TITUS | WALL MOUNTED SUPPLY GRILLE 271FL SINGLE DEFLECTION, 3/4" SPACING,

REMARKS

AIR INLET/OUTLET SCHEDULE

MAX ACTIVE

0.01 12X12

19 | 0.04 | 12X12

17 0.06 12X12

11 | 0.03 | 12X10 | 12X10

300 | 16 | 0.04 | 12X12

250 | 14 | 0.07 | 18X18 |

1200 | 17 | 0.04 | 30X12

0.06

48X2

- 0.01 24X24 24X24

- 0.01 24X12 24X12

20 0.06 24X24 12X12

6X6

- 0.01 24X24 24X24

100

200

400

325

125

1100

500

550

125

1100

20

_

110 | 10 | 0.05 |

- 0.05 48X2

300 | 10 | 0.04 | 10X10 |

SA

SB

SC

SD

SF

SH

RA

RB

RC

RE

RF

EA

EB

TA

SCFM NC APD FACE SIZE SIZE DESIGN (IN WC) (INCH) (INCH)

DUCT BASIS OF

10

12

TITUS MCD-AA

TITUS

TITUS

MCD-AA

TITUS

50F

325 | 11 | 0.03 | 12X10 | 12X10 | TITUS | WALL MOUNTED RETURN GRILLE

SYMBOL	SYMBOL LOCATION	FAN	SCFM	EXT / TOT	FAN				MOTOR	COIL	WEIGHT	REMARKS, BASIS OF DESIGN
		SERVICE		SP (INCH WC)	SIZE (INCH)	TYPE	RPM	EFF & BHP	(HP,V,PH)	NO	(LBS)	
AHU-1	FAN ROOM 226	VENT	6,600	1.5/3.5	15 QTY: 2	PLENUM	2,714	59% 3.05 BHP	5,208,3 QTY: 2 (2) VSDs	HC-1 CC-1	3,500	MODULAR AIR HANDLING UNIT: DRAW THROUGH ARRANGEMENT, DIRECT DRIVE FANS, MIXING BOX, SUMMER MERV8 PREFILTER, HEATING COIL, WINTER MERV8 PREFILTER, MERV13 FINAL FILTER, COOLING COIL, FAN SECTION, DISCHARGE PLENUM OVERALL DIMENSIONS: 168" L, 69" W, 51" H. YORK SOLUTION—XTI SERIES.
AHU-2	NEW MECH. ROOM 307A	VENT	7,400	1.5/3.5	18.25 QTY: 2	PLENUM	1,982	59% 3.47 BHP	5,208,3 QTY: 2 (2) VSDs	HC-2 CC-2	4,000	MODULAR AIR HANDLING UNIT: SAME AS AHU-1 EXCEPT SIZE. OVERALL DIMENSIONS: 174" L, 81" W, 51" H. YORK SOLUTION-XTI SERIES.
AHU-3	E. MECH. ROOM 307	VENT	5,400 SUPPLY 4,900 RETURN	1.25/3.0 1.00 ESP	16.5 QTY: 2 15 QTY: 2	PLENUM	2,172 1,802	60% 2.49 BHP 44% 0.8 BHP	5,208,3 SUPPLY FAN QTY: 2 (2) VSDs 1,208,3 RETURN FAN QTY: 2 (2) VSDs	HC-3 CC-3	5,500	MODULAR AIR HANDLING UNIT: DRAW THROUGH ARRANGEMENT, DIRECT DRIVE FANS, RETURN FAN INLET PLENUM, RETURN FAN SECTION, RETURN FAN DISCHARGE PLENUM, MIXING BOX, SUMMER MERV8 PREFILTER, HEATING COIL, WINTER MERV8 PREFILTER, MERV13 FINAL FILTER, COOLING COIL, FAN SECTION, DISCHARGE PLENUM. OVERALL DIMENSIONS: 261" L, 54" W, 72" H. YORK SOLUTION—XTI SERIES.
AHU-4	E. MECH. ROOM 307	ATRIUM VENT	5,500	1.25/3.5	15 QTY: 2	PLENUM	2,794	59% 2.61 BHP	5,208,3 QTY: 2 (2) VSDs	HC-4 CC-4	4,500	MODULAR AIR HANDLING UNIT: SAME AS AHU-1 EXCEPT SIZE. OVERALL DIMENSIONS: 220" L, 54" W, 72" H. YORK SOLUTION-XTI SERIES.
SCF-1	BOILER ROOM 302	COOLING	1,200	0.75/1.25	-	FC	1,767	85% 0.82 BHP	1,208,3	_	350	SMALL CABINET FAN: MIXING BOX, MERV8 PREFILTER, FAN SECTION. GREENHECK MSCF-25L.

INDOOR AIR QUALITY DOCUMENTATION

THE VENTILATION SYSTEMS FOR THIS FACILITY WERE DESIGNED IN ACCORDANCE WITH ASHRAE STANDARD 62.1-2019, BASED ON THE FOLLOWING ASSUMPTIONS:

60 NORMAL BUILDING POPULATION

1,250 AHU-1 MINIMUM OUTSIDE AIR CFM FOR INDOOR AIR QUALITY AND BUILDING PRESSURIZATION

1,000 AHU-2 MINIMUM OUTSIDE AIR CFM FOR INDOOR AIR QUALITY AND BUILDING PRESSURIZATION

700 AHU-3 MINIMUM OUTSIDE AIR CFM FOR INDOOR AIR QUALITY AND BUILDING PRESSURIZATION

1,900 AHU-4 MINIMUM OUTSIDE AIR CFM FOR INDOOR AIR QUALITY AND BUILDING PRESSURIZATION

-19 OUTSIDE WINTER DESIGN TEMPERATURE (DEGREES F)

ASSUMPTION: OUTSIDE AIR MEETS NATIONAL PRIMARY AMBIENT AIR QUALITY STANDARDS SET BY THE U.S. EPA.

ASSUMPTION: SOURCES OF IAQ CONTAMINATION ARE LIMITED TO NORMAL BUILDING FURNISHINGS, MATERIALS AND SURFACE COATINGS, AND HUMAN BIO-EFFLUENTS ASSOCIATED WITH ORDINARY HUMAN ACTIVITIES.

	HEATING CO	OIL SC	CHEDUL	.E								
SYMBOL	LOCATION	MBH	SCFM	AIR TEMP (IN/OUT)	SIZE WIDTH X HT (INCH)	MAX VEL (FPM)	MAX APD (INCH WC)	FLUID	GPM	FLUID TEMP IN/OUT (DEGREES F)	MAX WPD (FEET)	REMARKS BASIS OF DESIGN
HC-1	AHU-1	96	4,500	45/65	56X36.25	470	0.15 AT 6,500 CFM	50% PG	11.4	160/140	1.0	HEATING COIL: BY AHU SUPPLIER, 1 ROW, 8 FPI.
HC-2	AHU-2	68	5,400	53/65	68X36	430	0.10 AT 7,300 CFM	50% PG	4.1	160/123	1.0	HEATING COIL: BY AHU SUPPLIER, 1 ROW, 8 FPI.
HC-3	AHU-3	65	5,400	58/69	41X54	350	0.10 AT 5,400 CFM	50% PG	5.0	160/131	1.0	HEATING COIL: BY AHU SUPPLIER, 1 ROW, 8 FPI.
HC-4	AHU-4	255	5,500	39/79	41X39.25	490	0.25 AT 5,500 CFM	50% PG	27.0	160/140	4.0	HEATING COIL: BY AHU SUPPLIER, 2 ROW, 8 FPI.
RHC-301	CORRIDOR 313	20.7	600	55/85	16X12	450	0.1	WATER	2.1	180/160	4.0	DUCT MOUNTED REHEAT: 1 ROW, 9 FPI.
RHC-302	E. MECH. ROOM 307	32.6	1000	55/85	28X12	450	0.1	WATER	3.3	180/160	4.0	DUCT MOUNTED REHEAT: 1 ROW, 8 FPI.
RHC-303	E. MECH. ROOM 307	23.0	650	55/85	18X12	450	0.1	WATER	2.4	180/160	4.0	DUCT MOUNTED REHEAT: 1 ROW, 9 FPI.
RHC-304	CORRIDOR 313	17.3	500	55/85	14X12	450	0.1	WATER	1.8	180/160	4.0	DUCT MOUNTED REHEAT: 1 ROW, 9 FPI.
RHC-305	E. MECH. ROOM 307	27.2	825	55/85	22X12	450	0.1	WATER	2.8	180/160	4.0	DUCT MOUNTED REHEAT: 1 ROW, 9 FPI.
RHC-306	E. MECH. ROOM 307	20.7	600	55/85	16X12	450	0.1	WATER	2.1	180/160	4.0	DUCT MOUNTED REHEAT: 1 ROW, 9 FPI.
RHC-307	E. MECH. ROOM 307	5.0	150	55/85	8X6	450	0.1	WATER	0.5	180/160	4.0	DUCT MOUNTED REHEAT: 1 ROW, 10 FP
RHC-308	E. MECH. ROOM 307	19.6	550	55/85	16X12	450	0.1	WATER	2.0	180/160	4.0	DUCT MOUNTED REHEAT: 1 ROW, 9 FPI.
RHC-401	E. MECH. ROOM 307	56.5	2600	72/92	44X19.5	450	0.1	WATER	5.8	180/160	4.0	DUCT MOUNTED REHEAT: 1 ROW, 6 FPI.

	AIR TERMINAL UN	IT SC	HEDI	JLE								
VAV- NUMBER	LOCATION	AHU	MIN CFM	MAX HEAT. CFM	MAX COOL. CFM	EAT (DEG F)	LAT (DEG F)	MAX APD (2) (INCH WC)	COIL MBH (1)	COIL	COIL GPM	BOX SIZE (INCH)
VAV-101	HR DIRECTOR 158	AHU-1	150	150	250	55	90	0.10	5.7	1	0.55	6
VAV-102	HR DEPUTY DIRECTOR 159	AHU-1	150	200	200	55	85	0.10	6.6	1	0.55	6
VAV-103	HR ANALYST 160	AHU-1	100	150	150	55	90	0.10	5.7	1	0.55	6
VAV-104	HR GENERALIST 161	AHU-1	100	100	100	55	99	0.10	4.7	1	0.55	6
VAV-105	HR PAYROLL SUPER 151	AHU-1	100	250	250	55	81	0.10	7.1	1	0.55	6
VAV-106 (3)	WORK-BREAK AREA 152	AHU-1	200	400	400	55	94	0.20	17.0	2	0.75	8
VAV-107	HR FILES 153	AHU-1	100	150	150	55	94	0.10	6.3	1	1.00	6
VAV-108	HR OPEN OFFICE 154	AHU-1	400	600	600	55	92	0.30	23.9	2	1.50	8
VAV-109	MICROGRAPHICS 149	AHU-1	450	550	550	55	77	0.10	13.4	1	1.50	8
VAV-110	GENERAL SERVICES 148	AHU-1	400	650	650	55	92	0.30	26.4	2	2.00	8
VAV-111 (3)	AUDIO AREA 145	AHU-1	800	1,000	1,175	55	80	0.20	26.6	1	2.00	12
VAV-112	IS TECHNICIAN 147	AHU-1	700	1,550	1,550	55	90	0.40	58.2	2	4.00	12
VAV-113	CENTRAL SERVICES SUPER 144	AHU-1	200	575	275	55	93	0.30	23.5	2	1.50	8
VAV-114 (3)	PRINT SHOP 142	AHU-1	425	875	875	55	78	0.20	21.3	1	2.00	10
VAV-201	ADMIN ATTY 249	AHU-2	125	300	300	55	78	0.10	7.5	1	0.55	6
VAV-202	RULES ATTY 248	AHU-2	125	200	200	55	85	0.10	6.6	1	0.55	6
VAV-203	ADMIN DIRECTOR 216	AHU-2	250	250	250	55	83	0.10	7.5	1	0.75	6
VAV-204	RCTA 215	AHU-2	100	150	150	55	90	0.10	5.7	1	0.55	6
VAV-205	SPECIAL PROJECTS 214	AHU-2	150	200	200	55	85	0.10	6.5	1	0.55	6
VAV-206	PROCUREMENT SPEC 246	AHU-2	200	375	375	55	75	0.10	8.1	1	0.55	6
VAV-207 (3)	ADMIN 245	AHU-2	425	600	525	55	94	0.30	25.2	2	1.33	8
VAV-208	MGR FISCAL OPERATIONS 239	AHU-2	125	250	250	55	82	0.10	7.2	1	0.55	6
VAV-209	SENIOR ACCT CLERK 241	AHU-2	200	200	200	55	85	0.10	6.6	1	0.55	6
VAV-210	FISCAL OFFICER 238	AHU-2	150	225	225	55	83	0.10	6.9	1	0.55	6
VAV-211	ACCT ANALYST 237	AHU-2	100	200	200	55	85	0.10	6.6	1	0.55	6
VAV-212 (3)	FISCAL CLERKS-OPEN OFFICE 236	AHU-2	400	900	900	55	73	0.20	17.8	1	1.00	10
VAV-213	FISCAL CLERKS-OPEN OFFICE 236	AHU-2	550	550	550	55	92	0.20	22.3	2	1.33	10
VAV-214 (3)	RULES LIBRARY 223	AHU-2	325	325	325	55	95	0.10	13.9	2	0.75	6
VAV-215	ADMIN OPEN OFFICE 224	AHU-2	750	850	750	55	91	0.30	33.6	2	2.00	10
VAV-216 (3)	ADMIN OPEN OFFICE 224	AHU-2	700	800	1,250	55	92	0.50	32.0	2	1.50	12
VAV-217 (3)		AHU-2	200	200	200	55	93	0.10	8.3	1	1.33	6
VAV-218	FAMILY CASE COORD. 235	AHU-2	150	250	250	55	81	0.10	7.1	1	0.55	6
VAV-219	COURT ANALYST 230	AHU-2	100	150	150	55	90	0.10	5.7	1	0.55	6
VAV-220	STATE JURY COORDINATOR 234	AHU-2	125	300	300	55	82	0.10	8.9	1	0.55	8


(1) SUBMITTALS SHALL INDICATE HEATING CAPACITY AT HEATING CFM (2) AIR SIDE PRESSURE DROP FOR ENTIRE VAV ASSEMBLY, INCLUDING HEATING COIL.

(3) PROVIDE COIL WITH 12 FPI. 4. BASIS OF DESIGN: TITUS DESV, REHEAT COIL 10 FPI.

5. HEATING FLUID IS WATER, EFT: 180 DEG F, LFT: 150 DEG F. MAXIMUM WPD THROUGH COIL 3 FT.

	COOLING COIL SCHEDULE														
SYMBOL	LOCATION	MBH TOT / SENS	SCFM	AIR TEMP IN (DB/WB)	AIR TEMP OUT (DB/WB)	SIZE WIDTH X HT (INCH)	MAX VEL (FPM)	MAX APD (INCH WC)	REFRIG- ERANT	SUCTION TEMP (DEGREES F)	REMARKS BASIS OF DESIGN				
CC-1	AHU-1	145/137	6,600	74/60	55/52	57X35	480	0.4	R-410a	44	DX COOLING COIL: BY AHU SUPPLIER, 4 ROWS, 9 FPI.				
CC-2	AHU-2	165/153	7,400	74/60	55/52	69X35	440	0.3	R-410a	44	DX COOLING COIL: BY AHU SUPPLIER, 4 ROWS, 8 FPI.				
CC-3	AHU-3	130/120	5,400	74/60	53/51	42X55	350	0.2	R-410a	44	DX COOLING COIL: BY AHU SUPPLIER, 4 ROWS, 8 FPI.				
CC-4	AHU-4	119/112	5,500	74/60	55/52	42X40	470	0.4	R-410a	44	DX COOLING COIL: BY AHU SUPPLIER, 4 ROWS, 8 FPI.				

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- 1) DEMOLISH WATER HEATER AND PIPING.
- FINTUBE ENCLOSURE, ELEMENT, CONTROL VALVE, AND SPACE TEMPERATURE SENSOR (NOT SHOWN) TO REMAIN, TYPICAL.
- 3> DEMOLISH GHS/GHR PIPING AND SUPPORTS, TYPICAL.
- 4 DEMOLISH DIFFERENTIAL PRESSURE TRANSMITTER.
- COORDINATE LIMITS OF DEMOLITION WITH NEW WORK.
- FIELD VERIFY EXISTING CONDITIONS.

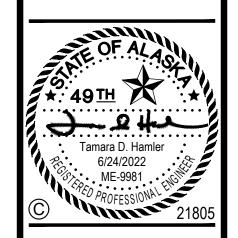SEC AL/ SNO/ ME(

Revisions				
0.	Date	Description		

1 INCH AT FULL SIZE IF NOT 1 INCH, SCALE ACCORDINGLY

Designed by:	TBD/MPL
Checked by:	TDH
AMC Project:	21805
Date:	6/24/2022


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FIRST FLOOR PLAN PIPING - DEMOLITION

Sheet Number

M101

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0.	Date	Description		

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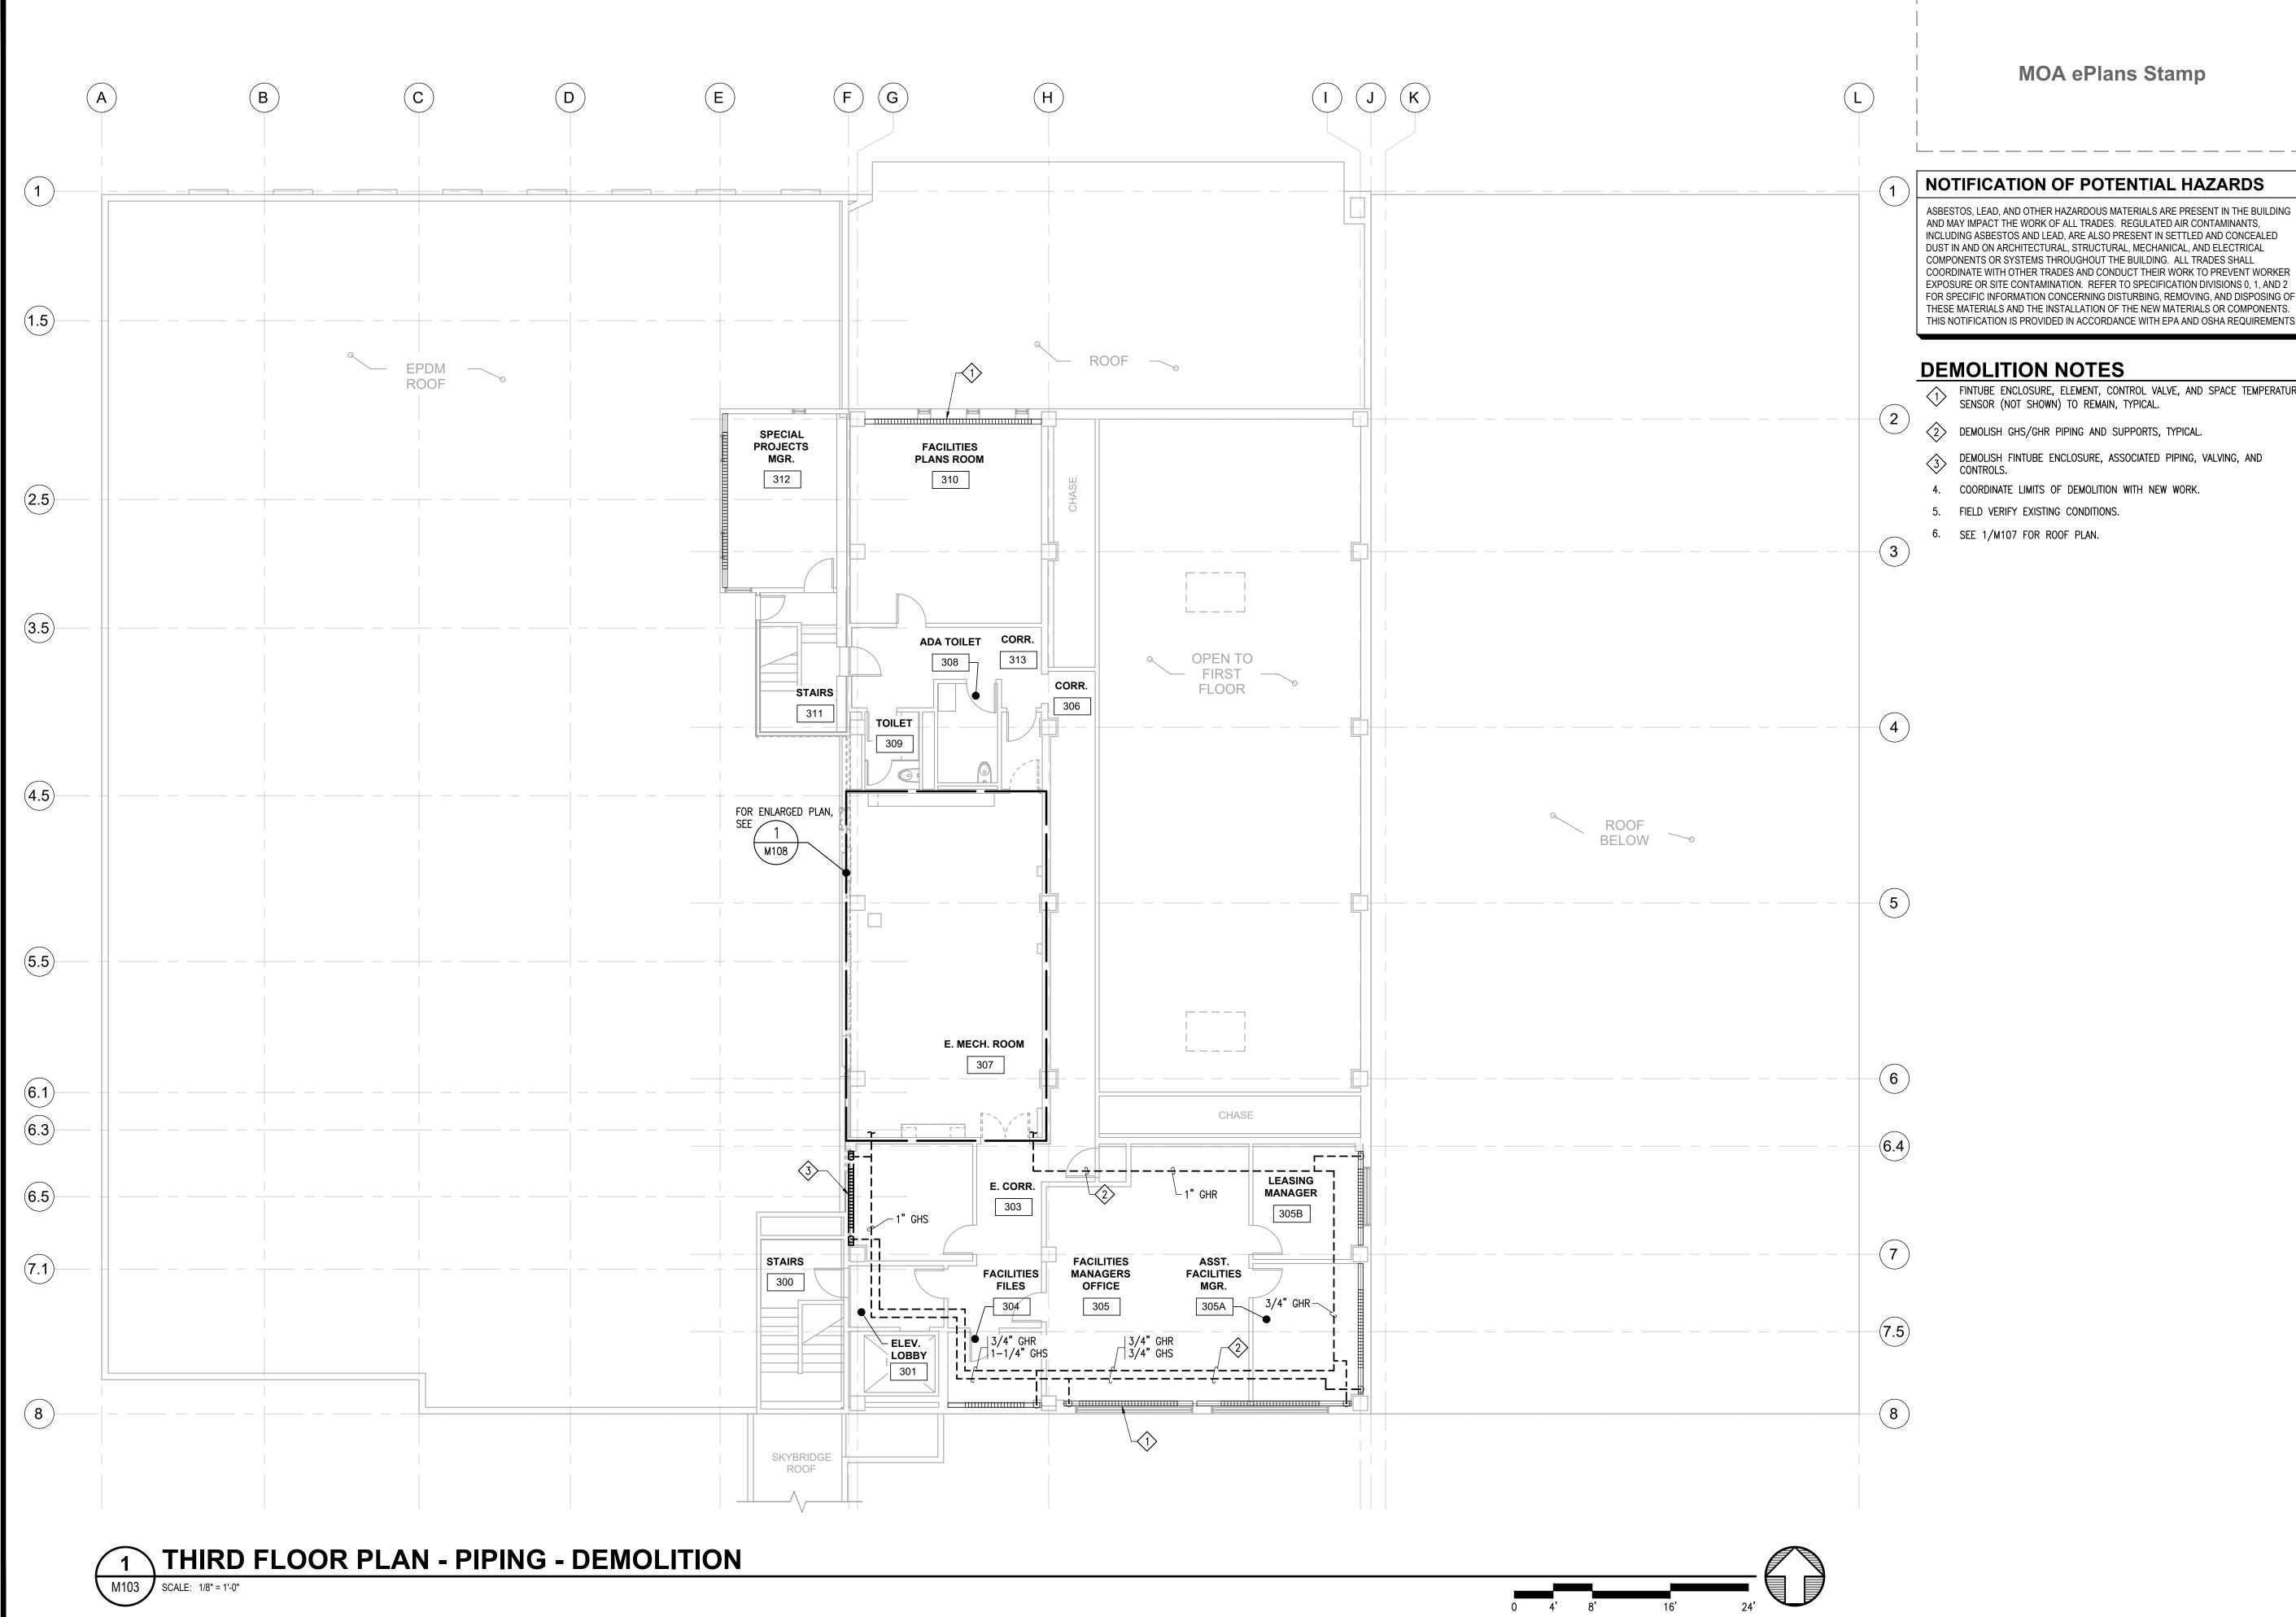
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AMC Project:	2180
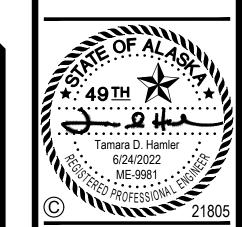
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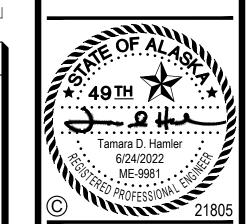
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DEMOLITION

Sheet Number



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DEMOLITION NOTES

- FINTUBE ENCLOSURE, ELEMENT, CONTROL VALVE, AND SPACE TEMPERATURE SENSOR (NOT SHOWN) TO REMAIN, TYPICAL.
- DEMOLISH GHS/GHR PIPING AND SUPPORTS, TYPICAL.
- DEMOLISH FINTUBE ENCLOSURE, ASSOCIATED PIPING, VALVING, AND CONTROLS.
- 4. COORDINATE LIMITS OF DEMOLITION WITH NEW WORK.
- 5. FIELD VERIFY EXISTING CONDITIONS.
- 6. SEE 1/M107 FOR ROOF PLAN.

AL/ SNO/ ME(

Revisions				
No.	Date	Description		

1 INCH AT FULL SIZE IF NOT 1 INCH, SCALE ACCORDINGLY

Designed by:	TBD/MPI
Checked by:	TDH
AMC Project:	2180
Date:	6/24/2022
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Project Phase PERMIT DRAWINGS

Sheet Title

THIRD FLOOR PLAN PIPING - DEMOLITION

Sheet Number