



SHEET NOTES


1. COORDINATE WORK WITH MECHANICAL, ARCHITECT, OWNER AND OTHER TRADES. REFER TO AND COORDINATE WORK SHOWN ON NEW PLANS, DETAILS AND DIAGRAMS. REFER TO POWER ONE-LINE DIAGRAM ON SHEET E501 FOR ADDITIONAL ELECTRICAL SERVICE AND POWER DISTRIBUTION DETAILS.
2. REUSE EXISTING DISCONNECT FOR PANEL C.
3. REUSE EXISTING DISCONNECT FOR PANEL A.
4. EXISTING CT CAN AND METER TO REMAIN.
5. REUSE AND RECONFIGURE EXISTING PANEL C PER PANEL SCHEDULE. REFER TO POWER ONE-LINE DIAGRAM.
6. DEMOLISH EXISTING PANEL A. PROVIDE NEW PANEL A AND IN SAME LOCATION. REFER TO POWER ONE-LINE DIAGRAM AND PANEL SCHEDULE.
7. DEMOLISH EXISTING PANEL B. PROVIDE NEW PANEL B IN MAIN COMM ROOM.
8. EXISTING BAS PANEL FOR POWER MONITORING TO REMAIN - RECIRCUIT TO A-36.
9. PROVIDE EXTERIOR LIGHTING CONTACTOR - REFER TO LIGHTING PLANS FOR ADDITIONAL INFORMATION.
10. EXISTING TELECOM RACK WITH EXISTING TELECOM TERMINATIONS AND OWNER NETWORK EQUIPMENT - MOVE/RELOCATE AS SHOWN. PROVIDE SEISMIC SUPPORT FOR RACK AND RACK-MOUNTED TELECOM GROUNDING BUSBAR (TGB). PROVIDE MAIN TELECOM GROUNDING BUSBAR (TMGB) ON THE WALL ADJACENT TO RACK. PROVIDE #6 AWG CU TELECOM BONDING CONDUCTOR (TBB) AND BOND TGB AND TMGB BACK TO THE MAIN ELECTRICAL SERVICE GROUND. PATCH FLOOR TILES WHERE RACK WAS RELOCATED FROM. UTILIZE THIS RACK FOR NEW PATCH PANELS AND TERMINATION OF NEW HORIZONTAL TELECOM CABLING. PROVIDE NEW VERTICAL CABLE MANAGEMENT ON EXISTING RACK. COORDINATE WORK WITH UAA IT PERSONNEL. REFER TO SECTION 272010 TELECOM DISTRIBUTION SYSTEM FOR ADDITIONAL INFORMATION.
11. EXISTING UNPOPULATED 2-POST TELECOM RACK - REMOVE AND RETURN TO OWNER. PATCH FLOOR TILES WHERE RACK WAS REMOVED.
12. EXISTING MILLENNIUM ACCESS CONTROL PANELS. RE-CIRCUIT TO B-30.
13. NEW PANEL B - REFER TO PANEL SCHEDULE AND POWER ONE-LINE DIAGRAM FOR MORE INFORMATION.

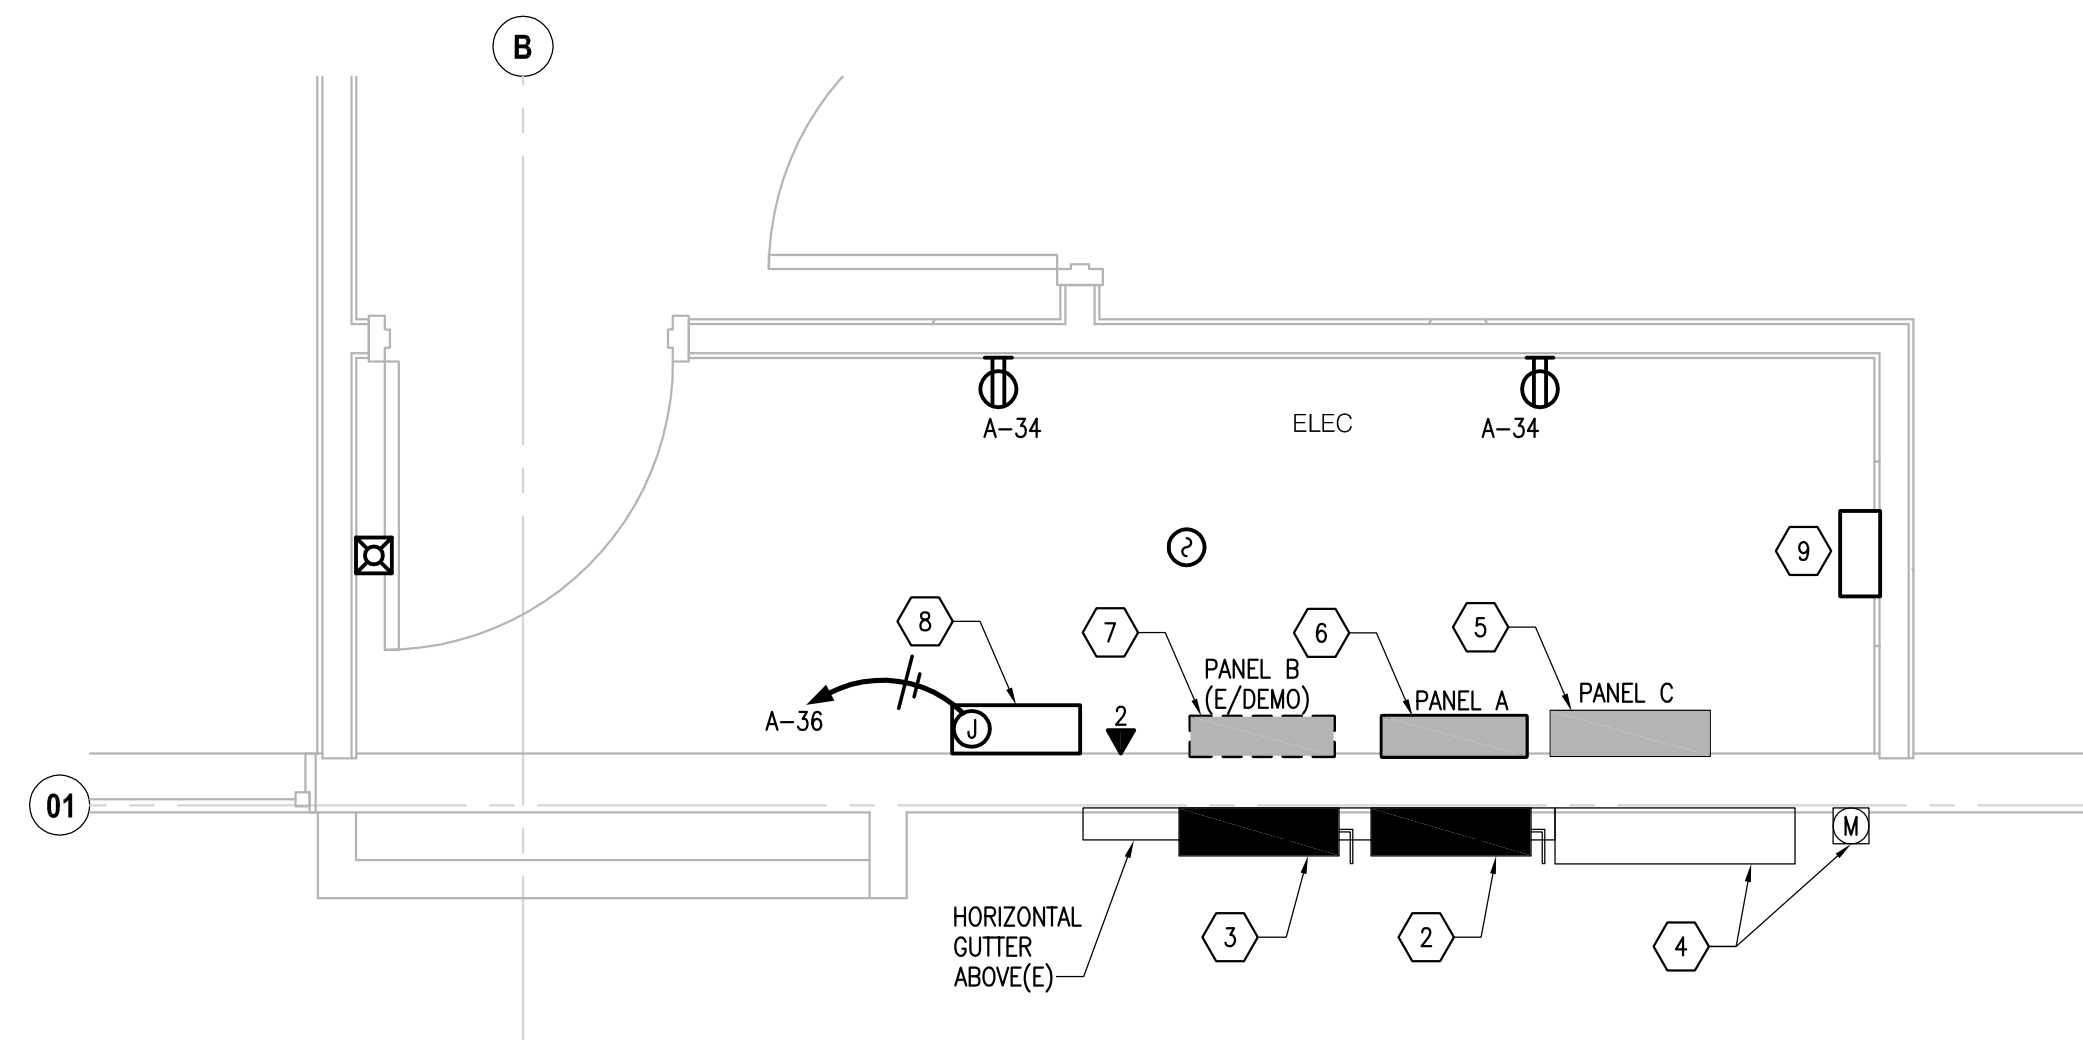

1 ENLARGED PLAN - ELECTRICAL ROOM
E401 SCALE: 1/2" = 1'-0"

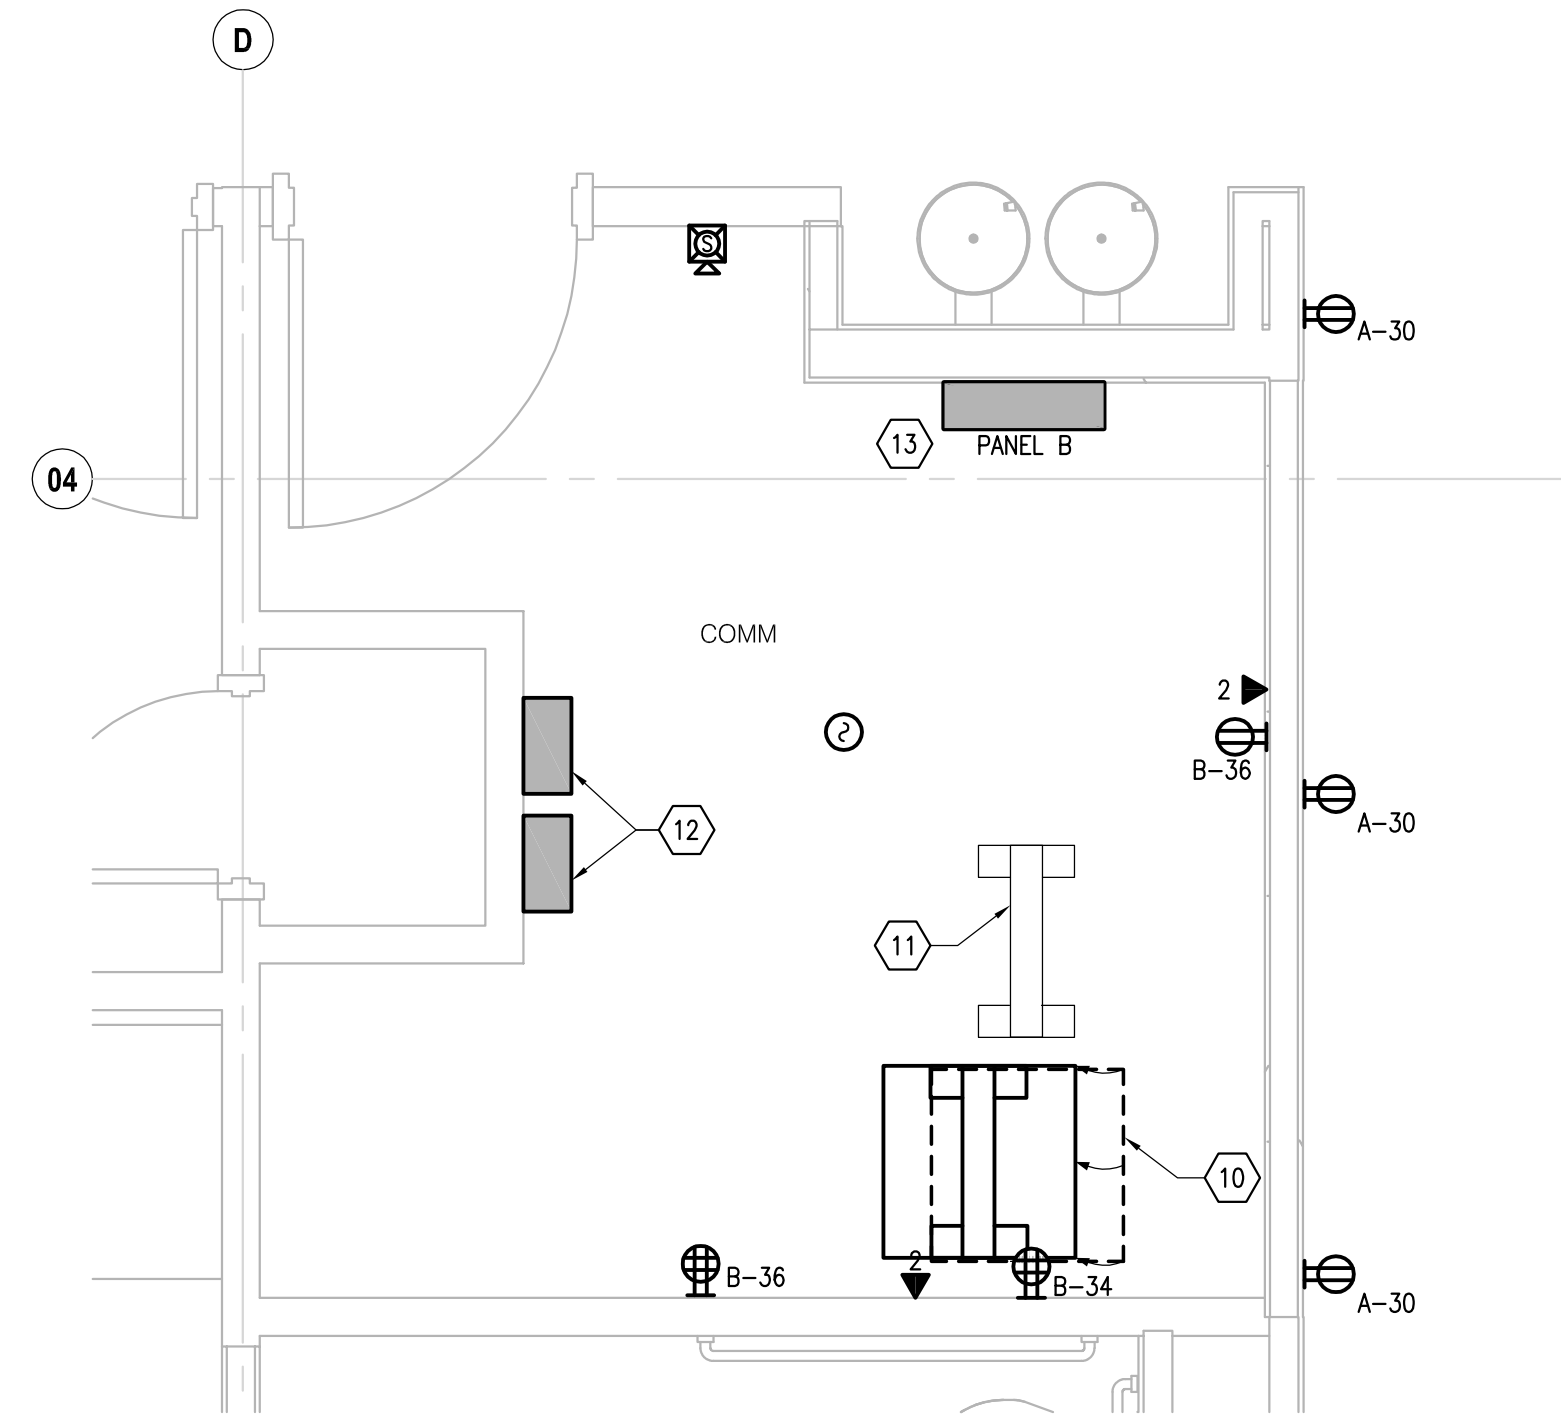

2 ENLARGED PLAN - COMM ROOM
E401 SCALE: 1/2" = 1'-0"

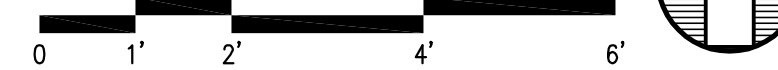

JAA ANSEP ULA RENOVATION
UNIVERSITY LAKE BUILDING -
BUILDING AO 107
UNIVERSITY OF ALASKA ANCHORAGE
ENLARGED PLANS - ELECTRICAL

PROJECT TITLE:
ADDRESS:
OWNER:
SHEET TITLE:

NO	DESCRIPTION	DATE

DATE : 2017.04.07
PROJECT NO : 17-0103
DRAWN BY : EJK/DRM/ERP
CHECKED BY : EJK/KAC
COPYRIGHT :

2015 RIM ARCHITECTS

DWG NO:
E401