

COMMUNITY BUILDING GENERATOR INSTALLATION

STATE OF ALASKA DEPARTMENT OF ADMINISTRATION **Division of General Services Facilities Section**

PO Box 11210 Juneau, AK 99811-0210 Brent Fagerstrom, Project Manager (907) 465-6877

ELECTRICAL ENGINEER

Haight & Associates, Inc.

Ben Haight, E.E., Principal

526 Main Street

(907) 586-9788

Juneau, AK 99801

CIVIL ENGINEER

SCOPE OF WORK SUMMARY

THE COMMUNITY BUILDING IS A DOWNTOWN JUNEAU OFFICE BUILDING COMPRISED OF THREE FLOORS AND A BASEMENT. THE BUILDING IS NATURALLY VENTILATED AND IS HEATED WITH AN OIL-FIRED BOILER LOCATED IN THE BASEMENT. PRIMARY ELECTRICAL DISTRIBUTION I

THE GENERATOR INSTALLATION SHALL TIE INTO THE EXISTING ELECTRICAL PANELS IN THE BASEMENT, AND AND SHALL INCLUDE ANY NECESSARY CABLING, CONDUIT, CIVIL AND FINISH WORK REQUIRED TO COMPLETE THE INSTALLATION.

CEILINGS AT BASEMENT MAY NEED TO BE REMOVED AND REINSTALLED AS A PART OF THE WORK. EXTERIOR CONCRETE EXPOSED TO VIEW DURING INSTALLATION THAT IS TO REMAIN EXPOSED TO VIEW SHALL BE CLEANED FAIRED, AND PAINTED TO MATCH BUILDING

THE CONSTRUCTION SHALL BE COMPLETED IN A SINGLE CONSTRUCTION PHASE AND COORDINATED W/OWNERS ONGOING USE OF THE BUILDING.

HAZARDOUS MATERIALS NOTES

Community Building basement has had all asbestos above the suspended ceiling removed and the above-ceiling space is

All original GWB walls in the building are Asbestos Containing Materials (ACMs). Thus, all penetrations in walls and ceilings will need to be done by certified people using appropriate methods. Likewise, all cuts in existing walls and ceilings (for removal of existing electrical), must be done by certified workers.

6205 Glacier Highway Juneau, AK 99801 (907) 780-6060 Mark Pusich, P.E. Principal

PDC, Inc.

SHEET INDEX

GENERAL

G0.1 TITLE SHEET / GENERAL INFO

ARCHITECTURAL A2.0 BASEMENT AND GENERATOR

- CIVIL EXISTING SITE CONDITIONS C1.0
- C2.0 SITE PLAN
- C3.0 SECTIONS AND DETAILS
- SITE SECTION C4.0

ELECTRICAL

- E0.1 LEGEND, SCHEDULE, DETAIL
- SITE PLAN EXISTING E1.0 **BASEMENT FLOOR PLAN - EXISTING** E1.1
- E2.0 SITE PLAN - NEW
- BASEMENT FLOOR PLAN NEW E2.1
- E2.2 SINGLE LINE DIAGRAM

MARCH 29, 2017

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ATTACHMENT NUMBER

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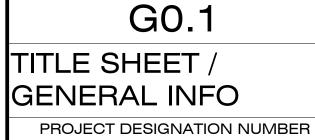
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-1" ACTUAL -----IF THE ABOVE DIMENSION DOES NOT MEASURE ONE INCH (1) EXACTLY, THIS DRAWING WILL HAVE BEEN ENLARGED C REDUCED, AFFECTING ALL LABELED SCALES.

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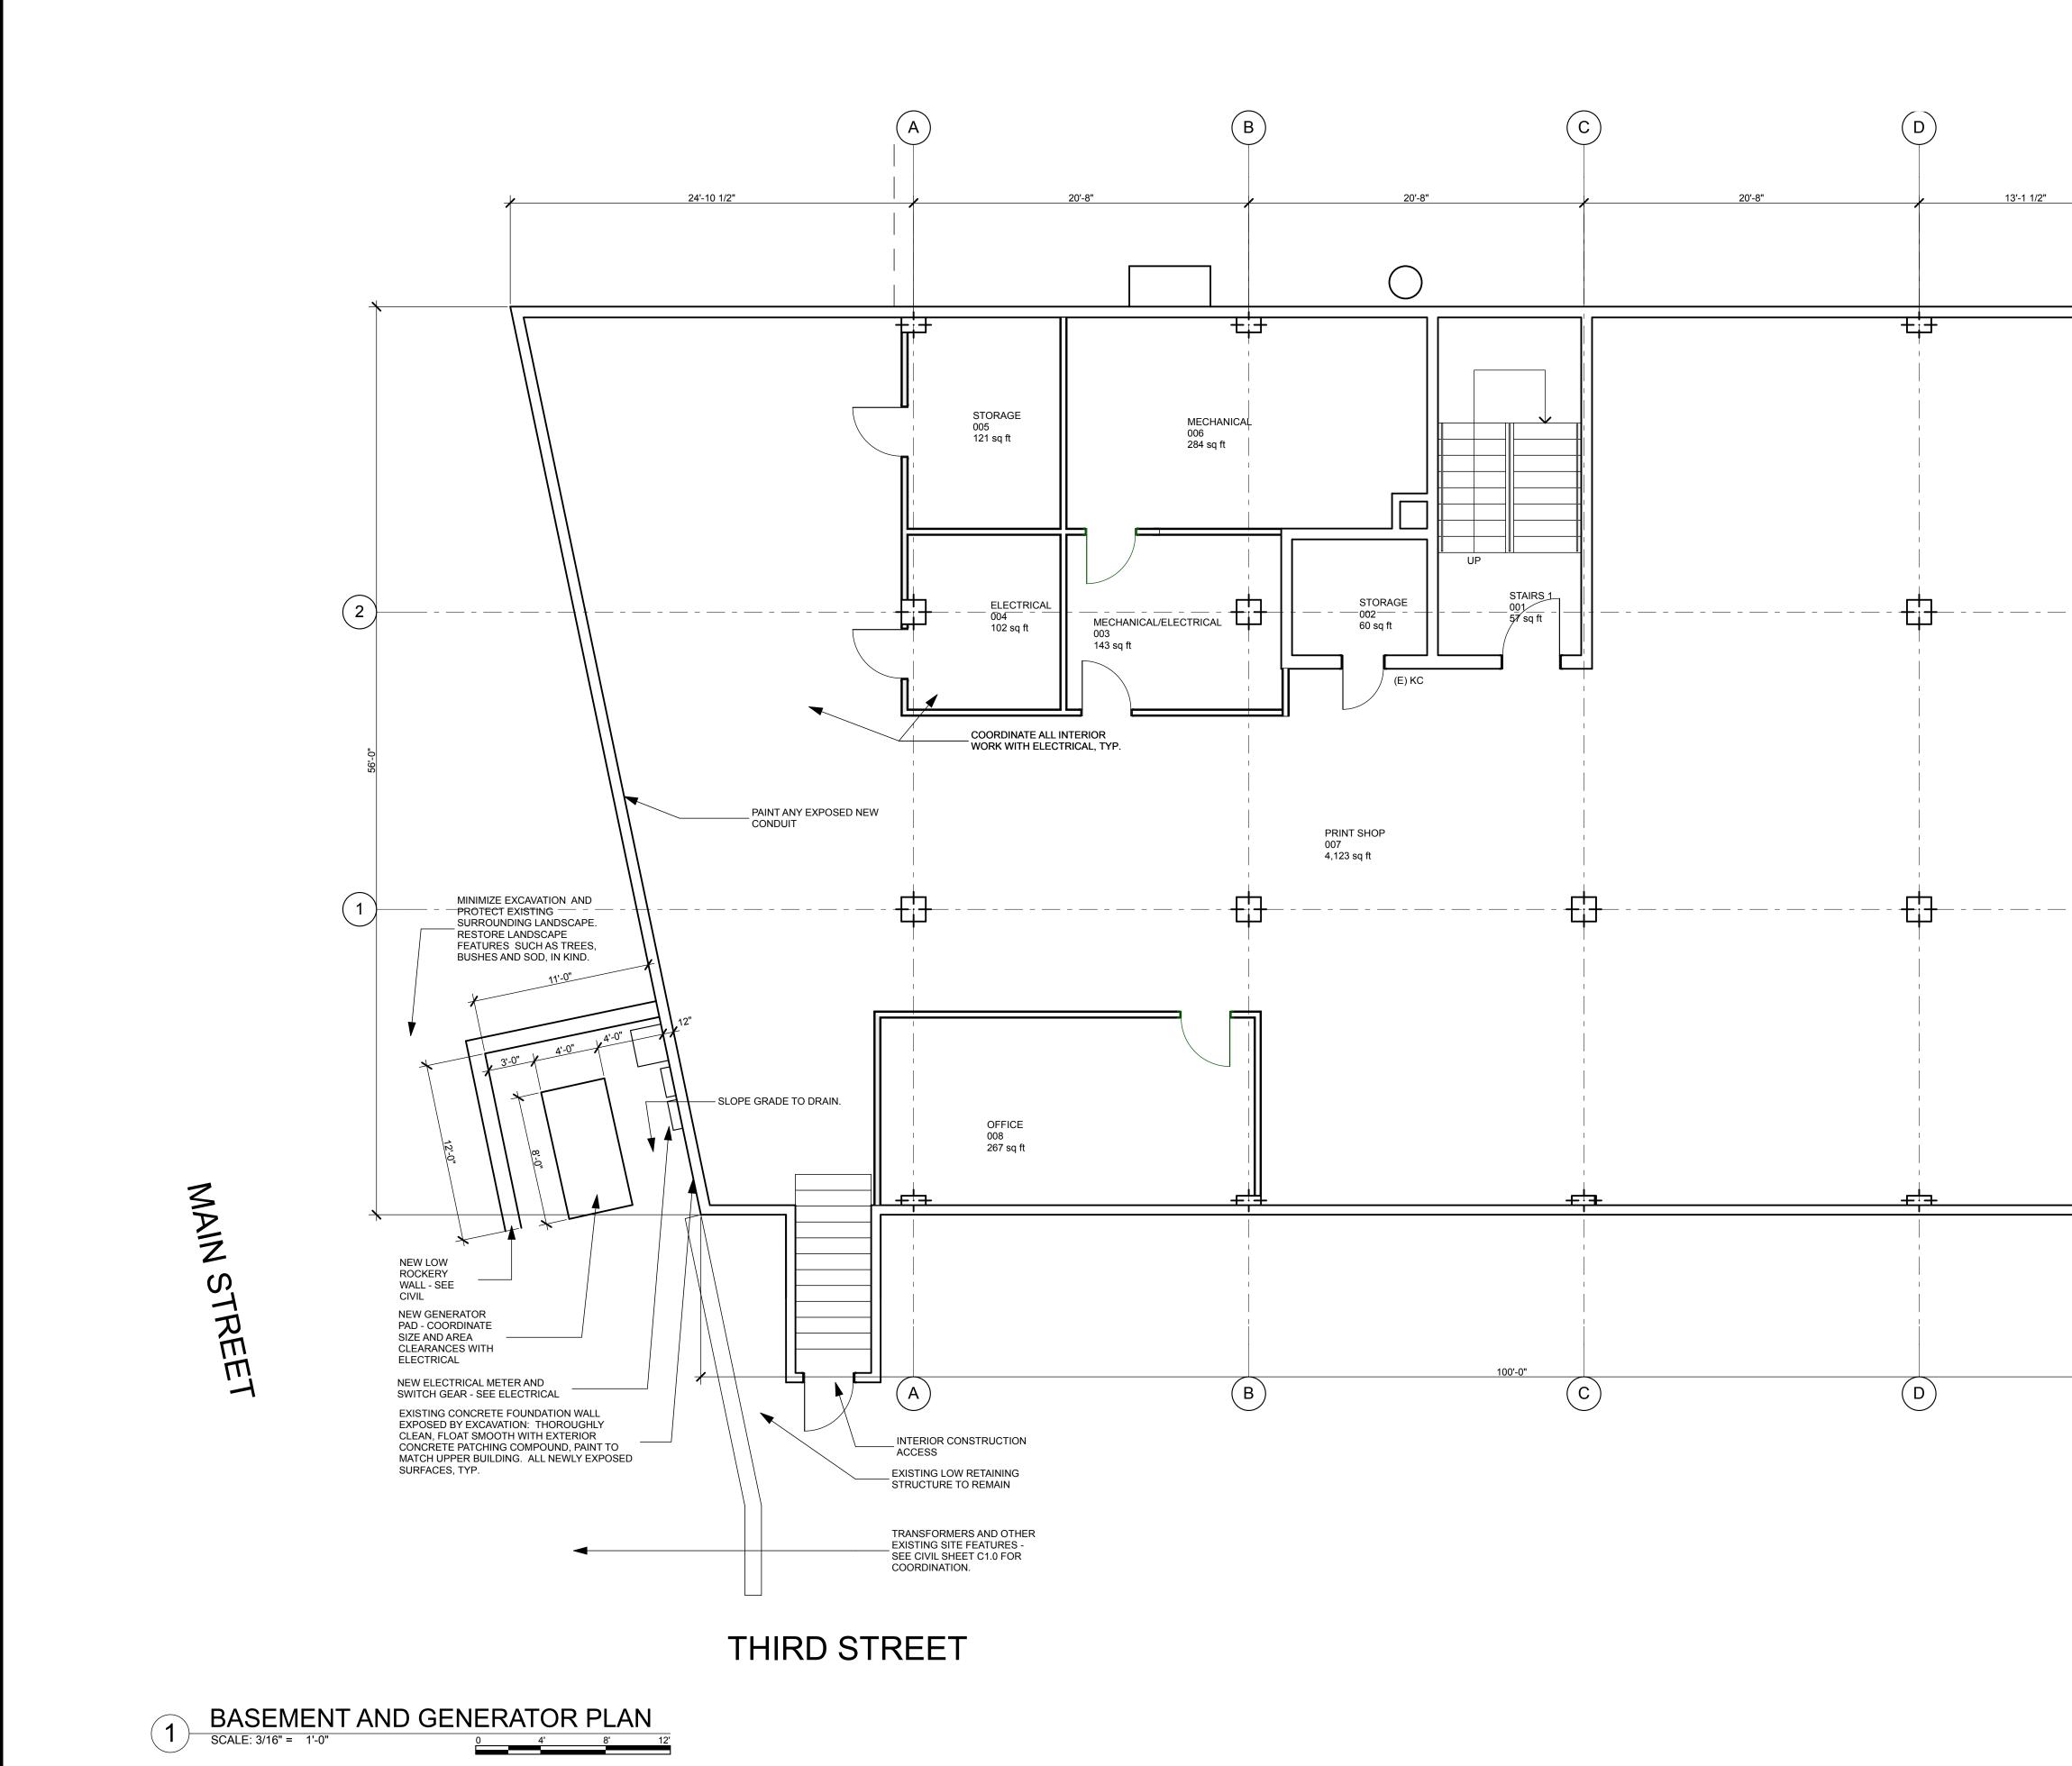
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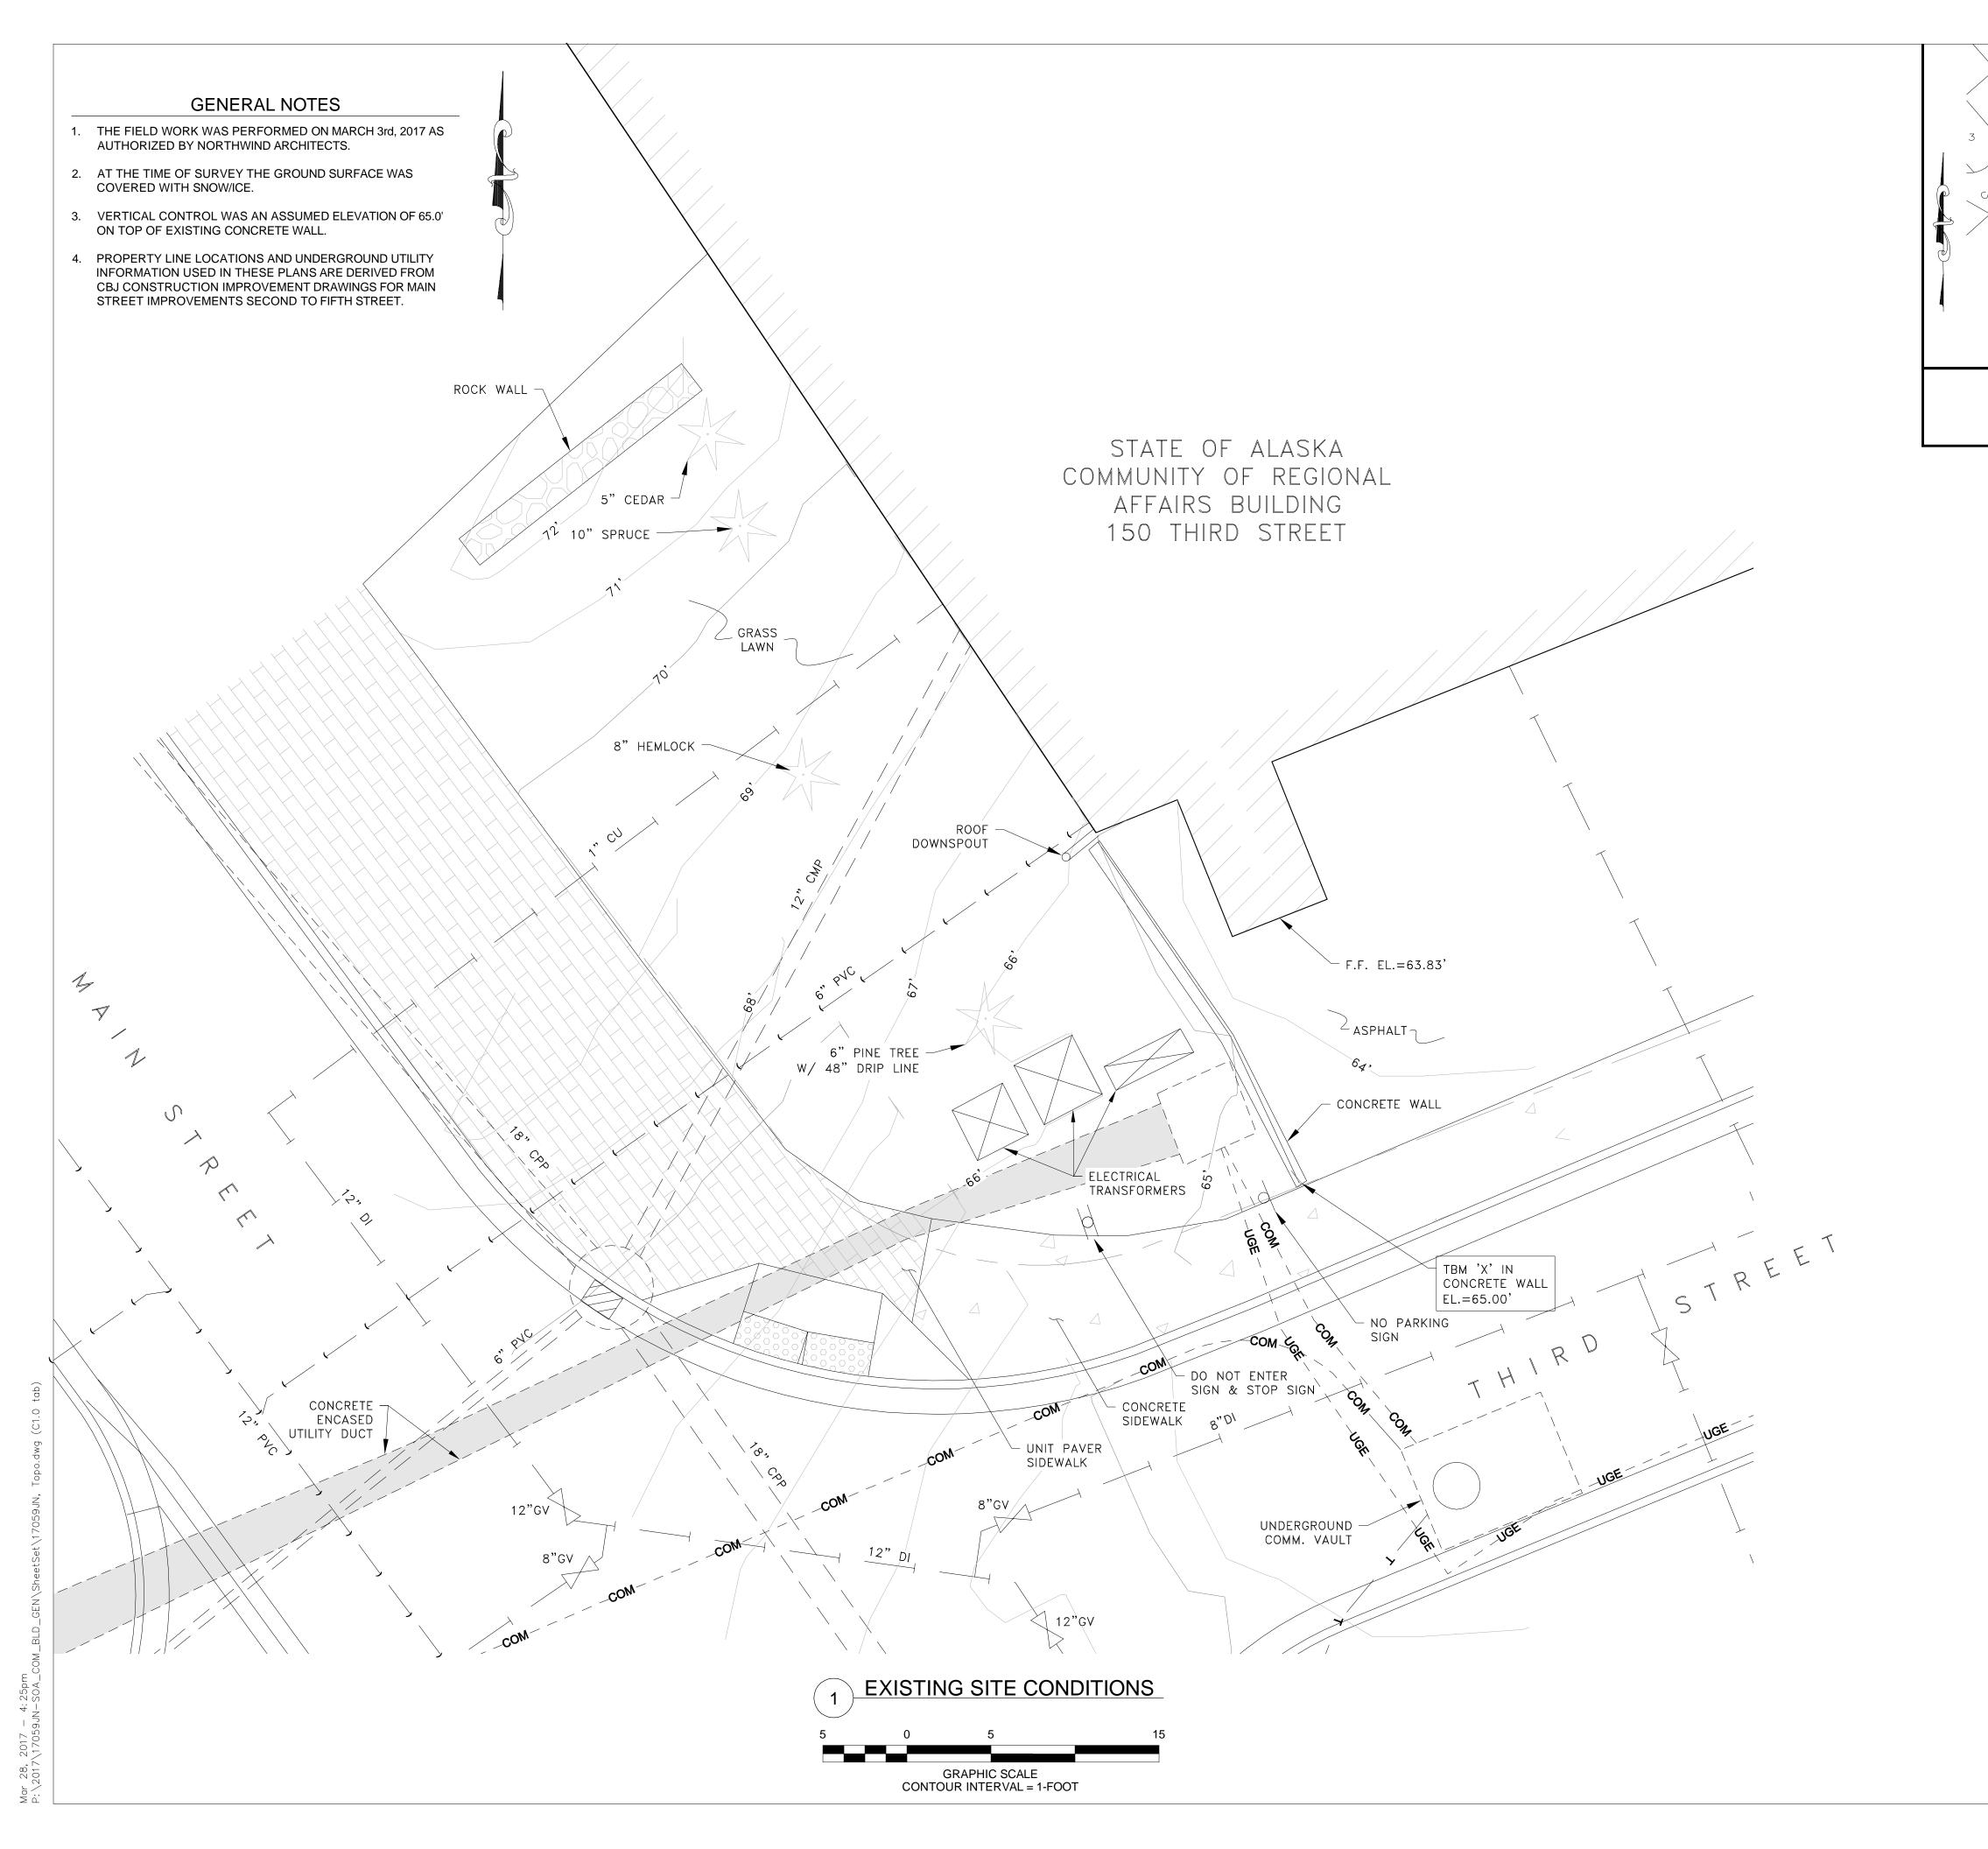
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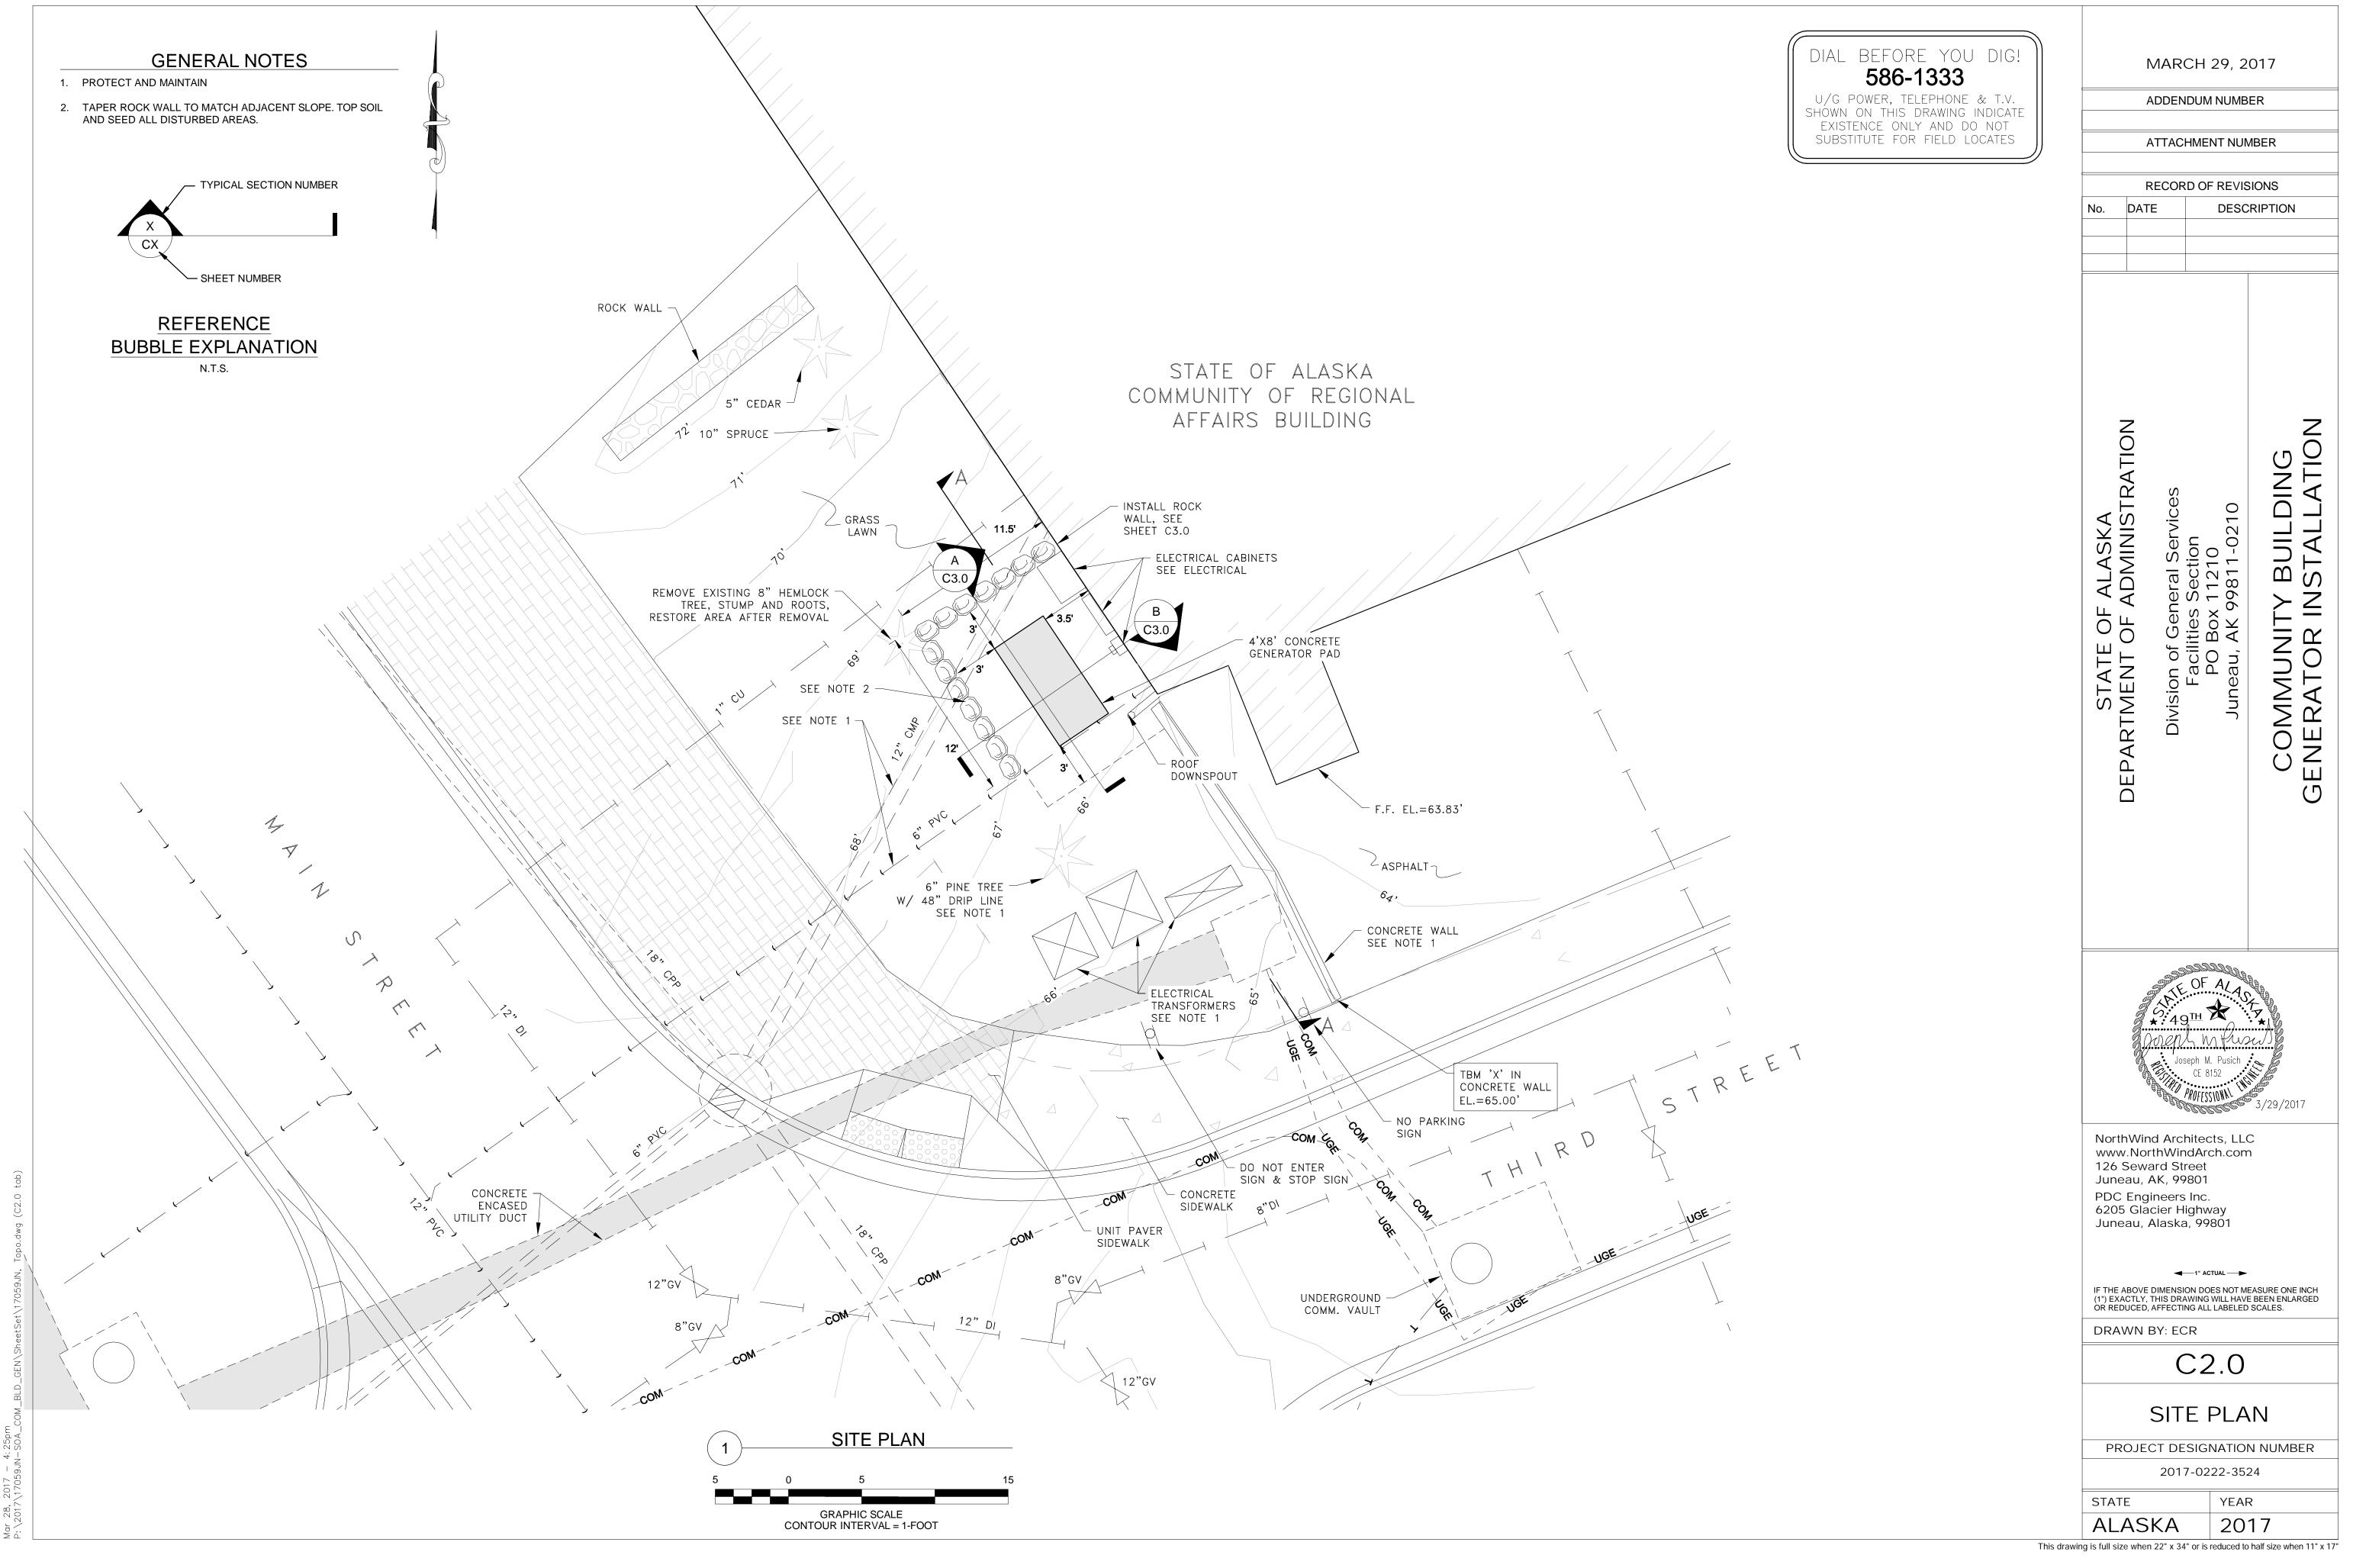
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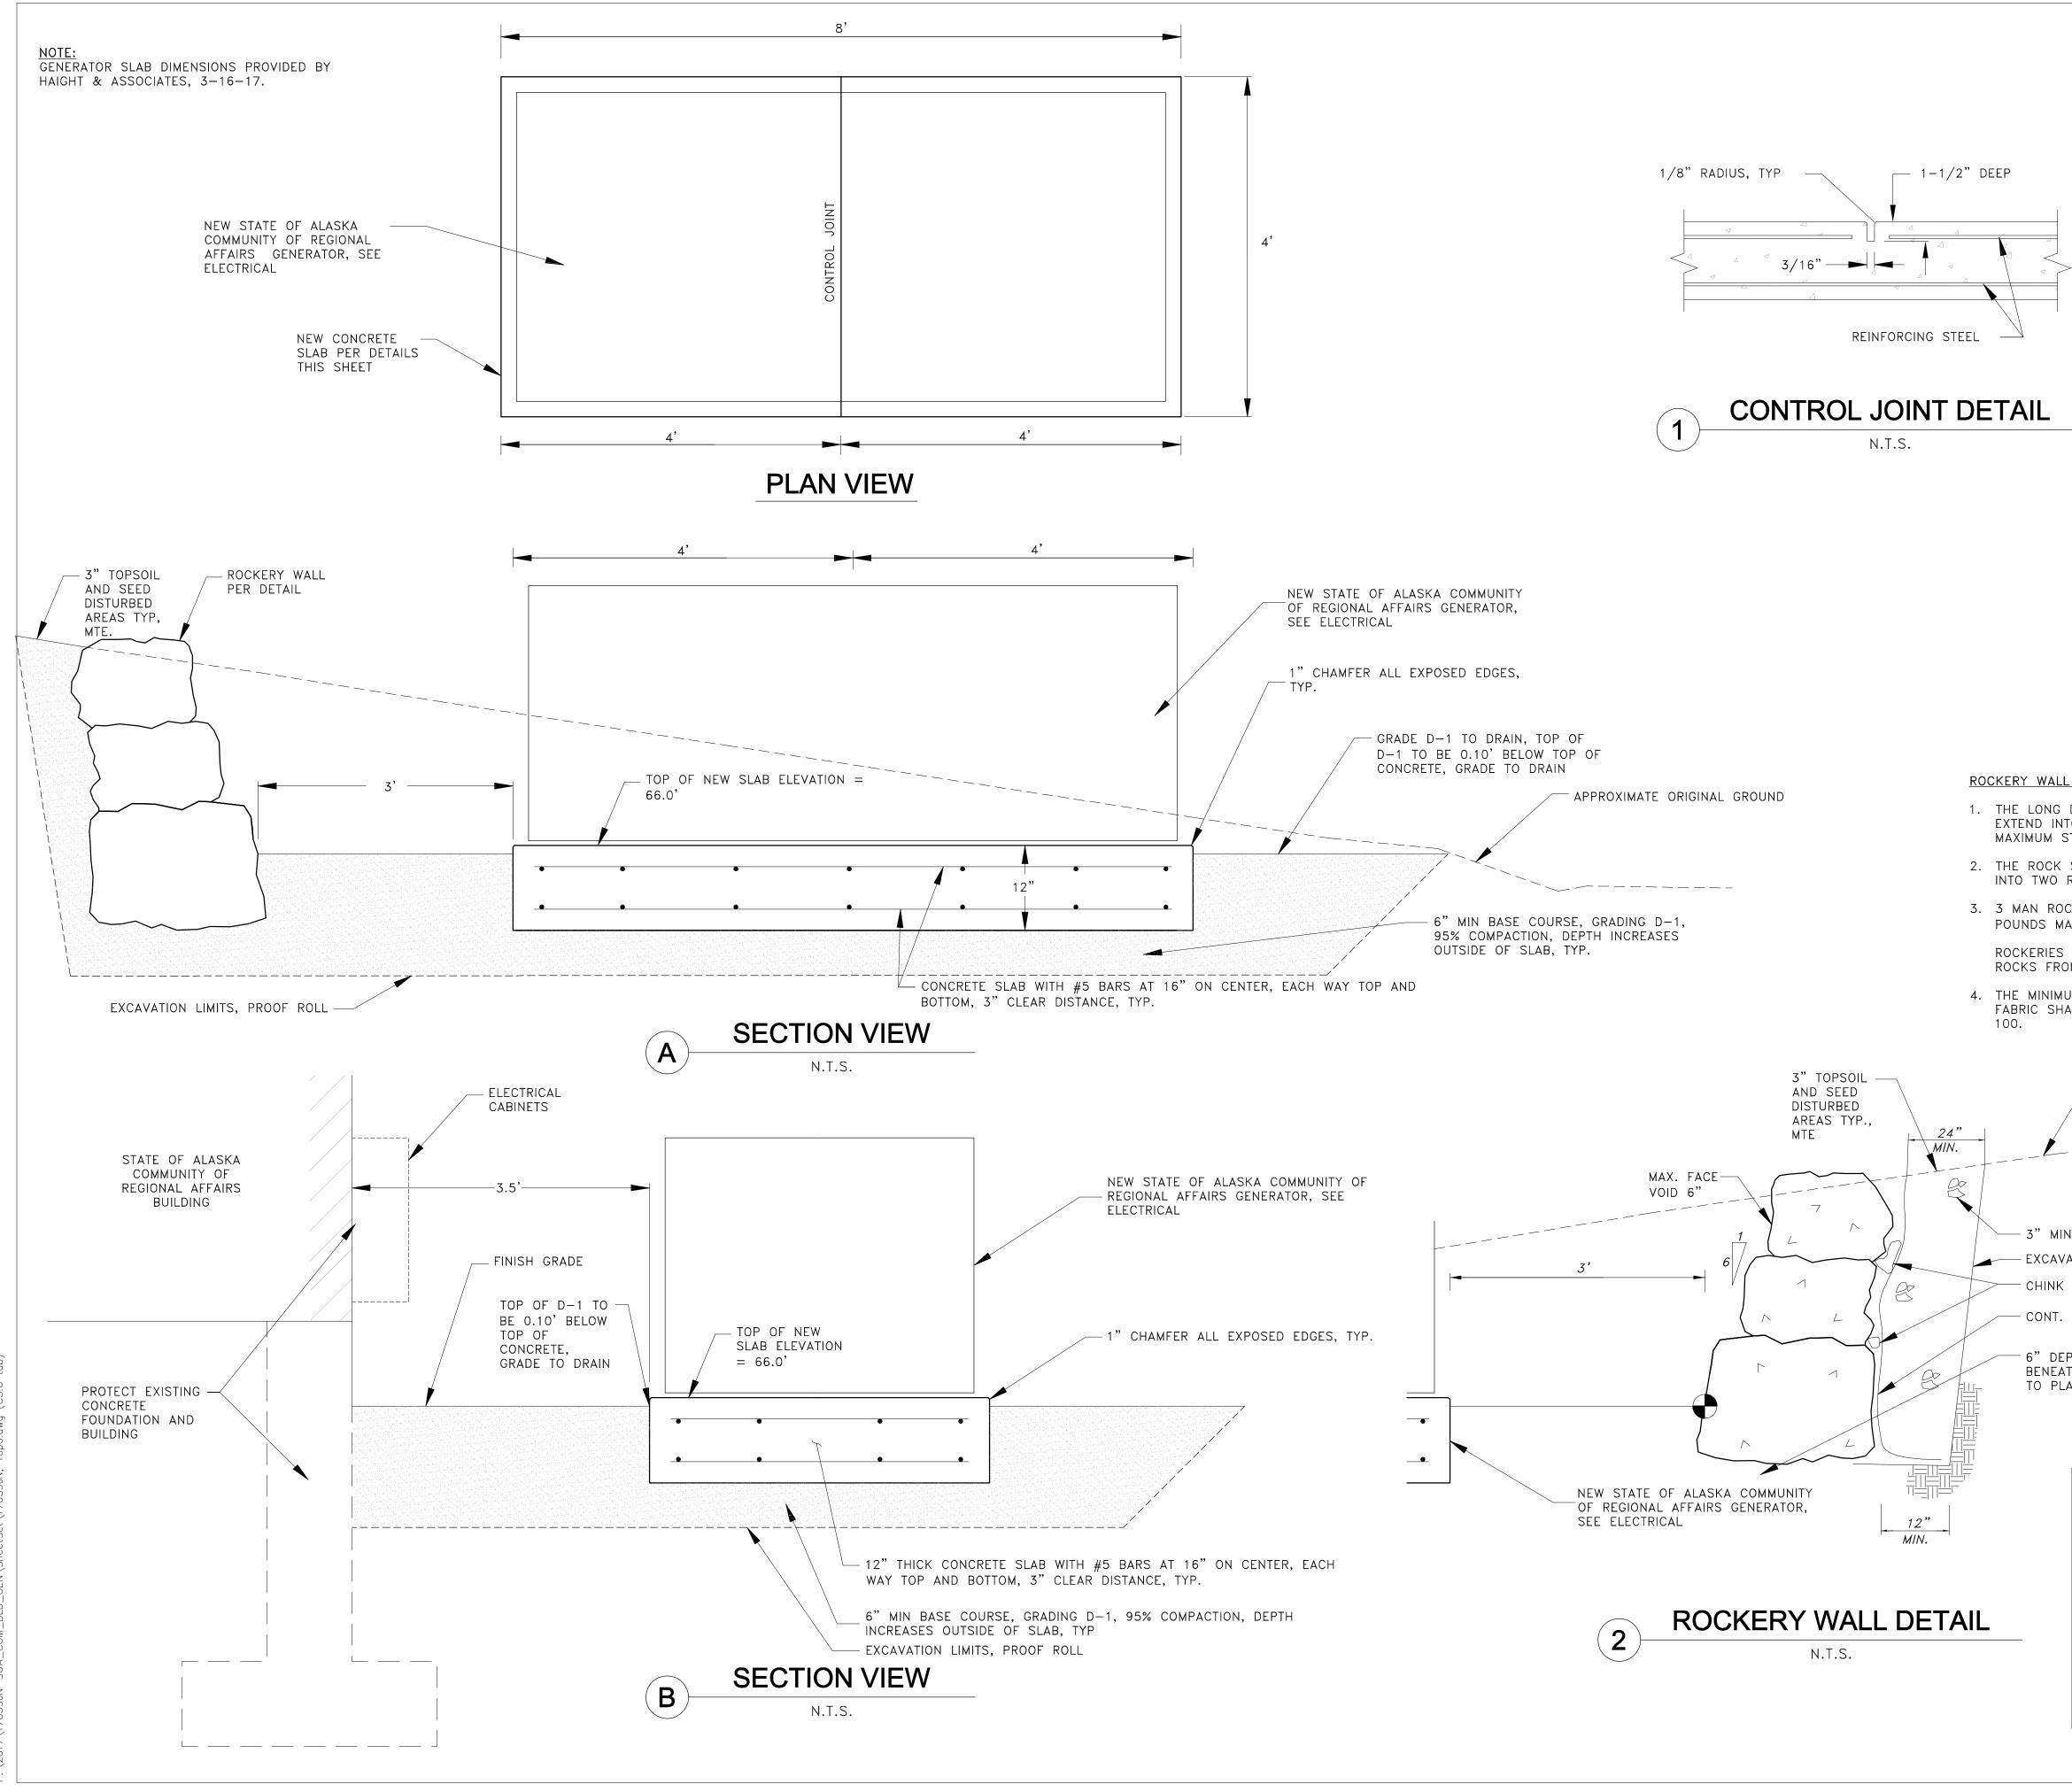


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SURVEY VICINIT SOURCE: CBJ PR 1"=10 SOURCE: CBJ PR 1"=10 LEEGE AF 10' CA 10'	DPERTY ATLAS DPERTY ATLAS DPROXIMATE PROPERTY LINE PROXIMATE PROPERTY LINE TORM DRAIN CULVERT DNTOUR LINE ATER LINE WER LINE VERHEAD ELECTRIC LINE NDERGROUND ELECTRIC LINE NDERGROUND ELECTRIC LINE NDERGROUND COMMUNICATION LINE DNCRETE CURB & GUTTER ECTRICAL TRANSFORMER REE ATER VALVE GN ETECTABLE WARNING TILE	TE OF	I UF A of Gene	Facilities Section PO Box 11210 Juneau, AK 99811-0210	COMMUNITY BUILDING GENERATOR INSTALLATION
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ROCKERY WALL NOTES:

- 1. THE LONG DIMENSION OF THE ROCKS SHALL EXTEND INTO THE EARTH TO PROVIDE MAXIMUM STABILITY.
- 2. THE ROCK SHALL BE PLACED SO AS TO LOCK INTO TWO ROCKS IN THE TIER.
- 3. 3 MAN ROCKS 800 POUNDS MIN., 1,500 POUNDS MAX., SIZED 18" TO 24" ROCKERIES SHALL BE CONSTRUCTED OF 3 MAN ROCKS FROM BOTTOM TO TOP.
- 4. THE MINIMUM SIZE OPENINGS IN THE FILTER FABRIC SHALL BE U.S. STANDARD SIEVE NO.

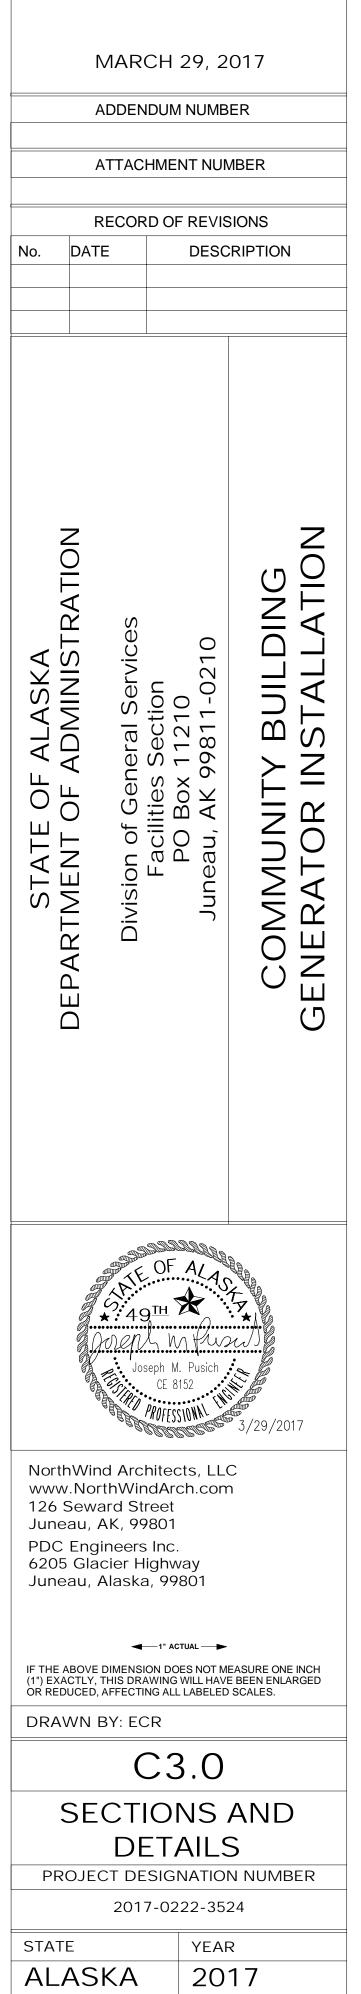
ORIGINAL GROUND

— 3" MINUS SHOTROCK COMPACTED TO 95% EXCAVATION LIMITS - CHINK ALL VOIDS 6" OR GREATER

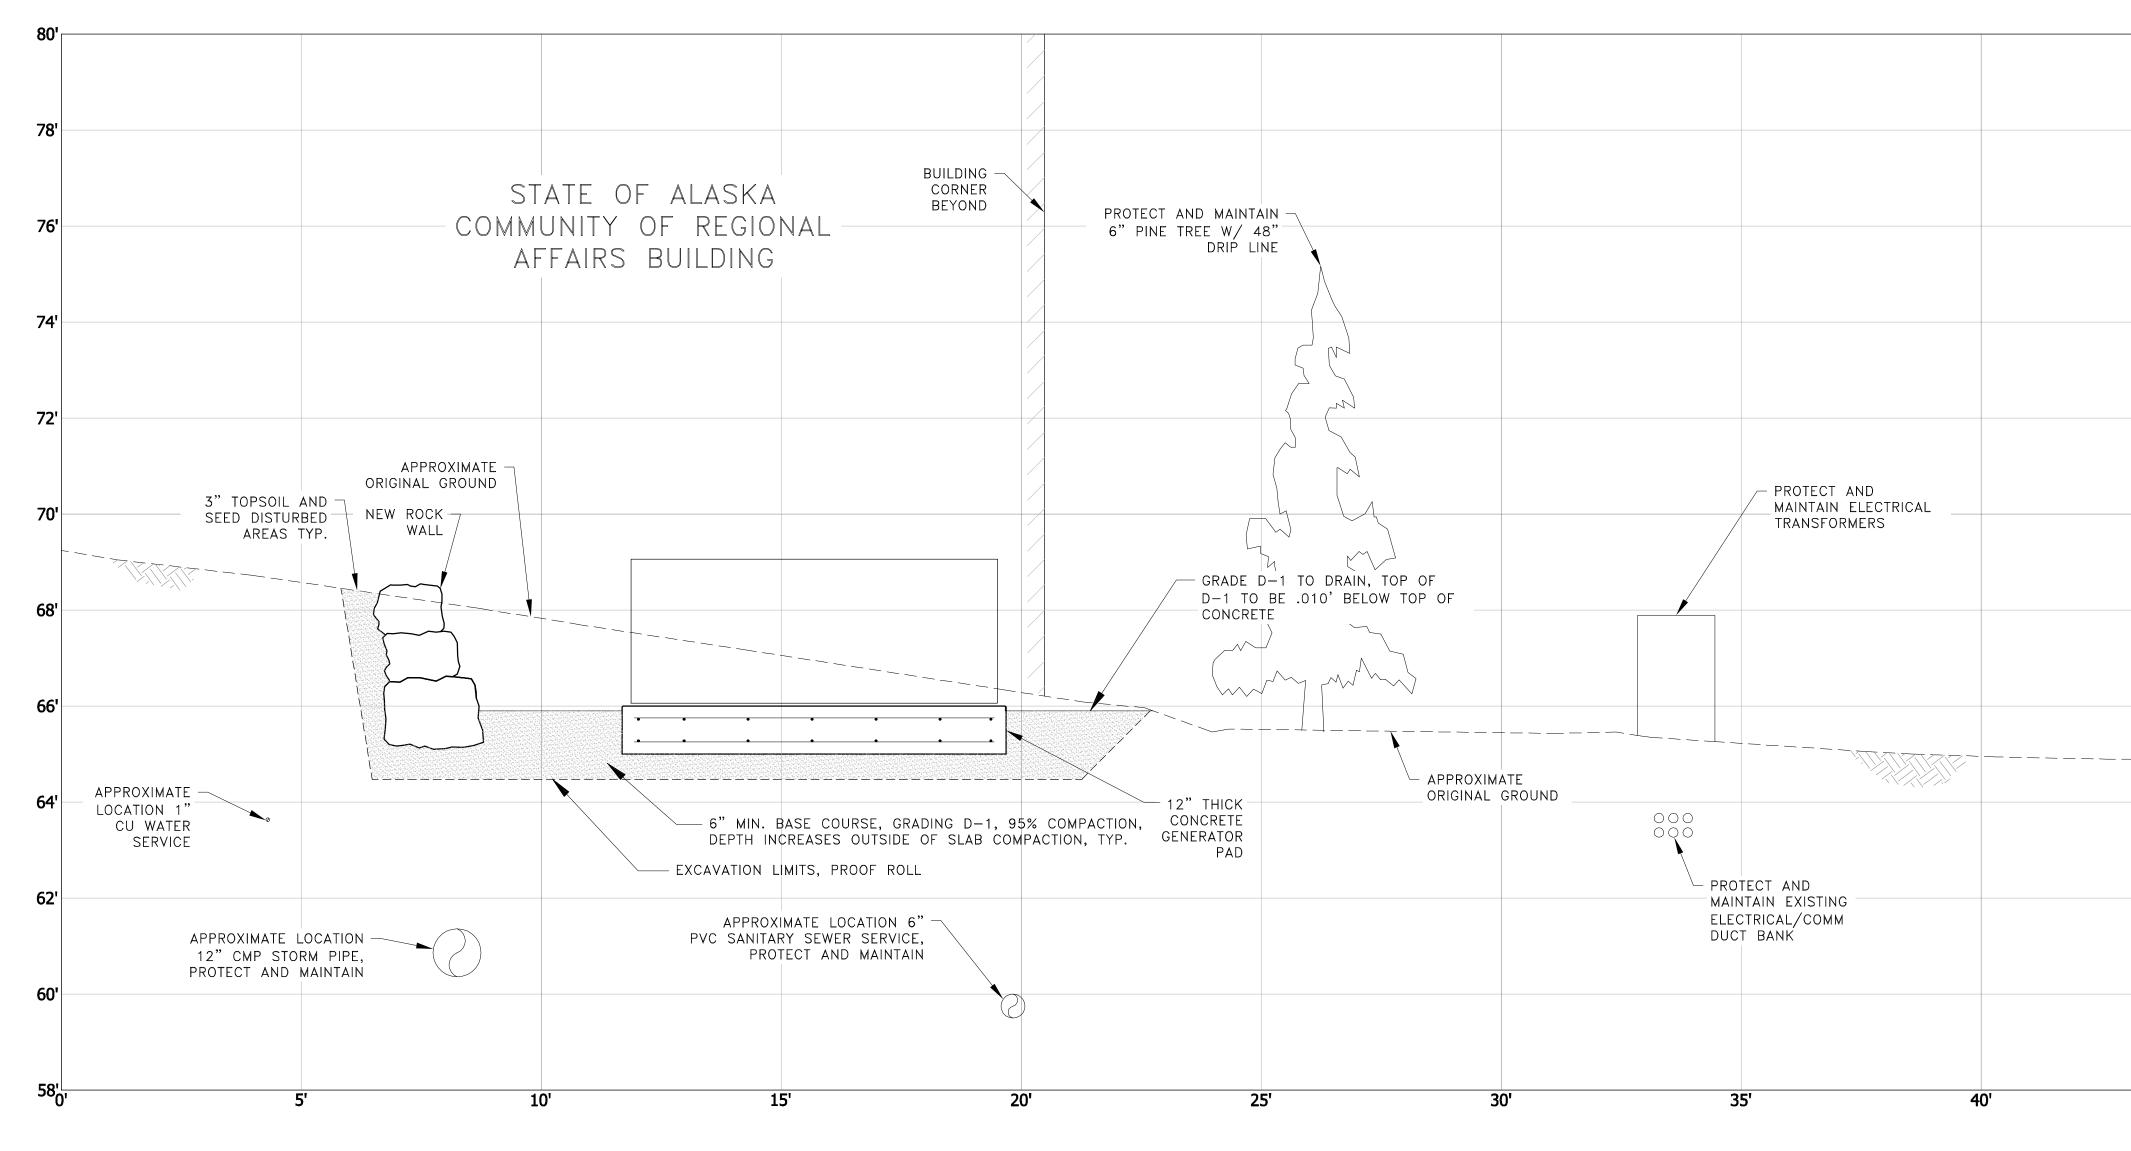
- CONT. CBJ FILTER CLOTH, TYPE A

6" DEPTH BASE COURSE GRADING D-1, BENEATH BOTTOM ROCK, PROOF ROLL PRIOR TO PLACING D-1

SPECIFICATIONS FOR 3" MINUS FILTER ROCK					
3" MINUS SHOT ROCK	PERCENT PASSING				
3"	90% TO 100%				
2"	40% TO 60%				
3/4"	30% TO 50%				
#4	10% TO 30%				
#100	0% TO 10%				
#200	0% TO 5%				



This drawing is full size when 22" x 34" or is reduced to half size when 11" x 17"



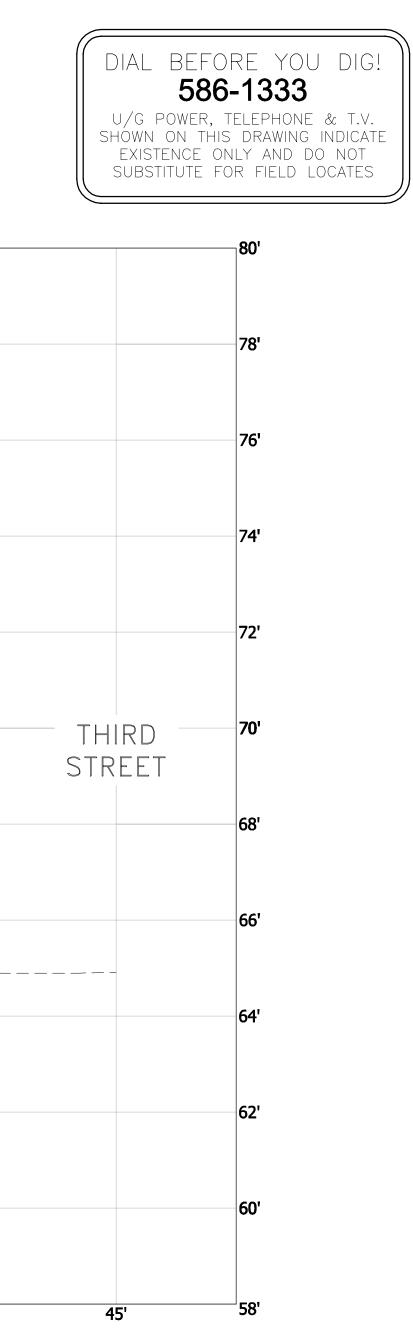
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WA-1148.68 Community Building General

SECTION 'A-A'

GRAPHIC SCALE SCALE: HORIZONTAL/VERTICAL - 1" = 2' @ FULL SIZE



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	PANEL B	SIZE		VOLTS			MAIN		MOUNT	
		100 AM	100 AMPS		120/240V, 1 PH		LUGS ON	NLY BASEMENT	SURFACE	
°ĸ_	DESCRIPTION	BREAKER AMP/		K١	/A		BREAKER	DESCRIPTION		с К
NO	DESCRIPTION	POLÉ	СКТ	T AØ BØ		б скт	POLÉ	DESCRIPTION		
1	CORRIDOR	20/1	0.0	0.0		0.0	20/1	PRINT SHOP	Φ	2
3	LIGHTING	20/1	0.0		0.0	0.0	20/1	LIGHTING		4
5	BOILER ROOM	20/1	0.0	0.0		0.0	20/1	PRINT SHOP	φ	6
7	BOILER ROOM	20/1	0.0		0.0	0.0	20/1	PHOTO ROOM		8
9	BOILER ROOM	20/1	0.0	0.0		0.0	20/1	PHOTO ROOM LIGHTING		10
11	PHOTO WALL	20/1	0.0		0.0	0.0	20/1	DARK ROOM		12
13	LIGHTING	20/1	0.0	0.0		0.0	20/1	PRINT SHOP	Ø	14
15	LIGHTING	20/1	0.0		0.7	0.7	20/1	GENERATOR	Φ	16
17	LIGHTING	20/1	0.0	0.1		0.1	20/1	GENERATOR LIGHTING		18
19	SPACE		0.0		1.2	1.2	20/1	GENERATOR - BATTERY CHARGER		20
21			0.0	0.8		0.8	15/2	GENERATOR - HEATER		22
23			0.0		0.8	0.8				24
25			0.0	0.0		0.0		SPACE		26
27			0.0		0.0	0.0				28
29			0.0	0.0		0.0				30
TOT	TAL CONNECTED LOAD: 3.6 KVA / 15.0 AMPS			0.9	2.7					

LEGEND

ABBREVIATIONS:

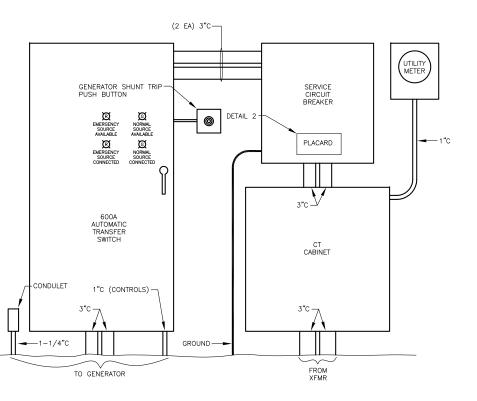
AFG	ABOVE FINISHED GRADE
ATS	AUTOMATIC TRANSFER SWITCH
EMT	ELECTRICAL METALLIC TUBING
GFI	GROUND FAULT INTERRUPTED
HDG	HOT-DIPPED GALVANIZED
PVC	POLYVINYL CHLORIDE CONDUIT
RSC	RIGID STEEL CONDUIT
UGE	UNDERGROUND ELECTRICAL
UON	UNLESS OTHERWISE NOTED
XFMR	TRANSFORMER

SHEET NOTE SYMBOLS:

E	EXISTING TO REMAIN
$\langle N \rangle$	NEW
$\langle X \rangle$	REMOVE EXISTING

SERVICE EQUIPMENT:

Т	TRANSFORMER
	PANELBOARD
77772	MAIN DISTRIBUTION PANEL
	UTILITY METER



ELEVATION - SERVICE EQUIPMENT (1)

120-240V SERVICE DISCONNECT 208Y/120V SERVICE DISCONNECT LOCATED IN BASEMENT ELECTRICAL ROOM

2 DETAIL - PLACARD

NO SCALE

DIAGRAM	SYMBOLS:
000	AUTOMATIC TRA
<u> </u>	CIRCUIT BREAKE
\odot	GENERATOR
\bigtriangledown	GROUND BUS
<u>+</u>	GROUND ROD
M	METER
	TERMINAL BLOC
8	CURRENT TRANS
	TRANSFORMER

AUTOMATIC TRANSFER SWITCH
CIRCUIT BREAKER
GENERATOR
GROUND BUS
GROUND ROD
METER
TERMINAL BLOCK
CURRENT TRANSFORMER
TRANSFORMER

POWER:

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CONDULET OR CONDUIT BODY

CONDUIT & CONDUCTORS:

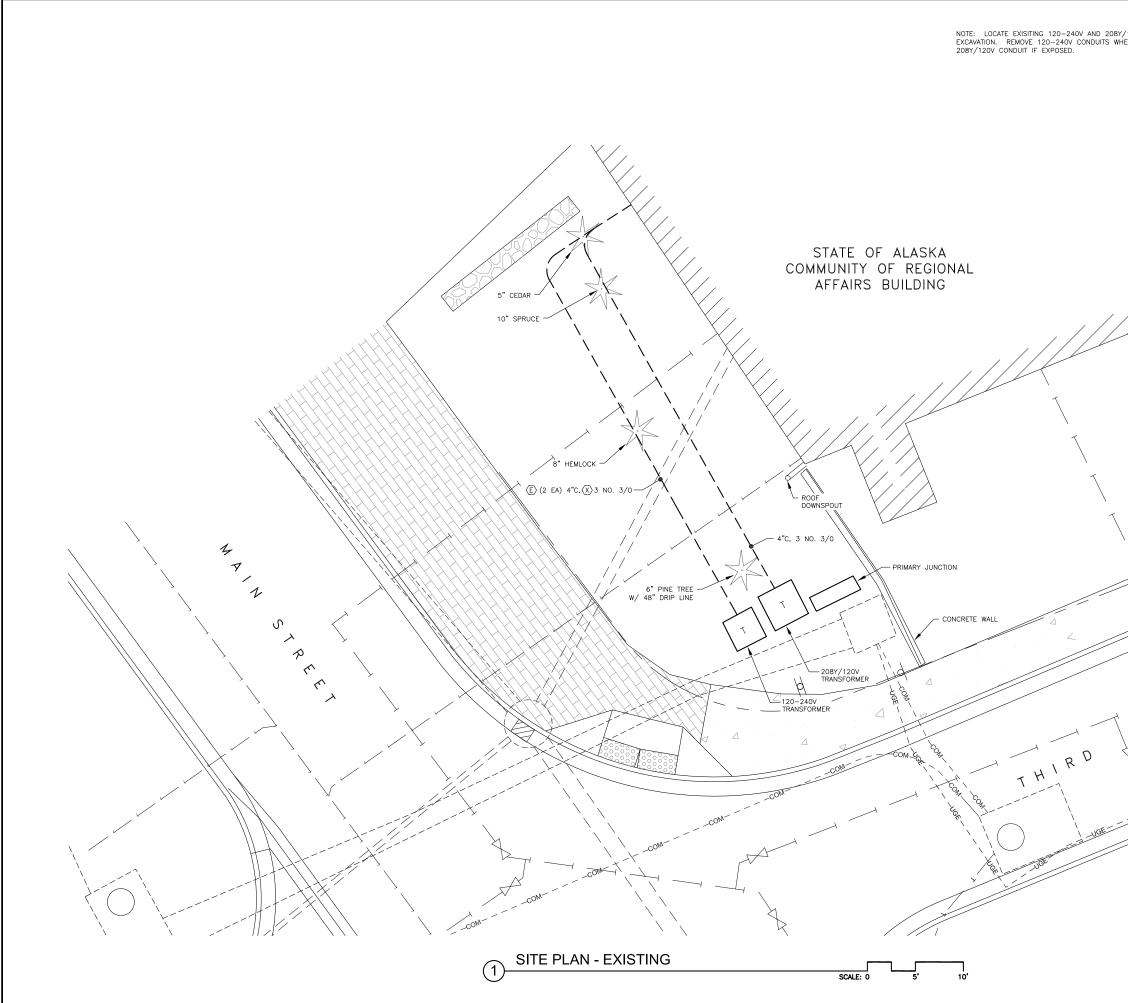
----- CONDUIT IN FLOOR OR UNDERGROUND

NO SCALE

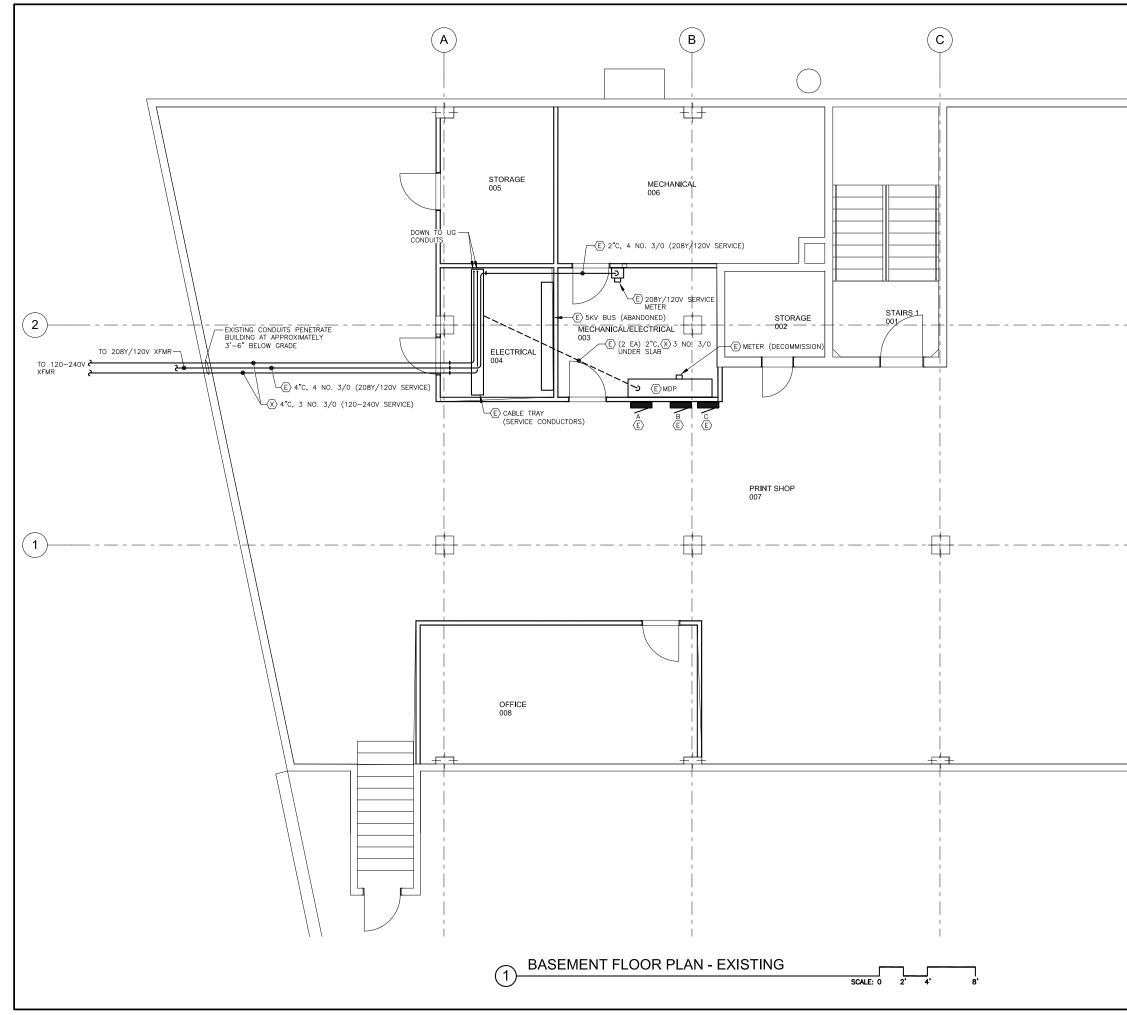
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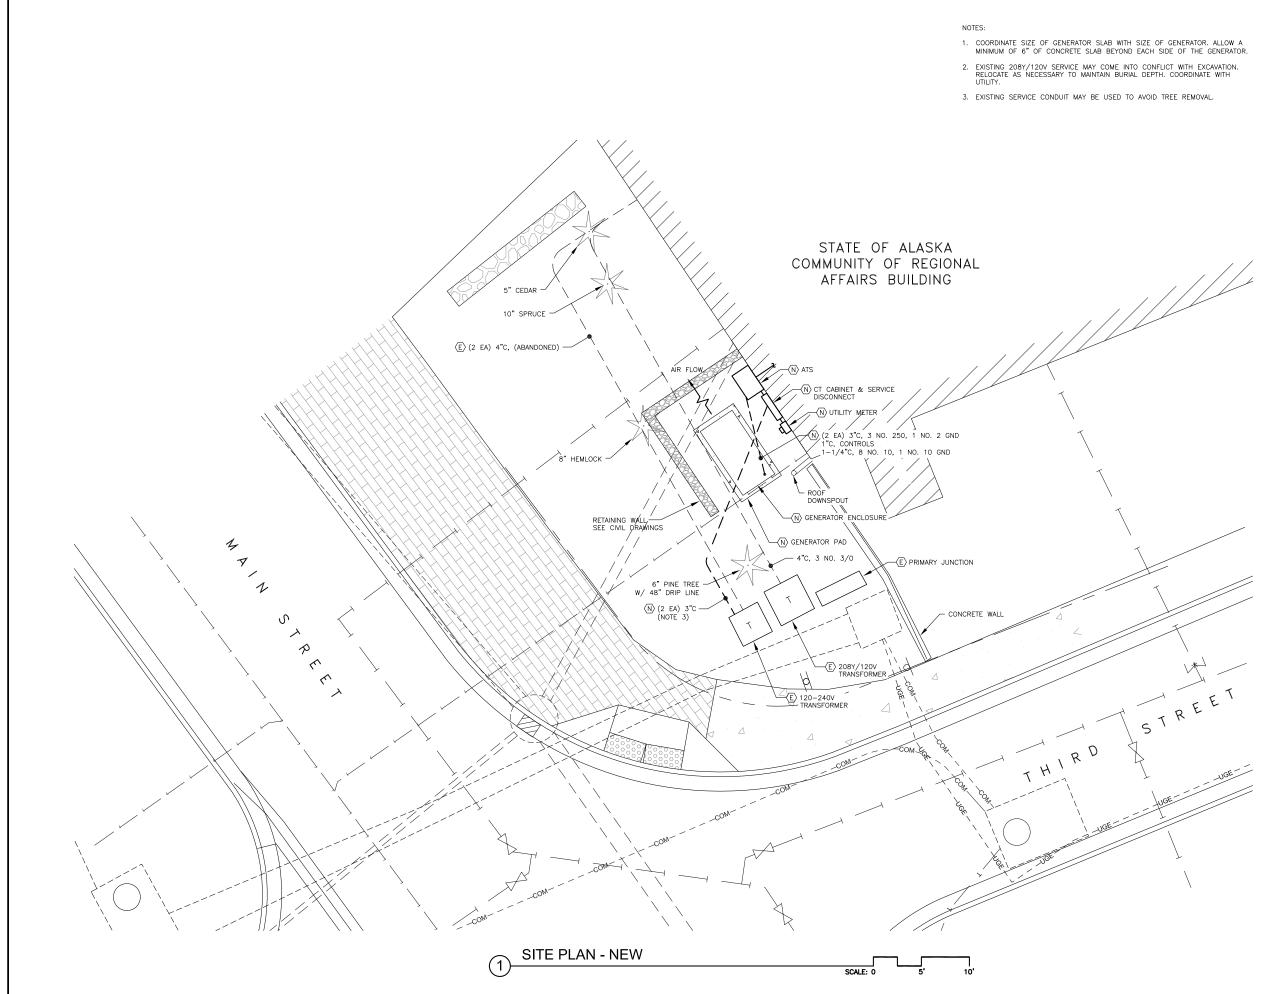
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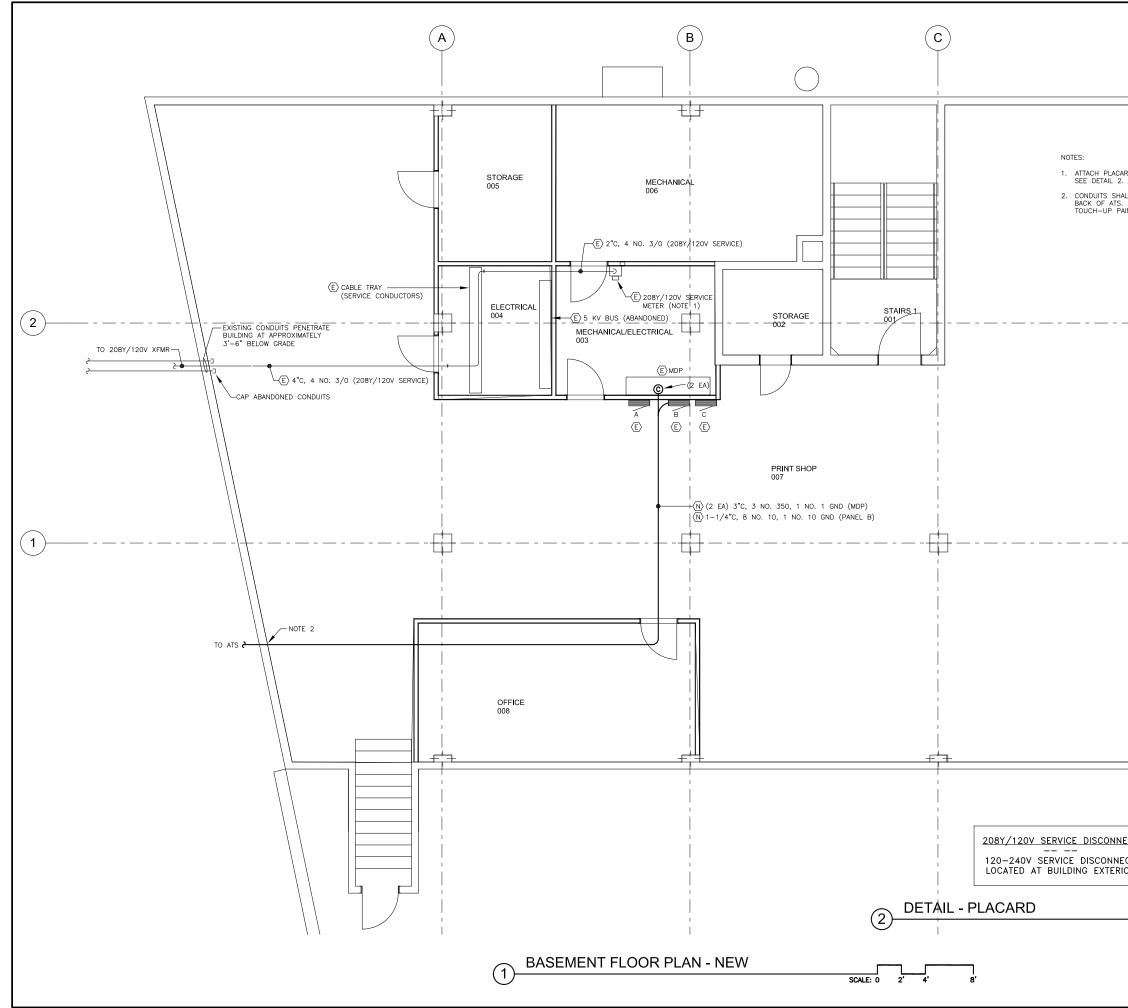
208Y/120V SERVICE CONDUITS BEFORE S WHERE/IF EXPOSED. REROUTE	, , , , ,	MARCH 29, 2017 ADDENDUM NUMBER ATTACHMENT NUMBER RECORD OF REVISIONS No. DATE DESCRIPTION Image: Construct of the second of				
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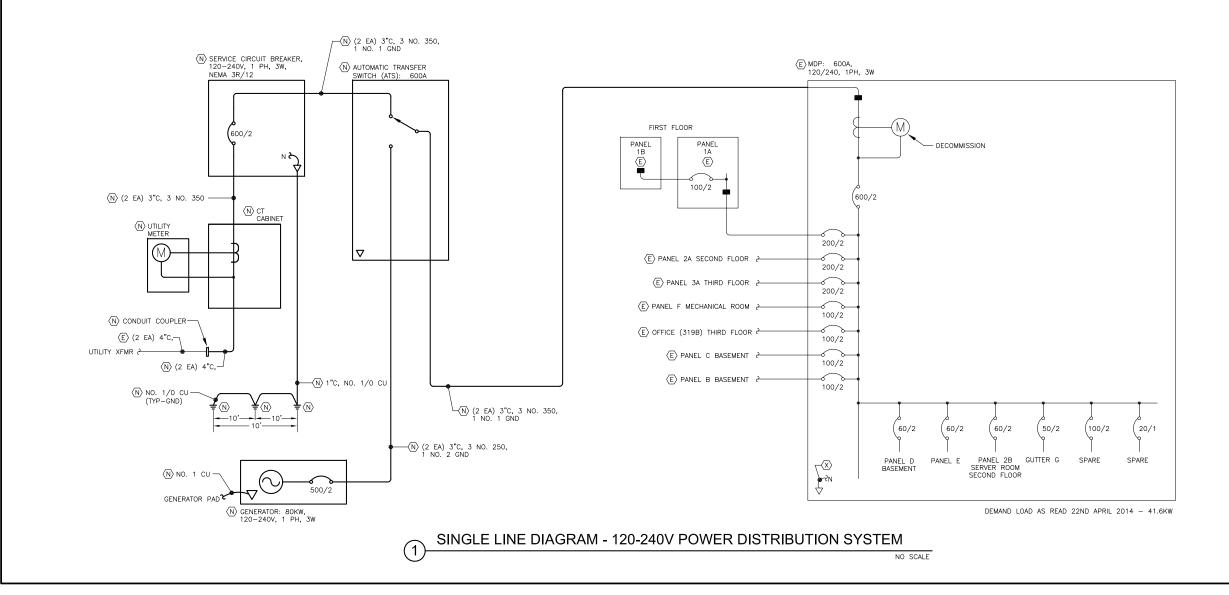
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DRAWN BY: PEL E1.1 BASEMENT FLOOR PLAN - EXISTING PROJECT DESIGNATION NUMBER 2017-0222-3524 STATE YEAR ALASKA 2017		



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CARD TO FRONT OF 208Y/120V SERVICE METER. 2.				
HALL PENETRATE BUILDING EXTERIOR WALL INTO S. SEAL PENETRATION WITH GROUT. PROVIDE PAINT.				
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